

Office of **Energy Projects July 2017**

FERC/FEIS-0275F

FINAL ENVIRONMENTAL IMPACT STATEMENT **FOR**

Columbia Gas Transmission, LLC – Mountaineer XPress Project Columbia Gulf Transmission, LLC - Gulf XPress Project



Federal Energy Regulatory Commission Office of Energy Projects 888 First Street, NE, Washington, DC 20426

Cooperating Agencies:











Final Environmental Impact Statement

Volume II – Appendices

Appendix A	Final EIS Distribution List
Appendix B-1	Mapping and Construction Drawings for the Mountaineer XPress Project
Appendix B-2	Mapping Drawings for the Gulf XPress Project
Appendix C	Typical Construction Right-of-way Configurations
Appendix D-1	Columbia Gas' Environmental Construction Standards (April 2017)
Appendix D-2	Columbia Gulf's Environmental Construction Standards (April 2017)
Appendix E-1	ATWS for the Mountaineer XPress Project Located within 50 feet of Wetlands and Waterbodies and Deviations from FERC's Plan and Procedures
Appendix E-2	Temporary Workspace for the Gulf XPress Project Located within 50 feet of Wetlands and Waterbodies and Deviations from FERC's Plan and Procedures
Appendix F	Access Roads for the Mountaineer XPress Project
Appendix G	Columbia Gas' HDD Inadvertent Return Contingency Plan for the Kanawha River HDD Crossing
Appendix H	Unexpected Contamination Discovery Plan
Appendix I	Core Forest Area Mapping for the Mountaineer XPress Project
Appendix J-1	MSHCP Interagency ESA Consultation Checklist for the Mountaineer XPress Project
Appendix J-2	MSHCP Interagency ESA Consultation Checklist for the Gulf XPress Project
Appendix K	State Protected Species List for the Gulf XPress Project
Appendix L	List of ATWS for the Mountaineer XPress Project
Appendix M-1	Viewshed Analysis for New Compressor Stations Associated with the Mountaineer XPress Project
Appendix M-2	Viewshed Analysis for Facilities Associated with the Gulf XPress Project
Appendix N-1	Noise Sensitive Areas Associated with the Mountaineer XPress Project
Appendix N-2	Noise Sensitive Areas Associated with the Gulf XPress Project
Appendix O	References
Appendix P	List of Preparers
Appendix Q	FERC's Responses to Comments on the draft EIS

APPENDIX A Final EIS Distribution List

APPENDIX A – DISTRIBUTION LIST

Federal Agencies

Advisory Council on Historic Preservation, DC

Office of Federal Programs

Charlene D. Vaughn, Assistant Director for Federal Program Development

U.S. Army Corps of Engineers, DC

Planning and Policy Division John Furry, Senior Policy Advisor

U.S. Army Corps of Engineers, KY

Louisville District
David Baldridge, Regulatory Branch

U.S. Army Corps of Engineers, MS

Vicksburg District
Bryan Williamson, Regulatory Branch

U.S. Army Corps of Engineers, PA

Pittsburgh District Karen A. Kockenbach, Section Chief South Matthew Gilbert, Regulatory Branch

U.S. Army Corps of Engineers, TN

Nashville District
Timothy Wilder, Branch Chief, West Section

U.S. Army Corps of Engineers, WV

Huntington District Christopher Carson, Regulatory Project Manager Kayla Adkins, Regulator, North Branch

Council on Environmental Quality, DC

Horst Greczmiel, Associate Director for NEPA Oversight Manisha Patel, Deputy General Counsel

U.S. Department of Agriculture, DC

Farm Service Agency, Conservation and Environmental Program Division Nell Fuller, National Environmental Compliance Manager

U.S. Forest Service, Ecosystem Management Coordination Joe Carbone, Assistant Director, NEPA

Natural Resources Conservation Service Andree DuVarney, National Environmental Coordinator

U.S. Department of Agriculture, WV

Natural Resources Conservation Service Kevin Wickey, State Conservationist

Department of Commerce, MD

National Oceanic and Atmospheric Administration Steve Kokkinakis, NEPA Policy & Compliance

National Oceanic and Atmospheric Administration National Marine Fisheries Service Steve Leathery, National NEPA Coordinator

Department of Energy, DC

Office of Environmental Management
Mark Whitney, Principal Deputy Assistant Secretary

Office of NEPA Policy and Compliance Carol M. Borgstrom, Director, OGC

Division of Natural Gas Regulatory Activities John Anderson, Director

Department of Health and Human Services, DC

Edward Pfister, Environmental Program Manager

Department of Health and Human Services, GA

Centers of Disease Control, National Center for Environmental Health Sharunda Buchanan, Director, Division of Emergency and Environmental Health Services

Department of Housing and Urban Development, DC

Office of Environment and Energy
Danielle Schopp, Community Planner

Department of the Interior, DC

Bureau of Land Management

Kerry Rogers, Senior NEPA Specialist

Office of Environmental Policy and Compliance

Director

Department of the Interior, CO

National Park Service

Patrick Walsh, Chief, Environmental Planning and Compliance Branch

Department of the Interior, KY

U.S. Fish and Wildlife Service

Lee Andrews

Department of the Interior, MN

U.S. Fish and Wildlife Service, Midwest Ecological Services Office Erik Olson

Department of the Interior, MS

U.S. Fish and Wildlife Service

Kathy Lunceford

Stephen Ricks

Department of the Interior, TN

U.S. Fish and Wildlife Service

Mary Jennings

Robbie Sykes

Bureau of Indian Affairs - Eastern Regional Office

Harold Peterson

Department of the Interior, VA

Bureau of Ocean Energy Management

James F. Bennett, Chief, Division of Environmental Assessment

Bureau of Safety and Environmental Enforcement

Charles B. Barbee, Chief, Environmental Enforcement Division

Department of the Interior, WV

U.S. Fish and Wildlife Service, West Virginia Field Office

John Schmidt, Project Leader Tiernan Lennon, Fish and Wildlife Biologist

Department of Justice, DC

Environment & Natural Resources Division Beverly Li, NEPA Coordinator

Department of State, DC

Bureau of Oceans & International Environmental & Scientific Affairs Alexander Yuan, Foreign Affairs Officer

Department of Transportation, DC

Office of Assistant Secretary for Transportation Policy Camille Mittelholtz, Environmental Policy Team Coordinator Helen Serassio, Senior Environmental Attorney Advisor

Pipeline and Hazardous Materials Safety Administration

Jeffrey Wiese, Associate Administrator for Pipeline Safety

Magdy El-Sibaie, Associate Administrator for Hazardous Materials Safety

Sherri Pappas, Senior Assistant Chief Counsel

Office of Pipeline Safety

Bryn Karaus, Senior Attorney

Kenneth Y. Lee, Director, Engineering and Research Division

Karen Lynch, National CATS Coordinator

Surface Transportation Board

Victoria Rutson, Chief, Section of Environmental Analysis

Environmental Protection Agency, DC

NEPA Compliance Division

Cliff Rader, Director

Office of Enforcement and Compliance Assurance

Cynthia Giles, Assistant Administrator

Natural Gas STAR

Jerome Blackman

Office of Federal Activities

Susan E Bromm, Director

Environmental Protection Agency, GA

Resource Conservation & Restoration Division Larry Long, Director, Region 4

Environmental Protection Agency, PA

Barbara Rudnick, NEPA Team Leader, Region 3

Staff Reviewers
Alaina McCurdy

Aaron Blair

Office of Environmental Programs
Jeffrey D. Lapp, Associate Director

Senate, DC

Energy and Natural Resources Committee Lisa Murkowski, Chairman

U.S. Geological Survey, VA

Environmental Management Branch Esther Eng, Chief

U.S. Customs & Border Protection Department of Homeland Security, DC

Christopher Oh, Branch Chief

Native American Tribes

B. Cheryl Smith, Tribal Chief, Jena Band of Choctaw Indians, Jena, LA

Bill John Baker, Principal Chief, Cherokee Nation, Tahlequah, OK

Bryant Celestine, Historic Preservation Officer, Alabama-Coushatta Tribe of Texas, Livingston, TX

Chester Brooks, Chief, Delaware Tribe of Indians, Bartlesville, OK

Colabee III Clem Sylestine, Chief, Alabama-Coushatta Tribe of Texas, Livingston, TX

Douglas G. Lankford, Chief, Miami Tribe of Oklahoma, Miami, OK

Earl Barbry, Jr., Tribal Historic Preservation Officer, Tunic-Biloxi Indians of Louisiana, Marksville, LA

Earl J. Barbry, Sr., Chairman, Tunic-Biloxi Indians of Louisiana, Marksville, LA

Edwina Butler-Wolfe, Governor, Absentee-Shawnee Tribe of Indians of Oklahoma, Shawnee, OK

Everett Bandy, Tribal Historic Preservation Officer, Quapaw Tribe of Oklahoma, Quapaw, OK Gary Batton, Chief, Choctaw Nation of Oklahoma, Durant, OK

George G. Wickliffe, Chief, United Keetoowah Band of Cherokee Indians, Tahlequah, OK

George Strack, Tribal Historic Preservation Officer, Miami Tribe of Oklahoma, Miami, OK

George Wickliffe, Chief, United Keetoowah Band of Cherokee Indians, Tahlequah, OK

Glenna J. Wallace, Chief, Eastern Shawnee Tribe of Oklahoma, Seneca, MO

Glenna Wallace, Chief, Eastern Shawnee Tribe of Oklahoma, Wyandotte, OK

Ian Thompson, Tribal Historic Preservation Officer, Choctaw Nation of Oklahoma, Durant, OK

Jeremiah Hobia, Mekko, Kialegee Tribal Town, Wetumka, OK

Jill Crawford, Section 106 Coordinator, Coushatta Tribe of Louisiana, Elton, LA

Jody Hayes, Tribal Administrator, The Shawnee Tribe, Miami, OK

John Berrey, Chairperson, Quapaw Tribe of Oklahoma, Quapaw, OK

John P. Froman, Chief, Peoria Tribe of Indians of Oklahoma, Miami, OK

Johnnie Jacobs, Tribal Historic Preservation Officer, Muscogee (Creek) Nation, Okmulgee, OK

Joseph H. Blanchard, Tribal Historic Preservation Officer, Absentee-Shawnee Tribe of Indians of Oklahoma, Shawnee, OK

Kara Gann, Tribal Historic Preservation Officer, Kialegee Tribal Town, Wetumka, OK

Kerry Holton, President, Delware Nation, Anadarko, OK

Kimberly Walden, Tribal Historic Preservation Officer, Chitimacha Tribe, Charenton, LA

Leona Hicks, Executive Secretary, Thlopthlocco Tribal Town, Okemah, OK

Lisa LaRue, Tribal Historic Preservation Officer, United Keetoowah Band of Cherokee Indians, Tahlequah, OK

Logan Pappenfort, Tribal Historic Preservation Officer, Peoria Tribe of Indians of Oklahoma, Miami, OK

Lovelin Poncho, Chairman, Coushatta Tribe of Louisiana, Elton, LA

Maurice A. John, Sr., President, Seneca Nation of Indians, Salamanca, NY

Michell Hicks, Principal Chief, Eastern Band of Cherokee Indians, Cherokee, NC

Phyliss J. Anderson, Chief, Mississippi Band of Choctaw Indians, Choctaw, MS

Robert Thrower, Tribal Historic Preservation Officer, Poarch Band of Creek Indians, Atmore, AL

Roger Hill, Chief, Tonawanda Band of Seneca Indians of New York, Basom, NY

Ron Sparkman, Chief, The Shawnee Tribe, Miami, OK

Russell Townsend, Tribal Historic Preservation Specialist, Eastern Band of Cherokee Indians, Cherokee, NC

Ryan Morrow, Town King, Thlopthlocco Tribal Town, Okemah, OK

Tarpie Yargee, Chief, Alabama-Quassarte Tribal Town, Wetumka, OK

Ted Isham, Tribal Historic Preservation Officer, Muscogee (Creek) Nation, Okmulgee, OK

William L. Fisher, Chief, Seneca-Cayuga Tribe of Oklahoma, Grove, OK

Federal Representatives and Senators

Kentucky

Rand Paul, U.S. Senator

Mitch McConnell, U.S. Senator Harold "Hal" Rogers, U.S. Representative Garland "Andy" Barr, U.S. Representative

<u>Mississippi</u>

Roger Wicker, U.S. Senator Thad Cochran, U.S. Senator Bennie Thompson, U.S. Representative Trent Kelly, U.S. Representative

Tennessee

Lamar Alexander, U.S. Senator Bob Corker, U.S. Senator Jim Cooper, U.S. Representative Marsha Blackburn, U.S. Representative

West Virginia

Alex Mooney, U.S. Representative David McKinley, U.S. Representative Evan Jenkins, U.S. Representative Joe Manchin, U.S. Senator Shelley Capito, U.S. Senator

State Representatives and Senators

Kentucky

Bart Rowland, Representative
Jonathon Shell, Representative
Mike Denham, Representative
Rocky Adkins, Representative, State House Majority Floor Leader
David Givens, Senator
Stephen West, Senator
Tom Buford, Senator

<u>Mississippi</u>

David Jordan, Representative Jim Beckett, Representative Jody Steverson, Representative Steven Massengill, Representative Lydia Chassaniol, Senator

Nickey Browning, Senator

Tennessee

David Byrd, Representative Jason Powell, Representative Mike Stewart, Representative Jeff Yarbro, Senator

West Virginia

Anna Border-Sheppard, Representative

Bob Ashley, Representative

Carol Miller, Representative

David Evans, Representative

David Pethtel, Representative

Don Perdue, Representative

Doug Reynolds, Representative

Jim Butler, Representative

Jim Morgan, Representative

Kenneth Hicks, Representative

Lynwood Ireland, Representative

Mathew Rohrbach, Representative

Michael Ferro, Representative

Michael Ihle, Representative

Patrick Lane, Representative

Robert Hanshaw, Representative

Ron Walters, Representative

Scott Cadle, Representative

Sean Hornbuckle, Representative

Steve Westfall, Representative

Tim Armstead, Representative

William Romine, Representative

Chris Walters, Senator

David Nohe, Senator

Ed Gaunch, Senator

Donna Boley, Senator

Jeffrey Kessler, Senator

Kent Leonhardt, Senator

Mark Maynard, Senator

Mike Hall, Senator

Mike Woelfel, Senator

Mitch Carmichael, Senator

Robert Plymale, Senator

State Agencies

Kentucky

Blake Brickman, Governor Chief of Staff

Kentucky Department of Fish and Wildlife Resources

Daniel Stoelb

Tim Slone

Kentucky Heritage Council

Jennifer Ryall

Mississippi

Alice Perry, Governor

Tate Reeves, Lt. Governor

Lucien Smith, Governor Chief of Staff

Pierce Moore, Governor Policy Analyst

Lee Weiskopf, Lt. Governor Policy Advisor

Kenny Ellis, Lt. Governor Legislative Liaison

Mississippi Department of Archives and History

Ken P'Pool

Mississippi Museum of Natural Science

Libby Hartfield

Phillip Sanderson

Tennessee

Bill Haslam, Governor

Randy McNally, Lt. Governor

Jim Henry, Governor Chief of Staff

Leslie Hafner, Governor Senior Advisor

Robert Marineau, Environment and Conservation Commissioner

Tennessee Historical Commission

E. Patrick McIntyre, Jr., Executive Director

Tennessee Natural Heritage Inventory Program

David Withers

Stephanie Ann Williams

West Virginia

Earl Ray Tomblin, Governor

West Virginia Commerce Department Keith Burdette, Director

West Virginia Chamber of Commerce Stephen G. Roberts

West Virginia Division of Culture and History

Jeffrey S. Smith, Structural Historian

Lora A. Lamarre-DeMott, Senior Archaeologist

Susan M. Pierce, Deputy State Historic Preservation Officer

West Virginia Division of Natural Resources

Wildlife Resources Section

Barbara Sargent, Environmental Resource Specialist

Clifford L. Brown, Environmental Coordination Unit

Office of Land and Streams

Joe Scarberry, Supervisor

West Virginia Department of Environmental Protection

Randy Huffman, Director

Division of Air Quality

Beverly McKeone, New Source Review Program Manager

Jack Fedczak, Assistant Director for Permitting

Division of Water and Waste Management

John Perkins, Senior Technical Analyst NPDES Hydrostatic Water Testing

Jon Michael Bosley, Stormwater Permitting Supervisor

Nancy J. Dickson, Environmental Resource Specialist

Patrick Campbell, Deputy Director

Wilma Reip, Project Manager

Division of Air Quality, Title V

Carrie McCumbers, Title V Permitting Specialist

Division of Water and Waste Management

Brian A. Carr, Large Quantity Water Use Program Manager

West Virginia Department of Transportation, Division of Highways

West Virginia Railroad Maintenance Authority

County/City Agencies

Metcalfe County, KY

Greg Wilson, Judge Executive Vickie Stephens, Deputy Judge Executive Lorrie Boston, County Coordinator

Garrard County, KY

John P. Wilson, Judge Executive Karen Evan, Legislative Aide

Rowan County, KY

Walter Blevins, Judge Executive

Davidson County (Nashville), TN

Megan Berry, Mayor
Rich Reibeling, Mayor Chief Operating Officer
David Briley, Vice Mayor
Greg Hinote, Deputy Mayor
Jon Cooper, Director of Law
Jennifer Pfeiffer, Deputy to the Chief of Staff
Fabian Bedne, Council Member
Jacobia Dowell, Council Member
Jason Potts, Council Member
Jim Shulman, Council Member
Karen Johnson, Council Member
Robert Duvall, Council Member
Robert Swope, Council Member
Sam Coleman, Council Member

Wayne County, TN

Jason Rich, County Executive
Rena Purdy, TCEcD, Chamber of Commerce
Joe Hanback, Commissioner
John McDonald, Commissioner
O.C. Berry Jr., Commissioner
Steve Anderson, Commissioner

Tanaka Vercher, Council Member

Cabell County, WV

Karen Cole, County Clerk Anne Yon, Commissioner Bob Bailey, Commissioner Nancy Cartmill, Commissioner Gordon Merry, EMS Director

Calhoun County, WV

Jean Simers, County Clerk Kevin Helmick, Commissioner Robert Weaver, Commissioner Scottie Westfall II, Commissioner

Doddridge County, WV

Beth Rogers, County Clerk
Greg Robinson, Commissioner
Ralph Sandora, Commissioner
Ronnie Travis, Commissioner
Greg Cottrill, Doddridge County Parks
Pat Heaster, Emergency Services Director

Jackson County, WV

Jeff Waybright, County Clerk
Dick Waybright, Commissioner
Mike Randolph, Commissioner
Tommy Nutter, Commissioner
Walter Smittle, Emergency Services Director
Jackson County Board of Education, LeRoy, WV
Jackson County Commission, Ripley, WV

Kanawha County, WV

Vera McCormick, County Clerk
Dave Hardy, Commissioner
Henry Shores, Commissioner
Dale Petry, Emergency Management Director

Mason County, WV

Diana Cromley, County Clerk

Miles Epling, Commissioner

Rick Handly, Commissioner

Tracy Doolittle, Commissioner

Chuck Blake, Emergency Services Director

Marshall County, WV

Betsy Wilson-Frohnapfel, County Administrator

Jan Pest, County Clerk

Robert Miller Jr., Commissioner

Scott Varner, Commissioner

Stanley Stewart, Commissioner

Thomas Hart, Emergency Management Director

Putnam County, WV

Brian Wood, County Clerk

Andy Skidmore, Commissioner

R. Joseph Haynes, Commissioner

Stephen Andes, Commissioner

Frank Chapman, Emergency Management Director

Putnam County Chamber of Commerce

Putnam County Development Authority Inc.

Ritchie County, WV

Tracy McDonald, County Clerk

Ritchie County Commission

Floyd Hodge, Commissioner

Samuel Rogers, Commissioner

Stephen Worden, Commissioner

James White, Emergency Services Director

Roane County, WV

Jennifer Randolph, County Administrator

Charles White Jr., County Clerk

Gary Mace, Commissioner

Melissa O'Brien, Commissioner

Merlin Shamblin, Commissioner

Melissa Gilbert, Emergency Services Director

Tyler County, WV

Charles Smith, Commissioner Eric Vincent, Commissioner

John Stender, Commissioner

Teresa Hamilton, Commissioner

Thomas Cooper, Emergency Management Director

Wayne County, WV

David Pennington, Commissioner Kenneth Adkins, Commissioner

Wetzel County, WV

Carol Haught, County Clerk

Bob Gorby, Commissioner

Don Mason, Commissioner

Larry Lemon, Commissioner

Ed Sapp, Emergency Services Director

Wirt County, WV

Suellen Calebaugh, County Clerk

Charles Murray, Commissioner

Robert Gunnoe Jr., Commissioner

Robert Lowe, Commissioner

Town Agencies

Milton, WV

Town of Milton

Wheeling, WV

Regional Economic Development Authority Josh Jefferson, Project Coordinator

Winfield, WV

Brian Donat, City Manager

Grayson, KY

City of Grayson

Libraries

Kentucky

Boyd County Public Library - Ashland Main, Ashland, KY Carter County Public Library - Grayson Branch, Grayson, KY Garrard County Library, Lancaster, KY Metcalfe County Library, Edmonton, KY Rowan County Library, Morehead, KY

<u>Mississippi</u>

Elizabeth Jones Library, Grenada, MS Union County Library, New Albany, MS

Tennessee

Nashville Public Library Southeast Branch, Antioch, TN Wayne County Public Library, Waynesboro, TN

West Virginia

Barboursville Public Library, Barboursville, WV

Benwood-McMechen Public Library, McMechen, WV

Cabell County Public Library, Huntington, WV

Calhoun County Library, Grantsville, WV

Cameron Public Library, Cameron, WV

Center Point Outpost Library, Salem, WV

Cox Landing Public Library, Lesage, WV

Doddridge County Library, West Union, WV

Dora B. Woodyard Memorial Library, Elizabeth, WV

Gallaher Village Library, Huntington, WV

Guyandotte Library, Huntington, WV

Hannan Public Library, Ashton, WV

Hundred Public Library, Hundred, WV

Jackson County Public Library - Ravenswood, Ravenswood, WV

Jackson County Public Library - Ripley, Ripley, WV

Mason City Public Library, Mason, WV

Mason County Public Library, Point Pleasant, WV

Milton Public Library, Milton, WV

Moundsville-Marshall County Library, Moundsville, WV

New Haven Public Library, New Haven, WV

New Martinsville Library, New Martinsville, WV

Paden City Public Library, Paden City, WV

Pennsboro Branch Library, Pennsboro, WV

Pine Grove Library, Pine Grove, WV

Putnam County Library - Buffalo Branch, Buffalo, WV

Putnam County Library - Eleanor Branch, Eleanor, WV

Putnam County Library - Hurricane Branch, Hurricane, WV

Putnam County Library - Main Branch, Hurricane, WV

Putnam County Library - Poca Branch, Poca, WV

Ritchie County Public Library, Harrisville, WV

Roane County Library, Spencer, WV

Salt Rock Library, Salt Rock, WV

Sistersville Public Library, Sistersville, WV

Tyler County Public Library, Middlebourne, WV

Walton Public Library, Walton, WV

West Huntington Library, Huntington, WV

Newspapers

Kentucky

Daily Independent, Ashland, KY

Grayson Journal, Grayson, KY

Morehead News, Morehead, KY

The Edmonton Herald News, Edmonton, KY

The Richmond Registrar, Richmond, KY

Mississippi

New Albany Gazette, New Albany, MS

The Grenada Star, Grenada, MS

Tennessee

Tennessean, Franklin, TN

Wayne County News, Waynesboro, TN

West Virginia

Green Tab, Moundsville, WV

Jackson Herald/Jackson Star News, Ripley, WV

The Calhoun Chronicle, Grantsville, WV

The Charleston Gazette, Charleston, WV

The Doddridge Independent (weekly), West Union, WV

The Intelligencer, Wheeling, WV

The Pennsboro News (weekly), Harrisville, WV

Miscellaneous Individuals, Organizations, and Landowners

A. Julian, Antioch, TN

Aaron J. & Shelly B. Ramey, Hana, HI

Abdullah & Zehra Berwary, Antioch, TN

Abdulsalam H. Gundky, Antioch, TN

Abe Yazdian, Nashville, TN

Abiodun Adefurin & Abimbola Oginni, Antioch, TN

Adam Kniseley, Raleigh, NC

Adena & Nicholas Petsch, Antioch, TN

Adrenna M. Epling, Ripley, WV

AH4R-TN 3, LLC, Malibu, CA

Ahmad M. Mohammad & Dawlat Adbi, Antioch, TN

Ahmad R. Afzal, Antioch, TN

Ahmed & Aziza A. Duski, Antioch, TN

Alaina Mullins, Antioch, TN

Alan A. & Zuleyha O. Ahmed, Antioch, TN

Albert & Janice Peterson, Ripley, WV

Albert B. Hankins, Jr., Grenada, MS

Albert Moore, New Martinsville, WV

Albin Gesek & Carol Myers, West Union, WV

Alex Cole, Pliny, WV

Alex P. O'Neill, Coal, Murray Energy Corporation, St. Clairsville, OH

Alexandria D. Jones, Antioch, TN

Alfred & Francis Rose, Brohard, WV

Alfred & Lois Kent, Antioch, TN

Alfred Marcos, Antioch, TN

Alice Ruth Strange, Antioch, TN

Alicia Douglas, Antioch, TN

Alicial Maddox, Antioch, TN

Alisa D. & Rodney W. Barlow, Antioch, TN

Alissa Walker, Grayson, KY

Allan B. & Pamela D. Schmidt, Antioch, TN

Allan Leroy Wilson & Ricky Joe Dockery, Oldtown, MD

Allegheny Defense Project, Kane, PA

Allen Doneff, Sr., Milton, WV

Allen Leadmon, Hurricane, WV

Allen Neal & Nina Wallace Gross, Antioch, TN

Allen Nelson, Sandyville, WV

Allen, Glenn Jr., Margaret & Michael Mann, Post Falls, ID

Allissa Nicole & Robert S Caudill, Grayson, KY

Alton Gene and Randa Joyce Watson, Harrisville, WV

Alvin L. Engelke, Creston, WV

Alvin Polin, Reedy, WV

Amanda Achry-Hill, Antioch, TN

Amanda L. Suttles, Grayson, KY

American Homes 4 Rent Properties Seven, LLC, Agoura Hills, CA

American Residential Leasing Company, LLC, Agoura Hills, CA

AMH 2014-2 Borrower, LLC, Agoura Hills, CA

AMH 2014-3 Borrower, LLC, Agoura Hills, CA

AMH 2015-1 Borrower LLC, Agoura Hills, CA

Amir Yacoub & Wafaa Henain, Antioch, TN

Amon and Tonda Yates, Grayson, KY

Amy Dawson, Munday, WV

Amy R. & Antwon D. Butler, Antioch, TN

Anas M. Muhsin, Antioch, TN

Anda K. Hileman, West Union, WV

Andrea Lynee Tyler, Antioch, TN

Andrew & Andrea Shuluga, Saint Petersburg, FL

Andrew & Beth Williamson, Harts, WV

Andrew L. Bailey, Antioch, TN

Andrew MacBride, National Grid, Waltham, MA

Andrew Paul, Jeriann, & Barbara Roberta Berry, Antioch, TN

Andrew & Jamie Peterson, Antioch, TN

Andrew Rowlett, Yorktown, VA

Andrew W. & Mallory L. Dood, Antioch, TN

Andrew Wells & Tania Bartos-Wells, Antioch, TN

Andrius Malinauskas & E. O. Malinauskein, Antioch, TN

Andy & Melissa Platt, Antioch, TN

Anealia Sasser, Cane Ridge, TN

Angela Burr Adderly, Antioch, TN

Angela Ellis, Cane Ridge, TN

Angela M. & Andrew P. Wilson, Antioch, TN

Angela Mclean, Antioch, TN

Angela Radford, Antioch, TN

Angie & Patrick Johnston, Nashville, TN

Angie Rosser, Executive Director, West Virginia Rivers Coalition, Charleston, WV

Ann Cook, Roswell, GA

Ann Czerner, Alexandria, VA

Ann Hisle Cook Trustee, Roswell, GA

Ann Woods, Holcomb, MS

Anna Chamleunsouk & Praphatsone Boupharath, Antioch, TN

Anna E. Strickland, Antioch, TN

Anna M. Ortiz, Antioch, TN

Anna Virbick, Dallas, TX

Anne Lawrence, Summer Shade, KY

Annette G. Ericksen, Milton, WV

Antero Resources Corporation, Denver, CO

Anthere Nzabatsinda & Madlyn Bonimy, Antioch, TN

Anthony & Lois Gray, Antioch, TN

Anthony Eruolin, West Union, WV

Anthony H & Marla L Hicks, Edmonton, KY

Anthony R. Lawrence, Antioch, TN

Anthony W. Little, Grayson, KY

Antonio D. & Kara Zapata, Antioch, TN

Antonio R. Johnson, Antioch, TN

Appalachian Power Company, Canton, OH

Aren Sulfridge, Antioch, TN

Ariel M. Elam, Antioch, TN

Arley & Winona Holbrook, Barboursville, WV

Arnie Goodnight, Moundsville, WV

Arnold & Pamela Conant, Leroy, WV

Arnold Lee Bonnell, Tridelphia, WV

ARP 2014-1 Borrower LLC, Agoura Hills, CA

Arthur Cain, Given, WV

Arthur D., Jr & Catherine Henderson, Antioch, TN

Arthur J. Yevchak, Antioch, TN

Arthur L. Waryck, Glen Dale, WV

Ascent Resources, Oklahoma City, OK

Ashley Giles Etal, Antioch, TN

Ashley Lafalce, West Union, WV

Asya Meho & Bewar Dosky, Antioch, TN

Audie L. & Kimberly B. Sheridan, Antioch, TN

Augustina Durunna, Antioch, TN

Augustine Tina Tuggle, Antioch, TN

Austin & Regina Bryant, Grayson, KY

Author Baptist & Brilontine Peete, Antioch, TN

Aysha H. & Mahir Tovi, Antioch, TN

Barbara Cunningham, New Martinsville, WV

Barbara F. Gray, Nashville, TN

Barbara Hudson, Red House, WV

Barbara Jividen, Red House, WV

Barbara Roe, Grayson, KY

Barbara and Ronald Yerkey, West Union, WV

Barbara Young, Milton, WV

Barnes Bend Estates Homeowner's Assn Inc., Nashville, TN

Barry A. Burgess, Antioch, TN

Barry Duane Brown & Cathy Hibbs, Antioch, TN

Barry Hamilton, Morehead, KY

Barry Vincent, Nashville, TN

Bashar Halwani & Alhabbal Rula & Mala Al. Idany, Brentwood, TN

Bassell Maxwell & Mary Holland Irrevockable Trust, c/o Jane Hafer, Westfield, NJ

BCG Land LLC, Stanford, KY

Beatrice Jacobs, Trustee, Antioch, TN

Beckwith Realty Inc., Huntington, WV

Belinda J. Boggess, Ripley, WV

Belma Withrow, Hurricane, WV

Ben J. Schoene, Sr. Regulatory Analyst, Houston, TX

Ben Thompson, U.S. Oil and Gas Association, Jackson, MS

Benjamin Bateman, Nashville, TN

Benjamin D. Logan, Scobey, MS

Benjamin Shanower, Louisville, OH

Benton and Nancy Kilgallin, Catlettsburg, KY

Berevan A. Barwari, Antioch, TN

Bernard & Patricia Stanley, Proctor, WV

Bernard E. Johnson, III, Antioch, TN

Bernice & James Barr, New Milton, WV

Bertha A. Scott, Elizabeth, WV

Beth A. Holley, Ripley, WV

Beth Gilliam, Antioch, TN

Betty Casto, Leon, WV

Betty D. Reed, Culloden, WV

Betty E. Gibson, Hurricane, WV

Betty Guffey, Smyrna, TN

Betty K. & David L. Allison, Antioch, TN

Bevery Dillon, Ripley, WV

Big Tygart Farms LLC, Mineral Wells, WV

Bill & Betty Swartz, Melbourne, FL

Bill Crum, Lancaster, OH

Bill Knoblock, Madison, IN

Billy & Sue Hurt C/O Larry and Nancy Hurt, Summer Shade, KY

Billy Fouty, Reedy, WV

Billy Greer Jr. & Clara Greer, Grayson, KY

Billy J Menix, Grayson, KY

Billy J. Gregg & Lynn P. Gregg, Hurricane, WV

Billy Lowell Kouns, Grayson, KY

Bishnu & Thakur Magar, Antioch, TN

Blackstone Development Inc., Brentwood, TN

Blake G. Bohanan & Kayla E. Smith, Antioch, TN

Bobby L. Eads, Buffalo, WV

Bonnie Johnson, Hurricane, WV

Boyd H. & Loretta M. Neiswenter, Given, WV

Brad E. Hammond & Kimberly N. Marsh, Antioch, TN

Brad Maggard, Catlettsburg, KY

Bradley Crow, Morgantown, WV

Bradley Zeigler, Elkview, WV

Brandon & Kayla Jordan, Grayson, KY

Brandon Six, Oakdale, PA

Brandon Wayne Rigsby, Antioch, TN

Brant Miller, Friends of Mill Creek Greenway, Cane Ridge, TN

Braxton Collins, Assistant General Counsel, SCANA Corporation, Public Service Company of

North Carolina, Inc., Cayce, SC

Brenda Joyce Gambill & Derek Michael Whittaker, Lavergne, TN

Brenda Mcmillan, Antioch, TN

Brenda Roberts, Creston, WV

Brent & Satona Cunningham, Moundsville, WV

Brent H. Clayton, Antioch, TN

Bretford W. & Jacqulyn C. Bell, Antioch, TN

Brian & Sarah Board, Ripley, WV

Brian & Stacey M. Cox, Antioch, TN

Brian Anderson & Kari Reed, Ripley, WV

Brian Arrington, Winfield, WV

Brian Cox, Antioch, TN

Brian Douglas & Shanna Marie Bauman, Antioch, TN

Brian E Flannery, Oldtown, KY

Brian Harvey, Leon, WV

Brian J. Knight, etal, Ripley, WV

Brian Keith & Anna Marie Bayes, Grayson, KY

Brian L Fields, Gas, Regulatory, Calpine Corporation, Houston, TX

Brian L. & Allicia Bellew, Hampstead, NC

Brian L. & Hollye K. Salazar-Cross, Antioch, TN

Brian M. Pulley, Antioch, TN

Briar Fork Trust, Roanoke, VA

Brice A. Mcmaster & Samantha Cunningham, Antioch, TN

Brient J. & Katelyn G. Barnett, Antioch, TN

Brittany Carns, Charleston, WV

Brotherton Heirs in care of J. Kay, LeRoy, WV

Bruce & Sharon Shamblin, Big Springs, WV

Bruce P. Bannerman, Culloden, WV

Brunette T. Jeanniton-Daly, Antioch, TN

Bryan & Heather Ireland, Pullman, WV

Bryan S. & Liesl C. Dunlap, Antioch, TN

BT Wayne LLC, Luka, MS

Buck Murray, Ripley, WV

Burns & McDonnell, Attn: Carrie Barton, Kansas City, MO

Burns & McDonnell, Attn: Jennifer Bell, Centennial, CO

Burns & McDonnell, Attn: Robyn Susemihl, Alpharetta, GA

Byron & Gloria McDavid, Grayson, KY

C. Eric & Candace H. Seagraves, Antioch, TN

CAD Energy Corporation, Creston, WV

Caldwell Mildred S. & Caldwell Investment Group, Charleston, WV

Calvin Burchett, Leon, WV

Campbell Lane Estates LLC, Grayson, KY

Capitol Homes Inc., Brentwood, TN

Carl & Debra Greer, Grayson, KY

Carl E. Walters, Providence, NC

Carl H. & Carolyn S. Clay, Antioch, TN

Carl Harris, Antioch, TN

Carl L. Bell, Moundsville, WV

Carl M. Thach, Jr., Greenwood, MS

Carl Reynolds, Mineral Wells, WV

Carlos Torres Lazo & Monica Delgado Gonazales, Antioch, TN

Carol A. Clark, Moundsville, WV

Carol Haught & John Haught, Mt. Sterling, KY

Carol L. Irwin & Jacqueline J. Hetzer, West Union, WV

Carol Lynn & David Liston, Wadsworth, OH

Carole Downes, Ashburn, VA

Carole M. Welling, Given, WV

Caroline C. Mgbemere, Antioch, TN

Caroline Copenhaver, Hurricane, WV

Carolyn D. Mcintyre, Ripley, WV

Carolyn Kennedy, Antioch, TN

Carolyn S. Jenkins, Munday, WV

Carrie D. Mills, Antioch, TN

Carroll & Patricia Winters, Ripley, WV

Carry & Terri Ranson, Ripley, WV

Cassandra Thompson, Cain Ridge, TN

Castle Tower Corporation, McMurray, PA

Casto Cemetery, Ripley, WV

Catherine Byrd, Antioch, TN

Catherine Donahue & Diane Melton, Delaware, OH

Catherine Goddard & James Ledergerber, Reynoldsburg, OH

Cecil Radcliff, West Union, WV

Cedar Creek Farms Homeowners Association, Eleanor, WV

Cemetery Philadelphia, Waynesboro, TN

Chad Reed, Leon, WV

Chadrick G. Lowther & Jamie Bero, Winfield, WV

Charles & Barbara Welling, West Union, WV

Charles & Patsy Heaster, West Union, WV

Charles & Patsy Monk, Ripley, WV

Charles A. & Brenda K. Pierson, Ripley, WV

Charles B & Deidre Jill Yates, Grayson, KY

Charles Bedwell, Buffalo, WV

Charles Brett & Natalie Kay Valdez, Antioch, TN

Charles E & Selena R Terry, Grayson, KY

Charles E. Nesler, II, Longs, SC

Charles E., Jr & James Hetal Brownlee, Nashville, TN

Charles F. Guthrie, Hurricane, WV

Charles H. Whiting, Antioch, TN

Charles Hall, Nashville, TN

Charles Harrison & Alice M Clark, Grayson, KY

Charles L. Jr & Dorothy H. Cooper, Antioch, TN

Charles L. Morrison, Normantown, WV

Charles L. & Vickie D. Perine, Pullman, VA

Charles Matthew & Brianna Howard Griffin, Antioch, TN

Charles McCray Trust & Mark L. McCray, Mineral Wells, WV

Charles R. & Jimmy L. Carpenter, Harrisville, WV

Charles R. & Patricia Smith, Grayson, KY

Charles R. Cook, Chevron USA Inc., Houston, TX

Charles T. Box Revocable Trust, Marion, IL

Charles W. & Glenna Hennen, Elizabeth, WV

Charles W. Yeager, III, Perry Hall, MD

Charles William Hall, III & Amanda Grace Hall, Antioch, TN

Charles & Joanne Hunt, Charleston, WV

Cheryl Lynn & Carl E. Booker, Antioch, TN

Cheryl M. Ward, Milton, WV

Cheryl Meredith, Clarksburg, WV

Cheryl Miller, Grayson, KY

Chester & Imogene Caudill, Morehead, KY

Chester G. & Alesha M. Williams, Grayson, KY

Chester Skeen, Charleston, WV

Childers Farms, Inc., Hurricane, WV

Chris Campbell, Grayson, KY

Chris Capitani, Nashville, TN

Chris E. & Laura D. Harshbarger, Milton, WV

Chris M & Rebecca D Horton, Grayson, KY

Chris Strong, Cane Ridge, TN

Chrisanthi Zotos, Antioch, TN

Christian Smith, Winfield, WV

Christopher & Dennis Doyle, Wheeling, WV

Christopher & Katrina M. Lee, Antioch, TN

Christopher & Melissa Mosier, Grayson, KY

Christopher D. Mattingly, Antioch, TN

Christopher D. Young, Senior Counsel, Constellation Energy Commodities Group, Inc.,

Baltimore, MD

Christopher Hill, New Albany, MS

Christopher J. & Kimberly Ann Phillips, Las Vegas, NV

Christopher L. & Monica S. Mercado, Antioch, TN

Christopher L. & Rhonda N. Taylor, Antioch, TN

Christopher L. & Shelley D. Crooks, Grayson, KY

Christopher L. Coffman, West Union, WV

Christopher M. Gooch, III & Dianne Jl. Gooch, Antioch, TN

Christopher M. Heywood, Legal Counsel, Statoil Natural Gas LLC, Stamford, CT

Christopher Mealey, Reedy, WV

Christopher P. & Jennifer L. Kucia, Palestine, WV

Christopher R. Capitani, Nashville, TN

Christopher Sarver, Antioch, TN

Christopher Tuley, Keep Southeast Nashville Healthy, Cane Ridge, TN

Christopher Wiseman, Buffalo, WV

Christy C. & Jason A. Smith, Antioch, TN

Church Philadelphia, Waynesboro, TN

Cindi Croomes, Cane Ridge, TN

Clara I. Crow, Moundsville, WV

Clarence Randall & Bualate G. Hudgens, Antioch, TN

Claudia Black, Antioch, TN

Clinton & Karen Harris, Reader, WV

Clyde Bradley Bennett, Antioch, TN

Clyde Frashure, Jr., Monckscorner, SC

CNX Land Resources, Inc., Canonsburg, PA

Coastal Forest Resource Company, Buckhannon, WV

Cody Wright & Sarah Merritt, Antioch, TN

Colby B. & Tara M. Shea, Antioch, TN

Columbia Gas Transmission, LLC, Charleston, WV

Comstock Irrevocable Trust & Silvestre Trust, Issaquah, WA

Cone Gathering, LLC, Canonsburg, PA

Connie F. S. Henry, Southport, NC

Connie Humes, Summer Shade, KY

Connie J. & Gary A. Tolley, Given, WV

Connie L. Knipp, Grayson, KY

Connie M. Hansom, Antioch, TN

Connie Rogucki, Grafton, WV

Connie Staggs, Nashville, TN

Consolidation Coal Company, St. Clairsville, OH

Constance Taylor, New Martinsville, WV

Corinne Unger, Antioch, TN

Cory A. & Mie Na West, Antioch, TN

Craig Harvey, Charleston, WV

Craigo Real Estate Corporation, Nitro, WV

Creed & Opal Hardman, Smithville, WV

CSX Transportation Inc., Jacksonville, FL

Curtis W. Ault & Brittany N. Fraser, Antioch, TN

Cynthia Brewer, Cane Ridge, TN

Cynthia & Fred Jackson, Antioch, TN

Cynthia D. Ellis, President, West Virginia Highlands Conservancy, Charleston, WV

D & M Powell, LLC, West Union, WV

D&D Dismantling, Inc., Spencer, WV

Dale & Barbara Stone, Leon, WV

Dale & Melissa Keplinger, Gassaway, WV

Dallas Smith, etal, Harrisville, WV

Dallison Lumber Company Inc., Jacksonburg, WV

Dalton & Teddy Parsons, Brohard, WV

Dan & Glenda Kirby, Brentwood, TN

Dan Lekich, Nashville, TN

Dan Thomas, Brentwood, TN

Danelle J. Hughes, Antioch, TN

Daniel & Amber Rush, New Martinsville, WV

Daniel & Cindy Ellis, Piney Point, MD

Daniel & Jeanette Corey, Charleston, WV

Daniel & Jennifer A. Harris, Grayson, KY

Daniel & Kendall Call, Culloden, WV

Daniel E. II & Megan Freeman, Culloden, WV

Daniel H. Weed, Charleston, WV

Daniel Hughes, Leon, WV

Daniel J. Beyer, Antioch, TN

Daniel Jividen, Knoxville, TN

Daniel K. & Lisa A. Jozwick, Salem, WV

Daniel Mcguire & Erica Kay Hause, Antioch, TN

Daniel R. & Mary Lou Clevenger, Smithville, WV

Dannett M & Christopher R Stone, Grayson, KY

Dannie Huffman and Dervin Clay Huffman, Lewisburg, WV

Danny & Dianne Dolin, Ripley, WV

Danny & Joyce Groover, Avon, IN

Danny & Patty Sue Sergent, Grayson, KY

Danny Belcher, Ripley, WV

Danny Briggs, etal, Wileyville, WV

Danny J. & Penny E. Conner, Culloden, WV

Danny Mallett, Buffalo, WV

Danny McCormick, Liberty, WV

Danny R. & Annie F. Knight, Culloden, WV

Dara & Matthew Zarth, Antioch, TN

Darlene F. Smith, Ripley, WV

Darrell & Allene Miller, Summer Shade, KY

Darrell Brumfield, Kissimmee, FL

Darrell C. Bowers Etal, Alburquerque, NM

Darrell Taylor, Hurricane, WV

Darwin Brown, Friendly, WV

Dave Goodwin, Saint Albans, WV

David & Candy Mullan, West Union, WV

David & Christine Blythe, Summer Shade, KY

David & Jocelyn Gutekunst, Antioch, TN

David & Linda Cooper, Ripley, WV

David & Nancy Knight, Smithville, WV

David & Susanna Blumig, Palestine, WV

David & Terri Owens, Barboursville, WV

David & Victoria Bland, West Union, WV

David Beasten, Manager - Supply Planning and, Reading, PA

David Bowyer & Deborah Lynn Wyckoff, Alma, WV

David Burtrand, etal, Reader, WV

David C. Jean & Samantha Smith, Antioch, TN

David C. Jr & Deborah L. Hardy, Antioch, TN

David Chapman, Washington, PA

David E. & Beverly Miller, Grayson, KY

David E. & Robin D. Simms, Milton, WV

David E. & Shelly M Moore, Summer Shade, KY

David E. Bowyer, Alma, WV

David E. Ellis, Red House, WV

David F. Caffery, Dir. Ptflo Mgmt & Reg, PSEG Energy Resources & Trade LLC, Newark, NJ

David Goode, Summer Shade, KY

David Hastings, St. Albans, WV

David Hodge, Berea, WV

David Johnson, Red House, WV

David K. & Marilyn D. Ramey, Culloden, WV

David K. Goebel, Ashland, KY

David L. Card & Christopher M. Yount Et Al, Antioch, TN

David L. Daughtry, Fuels Procurement Administration, City of Richmond, Virginia,

Richmond, VA

David L. Hensley, Barboursville, WV

David L. & Roberta L. Morton, Culloden, WV

David Meadows, Red House, WV

David P. Warsinsky, New Hope, AL

David Potter, ERM, Minneapolis, MN

David R & Tiffany B Matthews, Summer Shade, KY

David R. Ferrebee, West Union, WV

David Roland Bayer, Antioch, TN

David Sayre, Buffalo, WV

David W. Mullins, Ripley, WV

David W. Sayre, Buffalo, WV

David Waybright, Ripley, WV

David Weekley, St. Marys, WV

David Whited & Jill Easter, Ripley, WV

David Wymond, Houston, TX

David Yoders, Moundsville, WV

Dayton Lovejoy, Red House, WV

Deanna Allen, Milton, WV

Dearld Mason, Paden City, WV

Debbie Hoffman, Mt. Alto, WV

Deborah & Gregory Suttles, Grayson, KY

Deborah S. Wilson, Antioch, TN

Deborah T. Sweeneny, Culloden, WV

Debra & Timothy Holley, Ripley, WV

Debra & Timothy Shamblen & Patricia Brown, Lockbourne, OH

Debra Cart, Red House, WV

Deepak A Raval, Federal Energy Specialist, NiSource Distribution Companies, Columbus, OH

Deer Valley Homeowners Association Inc., Cane Ridge, TN

Delmar E. & Virginia L. Eagle, LeRoy, WV

Delmer Rhodes, Ripley, WV

Delvin Downs Homeowners Association, Inc., Brentwood, TN

Dempsey & Kathy Casto, Liberty, WV

Dennis & Carolyn Stover, Ripley, WV

Dennis & Dianne Cochran, Ripley, WV

Dennis Caveny, Antioch, TN

Dennis Cooper, Parkersburg, WV

Dennis Phengsavanh & Vanny Chhay, Antioch, TN

Dennis Weed, Charleston, WV

Denver & Mary Beth Cox, Smithburg, WV

Derek & Elaine King, Antioch, TN

Derek & Emily Lane, Ripley, WV

Derry G. & Beatrice Baltimore, Antioch, TN

Dervin Clay and Dannie L. Huffman, Lewisburg, WV

Devin L. & Cara Y. Maddox, Antioch, TN

Devon C. Horsley, Mineral Wells, WV

Diane Bedwell, Buffalo, WV

Diane Ludwig, Elizabeth, WV

Dianne McIntyre, Ripley, WV

Dimetra Mccutcheon, Antioch, TN

Dino and Rebecca Corsetti, Grayson, KY

Dominion Hope, Clarksburg, WV

Dominion Transmission, Inc., Pittsburgh, PA

Don & Carol Tangren, Cane Ridge, TN

Don Jr & Valerie Everman, Grayson, KY

Don Shipman and Divetta Shipman, Saint Marys, WV

Don Springer, Eaton Park, FL

Don Wimpelberg. Antioch, TN

Donald & Bonnie Elliott, Grayson, KY

Donald & Cora Jones, Ripley, WV

Donald & Helen Casto, Given, WV

Donald & Ilena Thomas, West Union, WV

Donald & Myrna Mason, Reader, WV

Donald A. Dunn, III & Jacqueline Ree Dunn, Antioch, TN

Donald and Opal Withrow, Grayson, KY

Donald E. & Claudia Y. Black, Antioch, TN

Donald G. & Norma Ruth Spurgeon, Antioch, TN

Donald L. Barnes, Harrisburg, PA

Donald M. Thompson, Charleston, WV

Donald McCoy, Jacksonburg, WV

Donald P. & Einleen J. Mayo, Antioch, TN

Donald P. & Dayna L. Gunn, Mt. Zion, WV

Donald Pickens, Ripley, WV

Donald R Sandidge, Edmonton, KY

Donald Radcliffe, Raleigh, NC

Donald Shull Jr. and Melissa Shull, Waynesboro, TN

Donna G. & Orman C. Johnston, Milton, WV

Donnie & Mary Kay Kimball, West Union, WV

Donnie Fisher, Eleanor, WV

Donnita Englad, Edmonton, KY

Donzel & Patona Whiting, Ripley, WV

Dora Parsons, LeRoy, WV

Doris Davis, Harrisville, WV

Doris M. Boone, Harrisville, WV

Doris Miller, Dunbar, WV

Dorothy Carney, Diven, WV

Dorothy Gola, Reynoldsville, WV

Dorothy K. Wise, Milton, WV

Dorothy Mae Davis, Nanjemoy, MD

Dorsel H. Cobb, Red House, WV

Doug Rudd, Gas Analyst, New Jersey Natural Gas Company, Wall, NJ

Douglas & Jeanette Bendle, Antioch, TN

Douglas & Susan Miller, West Union, WV

Douglas L. & Valree A. Peralta, Antioch, TN

Douglas M. Hartwell, Liberty, WV

Dremia K. Miller, Salem, WV

Dulcie F. Carroll, West Union, WV

Dunfa Peng, Antioch, TN

Dupree M. & Erika N. Pinson, Antioch, TN

Dustin & Savannah Hardbarger, Brohard, WV

Dustin A. & Sarah N. Everman, Grayson, KY

Dustin Beaver, Fraziers Bottom, WV

Dustin Eli Whiteside, New Albany, MS

Dustin L. & Kaci Whitney, Antioch, TN

Dwain Stanley, Parkersburg, WV

Dwight & Tina Moore, West Union, WV

E. Mae Rhodes, LeRoy, WV

E. Sharon Sanford, Antioch, TN

E.P. Haught Heirs, Grantsville, WV

E.S. Childers Heirs c/o John Taylor, Huntingtown, MD

Earl Sommerville, Reedy, WV

Early M. & Chander D. Cash, Antioch, TN

East West Properties, Inc., Olive Hill, KY

Ebonnie M. Figgins, Antioch, TN

Ed Jividen, Red House, WV

Edd Tate Parker Living Trust, Oxford, MS

Eddie Vinay & Anousone Thespurinton, Antioch, TN

Edgar & Audrey Duelley, Coxs Mills, WV

Edgar & Shannon Atkins, etal, Ripley, WV

Edgar McCutcheon, Reedy, WV

Edith Groves, Ripley, WV

Edith Littleton, Morehead, KY

Edmond T. & Inge E. Conway, Antioch, TN

Edward & Iris Lee, Gay, WV

Edward C. & Coreen D. Jackson, Antioch, TN

Edward L. Cummings, Ripley, WV

Edwin L. & Stephanie D. Linzie, Antioch, TN

Edwin P. and Barbara J. Winters, Milwood, WV

Elaine J. Newsom, Antioch, TN

Elaine Taylor, Gallipolis Ferry, WV

Eleanore M. Fox, Glen Easton, WV

Electa J. Smith, Nitro, WV

Elenor Dyer, Nashville, TN

Elizabeth A. & Robert E. Ray, Antioch, TN

Elizabeth Garber, Nashville, TN

Ella & Roger Underwood, Salem, WV

Ella Lee & Ebony C. Beech, Antioch, TN

Elmer & Rose Thornberry, Grayson, KY

Elmer Bergum, Liberty, WV

Elmer L. Aston, Moundsville, WV

Elmer W. Pierce, West Union, WV

Elton C. & Susan H. Felts, Antioch, TN

Elwood P. & Elizabeth Rill, Glen Rock, PA

Emerson Lewis Jr., Grayson, KY

Emery Casto, Leon, WV

Emily Cobb, Red house, WV

Emma Swanson, Red House, WV

Emmitt C. & Dorothy H. Nicholas, Culloden, WV

Emory H. & Elsie C. Smith, Antioch, TN

Ereny & John Yakoub, Antioch, TN

Eric Bernhardt, TRC, West Union, WV

Eric Duvall, Grayson, KY

Eric Engle & Ashley Stover, Ripley, WV

Erick Bergman, Antioch, TN

Erik Duncan, Charleston, WV

Erin Cornell, Red House, WV

Ernest E. Lanham, Newburg, WV

Ernie E Gilkes, Antioch, TN

Ernie R. Pritt, West Union, WV

Eron & Cathy Diane Hatchett, Antioch, TN

Estate of Joe Nelson, Attn: Greg Nelson, Scott Depot, WV

Ethel Irene Barker, Morehead, KY

Eugene & Shirley Carra, Grayson, KY

Eugene Depue, Harrisburgh, NC

Eugene Testamentary Trust, Imperatore, Antioch, TN

Evans Equipment Rental, Evans, WV

Evelyn Davila, Winfield, WV

Everett RIchards, Jr, Canton, OH

Evie Parke, Summer Shade, KY

Fadhila A. Al-Jazairi, Antioch, TN

Falon Felts, Antioch, TN

Falton O. & Cornelia Mason, Oxford, MS

Family Cemetery c/o Regina Lemley, Reader, WV

Faye Rogers, Ripley, WV

Federal National Mortgage Association, Dallas, TX

Ferenc & Luz C. Andi, Antioch, TN

Fidelity Bank, Wichita, KS

Flora Conley, Red House, WV

Floyd & Daniel Melott, New Martinsville, WV

Forest Jr. & Tina Glover, Jacksonburg, WV

Foster & Terri Lyons, Ripley, WV

Fran & Ollie Cole, Antioch, TN

Frank & Donna Race, West Union, WV

Frank C. & Paula S. Wilkens, Antioch, TN

Frank E. Larson, Creston, WV

Frank K., Jr & Mia M. Vickers, Antioch, TN

Frank Randolph, West Union, WV

Frank Simons, Sterling, VA

Franklin Cunningham, Pine Grove, WV

Franklin T. Barker, West Union, WV

Fred E. Barnes, Nashville, TN

Fred R. & Frances L. Dailey, Milton, WV

Fred Strickland, Clinton, OH

Fred W. Kirby Jr., Parkersburg, WV

Freda Casto, Given, WV

Freda E. Byrd, Berea, WV

Frederick & Barbara Hall, Ripley, WV

Frederick & Jo Ann Perry, Barboursville, WV

Frederick E. & Kimberly A. Davis, New Cumberland, WV

Fredrick & Mary Boyce, Ripley, WV

Freo Tennessee, LLC, Tampa, FL

G. Yancey, Antioch, TN

Gail Stalnaker, etal, Kenna, WV

Gail Thompson, Given, WV

Gary & Jackie Carney, Given, WV

Gary & Joyce Rizer, Antioch, TN

Gary Clendenin, St. Albans, WV

Gary Cooper, Brohard, WV

Gary Douglas, etal, Valley City, OH

Gary E. Guy, BGE - Chief FERC Counsel, Baltimore Gas & Electric Company, Baltimore, MD

Gary Erwin, Hurricane, WV

Gary J. Belt, Chardon, OH

Gary R. Rose, Leon, WV

Gary Stewart, Charleston, WV

Gayle Carter, Grayson, KY

Gena D. Smith, LeRoy, WV

Gene Kuehner, Reedy, WV

George & Barbara Adrian, New Milton, WV

George & Blanche Caudill, Morehead, KY

George & Susan Gagnon, West Union, WV

George B & Suzette L Bradford, Grayson, KY

George C., Jr & Lillian L. Hawkins, Antioch, TN

George Cullers, Salem, WV

George Jr & Beverly Allin, Antioch, TN

George K & Shirley & Jana F Conley, Grayson, KY

George Lagos, Moundsville, WV

George R. Gore, West Union, WV

George Stansberry, etal, West Union, WV

George T. & Sherre R. Mayes, Norton, OH

Gerald & Geraldine Carra, Grayson, KY

Gerald F & Christi M Thompson, Grayson, KY

Gerard Elswick, Ravenswood, WV

Gerawork Tesfaye & Seblewongel Ejigu, Antioch, TN

German M. Baratto & Marielena Ramos, Antioch, TN

Gerson Woodlands, LLC, Flushing, NY

Gertie Hill, Grayson, KY

Gholam & Sevda Kheshti, Brentwood, TN

Gilbert Painter, Winfield, WV

Ginger Richman, Director, NJR Energy Services Company, Wall, NJ

Gini Mogan, Reedy, WV

GJ Syew LLC, Grayson, KY

Glen and Ruth Thompson, c/o Wade Thomas Thompson, Ashland, KY

Glen O.Gibson, Hurricane, WV

Glenda & Norris Morris, Antioch, TN

Glenn & Ramona Cunningham, Proctor, WV

Glenn Long, et al, West Union, WV

Glenn Painter, Winfield, WV

Glenn R Mann, Ripley, WV

Glenn R. Jr & Sharon Mann, Ripley, WV

Glenn Doyle & Fay Thompson, Ripley, WV

Gloria Faye Coleman, Antioch, TN

Gloria Jean Nunn, Summer Shade, KY

Glyne A. Griffith, Antioch, TN

Goran & Marijana Kebara, Antioch, TN

Gordon E. O'Dell, St Albans, WV

Gordon Yost, etal, Reader, WV

Grace C. Omatu, Antioch, TN

Grant F. Redd, Moundsville, WV

Greg & Michelle Taylor, Antioch, TN

Gregory & Crystal Dulaney, Pine Grove, WV

Gregory B. Carroll, Culloden, WV

Gregory D. Hatfield, Culloden, WV

Gregory K & Jayne A Clinton, Paint Lick, KY

Gregory T. Simmons, Associate, Cullen and Dykman LLP, Washington, DC

Greystone Properties, LLC, Brentwood, TN

Guillermo L. & Julia C. Valencia, Antioch, TN

Guss Kelley, Salem, WV

Gwin & Robert Orr, Antioch, TN

Gwyen T. & Allen Yancey, III, Antioch, TN

H & H Construction Inc., Greenwood, MS

H3, LLC, Milton, WV

Haessley Land & Timber, LLC, Marietta, OH

Hamilton & Moore LP, Nashville, TN

Hannah E. Toney, Red House, WV

Harold & Helen Edens, Ripley, WV

Harold & Ruth Bell, Big Springs, WV

Harold B. & Connie S. Crow, Moundsville, WV

Harold D. Villers, Elizabeth, WV

Harold W. & Lucy A. Sullivan, Culloden, WV

Harry & Patricia Bradley, Big Springs, WV

Harry Allred, Fraziers Bottom, WV

Harry Beasley, Charleston, WV

Harry C. Goudy, III, Easton, MD

Harry D. Barker, Smithville, WV

Harry G. Cooke, Jr., Pineville, WV

Harry L. Allfred, Fraziers Bottom, WV

Harvest Homes, LLC, Brentwood, TN

Harvey Ghiz, Hurricane, WV

Haught Farms, LLC, Harrisville, WV

Hayes Living Trust, Grayson, KY

Hayward R. Davis, Salem, WV

Heartwood Forestland Fund IV, LP, Parkersburg, WV

Heather & Jason C. Mcgovern, Antioch, TN

Heather Hixson-McGovern, Keep Southeast Nashville Healthy, Cane Ridge, TN

Heber & Sandra Richardson, Dunbar, WV

Hector Martinez, Antioch, TN

Heirs of James Henson, Buffalo, WV

Heisel & Myrtle Ledsome, Reedy, WV

Helen & Donald Casto, Given, WV

Helen K. White, Ripley, WV

Helen R. Payne, Moundsville, WV

Helin S. Tahir, Antioch, TN

Henry Arvis & Elizabeth Riffe, Grayson, KY

Henry Caudill Jr & Teresa L. Caudill, Morehead, KY

Heran Berwary, Antioch, TN

HFP, LLC, Kenova, WV

HG Energy, LLC, Parkersburg, WV

Hidden Creek Homeowners Assn Inc., Nashville, TN

Hindes Farm Trust, Attn: Donald & Betsy Hindes, Columbus, OH

Hneng Thang & Khaw A. Ling, Antioch, TN

Hoa Thi Nguyen & Van Huang Lich, Antioch, TN

Holly Ashby, Antioch, TN

Holly Greene, Nashville, TN

Homer & Delores Weekley, West Union, WV

Hong K. & Young M. Yang, Antioch, TN

Hope Natural Gas Company, Clarksburg, WV

Howard & Clara Bucher, Reader, WV

Howard C. Burchett, South Charleston, WV

Howard Hollow LLC, Edmonton, KY

Huey Moore, Arbuckle, WV

Hundred Resources, Inc., Fairmont, WV

Hurley-Y, Murfreesboro, TN

I. L. (Ike) Morris, Attn: Steve Holloway, Glenville, WV

I.C. Young Estate, Glen Easton, WV

Ifeoma C. Nwankwo, Antioch, TN

Illena Booher & Donald J Thomas, West Union, WV

Imelda A Reynolds, Grayson, KY

Inez Brotherton, LeRoy, WV

Irene Nocilla, Nashville, TN

Isaac & Stephanie Selbe, Ripley, WV

Isabelle Snider, Lake Milton, OH

J. H. Lowther Estate Attn: Rob Lowther, etal, Columbus, TX

J. Jeannie Myers, Senior Counsel, Chevron USA Inc., Houston, TX

J. W. Owens, Antioch, TN

J.D. Geelhaar, New Milton, WV

J.F. Crow Estate c/o Lloyd Baker, Moundsville, WV

Jack & Bonnie Tracy, Antioch, TN

Jack & Joan Blazer, New Milton, WV

Jack & Julie Campitelli, Antioch, TN

Jack & Rick T. Yeager, Dunbar, WV

Jack Black, Milton, WV

Jack F. Davidson, Waynesboro, TN

Jack Garton, Red House, WV

Jackie L. Scott, Eleanor, WV

Jackie R. & Carolyn S. Bailey, Red House, WV

Jaclyn & Dalaina McLaughlin, Fraziers Bottom, WV

Jacqueline Moore, LeRoy, WV

Jacqueline R. Monaghan, Antioch, TN

Jamal S. Albarati, Nashville, TN

James & Angela Bland, West Union, WV

James & Arnold Campbell, Grayson, KY

James & Betty McCoy, Jacksonburg, WV

James & Christopher Bithell, Irwin, PA

James & Cynthia Hodgson, Parkersburg, WV

James & Ester Miller, Washington, WV

James & Gary K. Bunner, Belleville, WV

James & Heather Patrick, Chester, SC

James & Joretta Ritchea, New Martinsville, WV

James & Linda LeMasters, West Union, WV

James & Melanie Pierson, Ripley, WV

James & Roberta McCoy, Smithville, WV

James & Sharron Lindsey, West Union, WV

James A. Haggard and Annette Haggard, Waynesboro, TN

James and Jennifer Patrick, Louisa, KY

James Andrew Wiley, Antioch, TN

James B. Stanford (LE) C/O Samantha Morris, New Albany, MS

James BoHannon, Given, WV

James Booth Estate, Steubenville, OH

James C. Moore, New Martinsville, WV

James C., Romie L., Kelly, & Brian Milhoan, LeRoy, WV

James D & Sharon Kay Kretzer, Grayson, KY

James D. Dunbar, Leavittsburg, OH

James E. Futrell, Et Ux, Antioch, TN

James E. Snyder, etal, Charleston, WV

James Gossett Et Ux, Franklin, TN

James H. & Deborah D. Sullivan, Antioch, TN

James Herbert Maggard, Catlettsburg, KY

James Johnson, Grayson, KY

James L. Cummings, Milton, WV

James L. Shier, Mill Valley, CA

James Luke Roberson, New Albany, MS

James M. Winter, Ripley, WV

James Marshall, Reedy, WV

James N. Tokarski & Donna M. Harvey, Antioch, TN

James N. Tokarski, Antioch, TN

James Newton Dominey, Jr & Brooke A. Dominey, Antioch, TN

James O. Frye, Jr, Antioch, TN

James O. Shannon & Dale E. Shannon, Antioch, TN

James Olson, Vinson & Elkins LLP, Antero Resources Corporation, Houston, TX

James Panaro, Eleanor, WV

James Patty, LeRoy, WV

James R. Carden, Culloden, WV

James Ray & Star E Carroll, Morehead, KY

James R-R Martin Boone Et Al, Borchard, WV

James Shier, Mill Valley, CA

James T. Ester & Heather H. Hayes, Antioch, TN

James W. Barber Et Ux, Antioch, TN

James Webb, West Union, WV

Jamshid Mirzamukhamedov & Gulchekbra Ibragimova, Antioch, TN

Jane Immerfall, Antioch, TN

Jane Watson, Mcmechen, WV

Janet Cain, Given, WV

Janet Hodge, Smithville, WV

Janet Hodge, Smithville, WV

Janet Sue Nolan Miller, etal, Pine Grove, WV

Janet Vanfleet & Linda D. Virkus, Antioch, TN

Janet Wair & Victor Nolasco, Antioch, TN

Janice E. Miller, Milton, WV

Janice Ellifrill Cox, West Union, WV

Janice McIntyre, Big Bend, WV

Janice Petersen, Ripley, WV

Jared & Lora Hughes, Ripley, WV

Jarrett Depue, Vienna, WV

Jason & Casey Napier, Barboursville, WV

Jason K Davis, West Union, WV

Jason McGovern, Cain Ridge, TN

Jason T. & Virginia F. Howell, Antioch, TN

Jason Travis, West Union, WV

Javier & Yvonne Solis, Antioch, TN

Jean R. & Kelda R. Altidor, Antioch, TN

Jeff & Mary Goforth, Antioch, TN

Jeff L. Kern, Administrator, KO Transmission Company, Cincinnati, OH

Jeff Morgan, Nashville, TN

Jeff Perryman, FERC Compliance Manager, Atmos Energy Corporation, Dallas, TX

Jeffery & Ashley Shelton, Nashville, TN

Jeffery D. Cobb, Eleanor, WV

Jeffery S. Starcher, Winfield, WV

Jefff Yarbro, Nashville, TN

Jeffrey and Lorie Callihan, Morehead, KY

Jeffrey Burdette, Reedy, WV

Jeffrey C. & Mary L. Black, Culloden, WV

Jeffrey Callihan, Morehead, KY

Jeffrey David & Robin Lynn Wilcox, Grayson, KY

Jemal Mamma & Mariya M. Burka, Antioch, TN

Jenevi Nguyen, Antioch, TN

Jennifer A. Clemence, Antioch, TN

Jennifer Burke, Naperville, IL

Jennifer M. Johnson, West Union, WV

Jennifer Patton, Red House, WV

Jennifer R. Villaeal, Antioch, TN

Jennifer Tomlin, Nashville, TN

Jermaine Smith, Antioch, TN

Jerry & Diana Legg, Red House, WV

Jerry & Greta Williams, Browns Mills, NJ

Jerry & Karen Mason, Reader, WV

Jerry D. & Martha Myers, Exton, PA

Jerry Davis, Milton, WV

Jerry Don & Jennifer Johnson, Antioch, TN

Jerry L. Sparks, Grayson, KY

Jerry L. Walker, Buffalo, WV

Jerry M Garmon, Edmonton, KY

Jerry M. Booth, Wellsburg, WV

Jerry W. Slater, Ripley, WV

Jerry Walters, Jacksonburg, WV

Jesse & Miranda Walker, Antioch, TN

Jesse Rhodes, Ripley, WV

Jesse & Cathy Napier, Culloden, WV

Jessica Kerr, Antioch, TN

Jill Montgomery Barker, Mineral Wells, WV

Jimmie & J. Roberta Templeton, Milton, WV

Jimmy D. Hill, Et Ux, New Albany, MS

Jimmy Dean Parker C/O Ed Stacy, Morehead, KY

Joan & Clellan Warmoth, Paint Lick, KY

Joan Eads, Buffalo, WV

Joan Runyon, Buffalo, WV

Joanne Palermo, Antioch, TN

Joanne Umstead, Antioch, TN

Jodi Collier, Grayson, KY

Joe Casto, Ripley, WV

Joe Henderson, Benwood, WV

Joe M. & Glenna R Brammell, Grayson, KY

Joe Singer, Nashville, TN

Joel & Lauren Evrist, Antioch, TN

Joel & Rosa Perales, Antioch, TN

Joey B. Tolley, Eleanor, WV

John & Angela Coulter, Antioch, TN

John & Barbara McCrady, Mineral Wells, WV

John & Barbara Upton, Evans, WV

John & Brenda Cunningham, Ripley, WV

John & Chrystal Wilenski, Kissimmee, FL

John & Collette Turner, Ripley, WV

John & Kristie Manley, Ripley, WV

John & Linda Strickling, West Union, WV

John & Sandra Day, Paint Lick, KY

John & Tammy Chandler, Grayson, KY

John A. McMillan, Norton, OH

John A. Nixon, Jr & Jana L. Nixon, Antioch, TN

John Arvel Caudill, Morehead, KY

John B. & Kelly L. Bancroft, Antioch, TN

John Berisford, Moundsville, WV

John Christman, Wellsburg, WV

John D. & Helen A. Northcutt, Morehead, KY

John D. Dobbs, Moundsville, WV

John D. Sadler Ii & Linda M. Hendrich, Antioch, TN

John E. & Karen Kurtz, Antioch, TN

John E. Allocca, Cullen and Dykman LLP, Washington, DC

John E. Kay, Reynoldsburg, OH

John Elswick, Hurricane, WV

John H. Mitchell, New Albany, MS

John Hudson, Jennings, OK

John III & Casey Coelho, Pembroke Pines, FL

John J. & Shantel E. Watson, Antioch, TN

John Jones, Brohard, WV

John K. Mason, Jr., Moundsville, WV

John Knight, Akron, OH

John M. & Connie S. Irrevocable Trust Underwood, West Union, WV

John M. & Bertha M. Frazier, Pullman, WV

John M. & Lovie F. Chapman, Milton, WV

John Mark Estes, et ux, Hurricane, WV

John Myer, New Martinsville, WV

John Nathan & Trista A Greer, Grayson, KY

John P. & Ann Stevens, Summer Shade, KY

John Parker, Moundsville, WV

John Phillip & Connie Gail Sturdivant, Antioch, TN

John R. Reed, Ripley, WV

John R. & D. Germaine Umstead, Pullman, WV

John Reid, LeRoy, WV

John Reynolds, Antioch, TN

John Rolfe, Inwood, WV

John Snider, Debra Morris & Lori L. Jenkins, Lake Milton, OH

John Stephens, Ripley, WV

John T. Parker, Moundsville, WV

John T. & Laurlee Howarth, Columbus, NJ

John W. Fore Jr., The Villages, FL

John W. Hall, Palestine, WV

Johnnie Harper, Red House, WV

Johnson & Goebel Inc., Grayson, KY

Jolene Jones, West Union, WV

Jon Kazmierski- District Ranger, Daniel Boone National Forest, Morehead, KY

Jonathan L. Wentworth & Monica J. Moore, Antioch, TN

Jonathan Lemin, Antioch, TN

Jonathan Wentworth, Nashville, TN

Jose D. & Yasmin Gonzales, Antioch, TN

Joseph & Anita Bianchini, Spotsylvania, VA

Joseph & Minnie Shiben, New Martinsville, WV

Joseph C. & Ordelia T. Redmon, Antioch, TN

Joseph D. & Joan F. Yeager, Antioch, TN

Joseph Dudley, Jacksonburg, WV

Joseph Hornbeck, New Martinsville, WV

Joseph Macca & John Giombattista, Nashville, TN

Joseph Moore, Arbuckle, WV

Joseph S. & Kelley A. Ellis, Antioch, TN

Joseph Vespa, Wheeling, WV

Josephine Donnahoe, West Union, WV

Josh Jefferson, Regional Economic Development Authority, Wheeling, West Virginia

Joshua & Sheena Wolfe, Given, WV

Joshua C. & Kerri G. Wood, Culloden, WV

Joshua J. & Alyssa J Kurtz, Antioch, TN

Joshua Morris West & Denise Leann Fields, Antioch, TN

Joshua S. Gull & Alexandra M. Fontana, Antioch, TN

Joshua W & Tracy D Mcguire, Grayson, KY

Joshua W. & Amanda C. Mangrum, Antioch, TN

Joyce A. and Eric V. Griffith, Catlettsburg, KY

Joyce Eidon & Kesiena Idahosa, Antioch, TN

Joyce S. Boggess, Southport, NC

Joylyn C. Benson, Antioch, TN

Juanita M. Leggett, West Union, WV

Judith C. Andrews, Antioch, TN

Judith King Vulcano, Trustee, Antioch, TN

Judy Ann Howard, Tomkinsville, KY

Judy Caudill, Morehead, KY

Julia Yuan, Ellicott City, MD

Julie Kerns, Glen Easton, WV

Julius M. Shook, Antioch, TN

Justin Adams, Culloden, WV

Justin Casto, Liberty, WV

Justin Lucas Caudill, Morehead, KY

Justin Morehouse, Morehead, KY

Kaine Howard & Angela McCombs, Proctor, WV

Kalil & Vyan Sofi, Antioch, TN

Kamiran Abdalrahman & Berivan Mhsen, Antioch, TN

Kamton Kunce, Cane Ridge, TN

Karen Bell & Roger Dunham, Glen Easton, WV

Karen Cooper, Parkersburg, WV

Karen Gribben, Eleanor, WV

Karen Miles, Catlettsburg, KY

Karen Neal, Antioch, TN

Karen Sue Prim, Harrisville, WV

Karen Tabor, Culloden, WV

Karin M. & Brian M. Cook, Antioch, TN

Kat Cadle, Culloden, WV

Katherine A. & Nolan Fall, Antioch, TN

Katherine Allen, Red House, WV

Katherine C. Tierny & Seth B. Cox, Antioch, TN

Katherine L. Blake, Antioch, TN

Katheryn Barter, West Union, WV

Kathleen & David Vandenbergh, Thompsons Station, TN

Kathleen & Steven D. Carter, Antioch, TN

Kathryn A. Weed, Charleston, WV

Kathy Fraley, Olive Hill, KY

Kathy Phillips, Reader, WV

Keith & Angela Nelson, Antioch, TN

Keith A & Kathryn Y Forster, Grayson, KY

Keith Brotherton, LeRoy, WV

Keith G. Donahue, Culloden, WV

Keith Miller, Reedy, WV

Keith Smith, Grayson, KY

Kelley A. Woodside, Antioch, TN

Kelly & Denise Davis, West Union, WV

Kelly Tucker, Buffalo, WV

Kelly Wilson, Antioch, TN

Kelsey Y. & Nichole R. Williams, Antioch, TN

Kelvin & Tracey Lusk, Antioch, TN

Kelvin E. & Kathryn D. Creameans, Milton, WV

Kema Sabe Inc., Tupelo, MS

Kendall B. & Tracy J. Hodge, Harrisville, WV

Kendall Marie Stevens, Summer Shade, KY

Kenneth & Kimberly McCloy, LeRoy, WV

Kenneth & Pauline Greer, Antioch, TN

Kenneth & Phyllis Martin, Taneytown, MD

Kenneth & Vicky Vandyne, Reader, WV

Kenneth Dale Nice, Jr., Pine Grove, WV

Kenneth E. Janiszewski, Cameron, WV

Kenneth L. & Donna B. Woodson, Old Hickory, TN

Kenneth L. & Phyllis Martin, Taneytown, MD

Kenneth P. Goodnight, Smithville, WV

Kenneth R. Fairchild, et al, Milton, WV

Kenneth & Sandra Bush, Reedy, WV

Kent & Joy Draughon, Antioch, TN

Kermit & Elouise Wolf, Leon, WV

Kermit & Reba Beaver, Fraziers Bottom, WV

Kevin & Cindy Means, New Milton, WV

Kevin & Kristin Miller, Ripley, WV

Kevin B. & Karen R. Campbell, Antioch, TN

Kevin Brown, etal, Ripley, WV

Kevin E. & Colette L. Black, Antioch, TN

Kevin G. & Tyler J. Ream, Sissonville, WV

Kevin Hyer, Antioch, TN

Kevin L. & Michelle M. Rowe, Antioch, TN

Kevin McGilton, Moundsville, WV

Kevin Ream, Sissonville, WV

Kevin Stidam, Morehead, KY

Kevin Sweeney, John & Hengerer, Washington, DC

Kevin Warco, Harpers Ferry, WV

Kevin Warco, Harpers Ferry, WV

Kiedaisch & Summers Enterprises, Harrisville, WV

Kihun & Misoon Kim, Antioch, TN

Kim Brainard, et al c/o Lee Justice, Grayson, KY

Kimberly Blevins, etal, Leon, WV

Kimberly D. White, Antioch, TN

Kimberly J. Workman, Given, WV

Kimberly K. Reed, Westlake, TX

Kingdom Hall of Jehovah's Witnesses, Ripley, WV

Kip & Sandra Blake, New Martinsville, WV

Kitty S. Munday, Elizabeth, WV

Kledith & G. Geraldine Chapman, Hurricane, WV

Kristen Whittle, Antioch, TN

Kristian Morgan, Antioch, TN

Kristin Henke & Brian Meyers, Antioch, TN

Krystin M. Worsham, Administrative Assistant, Calpine, Houston, TX

Kurt Krieger, Member, Steptoe & Johnson PLLC, Range Resources-Appalachia, LLC,

Charleston, WV

Kyle L & Kara N Wilson, Grayson, KY

L. Alan & Carolyn C. Smith, Trustees, Antioch, TN

L. C. Lewis, Jr & Monica A. Lewis, Antioch, TN

L.J. Sauter, Arlington, VA

Laerece & Rose Wolfe, Mount Alto, WV

Landon & Cheryl McCoy, Ripley, WV

Larry & Brenda Whetzel, Glen Easton, WV

Larry & Joan Williams, Salem, WV

Larry & Pamela E. Casto, Ripley, WV

Larry & Patricia Dotson, etal, Ripley, WV

Larry & Peggy Ridenour, LeRoy, WV

Larry & Susan Tucker, Reedy, WV

Larry B. Dadisman, Charleston, WV

Larry C., Mary A., Randy S., Shawn L., Brandy L., Dutton, & Kenneth S. Kinnard, Culloden, WV

Larry Conant, Belleview, WV

Larry D & Tina Gearlds, Tomkinsville, KY

Larry D. II & Joyce E. Epling, Spencer, WV

Larry E. & Joyce A. Fetty, Milton, WV

Larry Haggard, Waynesboro, TN

Larry M. Haggard and Hilda Haggard, Waynesboro, TN

Larry Mullins, Brentwood, TN

Larry T. & Maresa L. Whaley, Antioch, TN

Larry W. Dawson, Einfield, WV

Larry W. Dawson, Einfield, WV

Larry & Susan Tucker, Reedy, WV

Lasonia Kimes, Antioch, TN

Laura A. Buchanan, Antioch, TN

Laura L. & Joy C. Staples, Antioch, TN

Laura S. Donahue, Culloden, WV

Lauren Duncan, Antioch, TN

Lauren Spires, Antioch, TN

LaVora Allums, Leon, WV

Lawrence W. Cain, Given, WV

Lee & Christine Amburgey, Paint Lick, KY

Lee & Sandra Reed, Ripley, WV

Lee Roy Wair (Le) & Dana Wair, Antioch, TN

Lemoin LeMasters, Wellsburg, WV

Leonor Rolfe, Inwood, WV

Leslie McCormick, Liberty, WV

Lester & Angela Sanchez, Ripley, WV

Lester & Mia Ramsey, Ripley, WV

Lethia T. Lewis, Antioch, TN

Lewis & Darlene Wagner, Palestine, WV

Lewis F. Maxwell, New Milton, WV

Leyla Ibadova, Antioch, TN

Lillian & Patrick Cayton, West Union, WV

Lillian Hawkins, Antioch, TN

Lillian R. Bartee, West Union, WV

Lillian Raynes, Eleanor, WV

Lincoln M. Gwinn, Antioch, TN

Linda & John Strickling, West Union, WV

Linda Bailey, Red House, WV

Linda Bennett, MacClenny, FL

Linda Cogar, West Union, WV

Linda D. Lindley, Antioch, TN

Linda G. Gardner, Antioch, TN

Linda Gooch, North Huntingdon, PA

Linda L. Blosser, Reedy, WV

Linda Wallace, LeRoy, WV

Linda West, Charleston, SC

Linda Whittaker, Antioch, TN

Lindsay G. Bland, Antioch, TN

Linn & Mary Davis, Atwater, CA

Lisa and John Paesano, Follansbee, WV

Lisa Davis Heller, St. Marys, WV

Lisa Davis Heller, St. Marys, WV

Lisa Kidd, Morehead, KY

Lisa Michelle Simpkins, Environmental and Fuels Policy, Exelon Corporation, Baltimore, MD

Lisa R. Chao, Antioch, TN

Little Kanawha Area Development Corporation, Elizabeth, WV

Lloyd & Betty Prine, Nitro, WV

Lloyd S. Hughes, Morehead, KY

Lloyd V. & Patsy C. Maddoux, Antioch, TN

Lo Eva F. Clanton, Holcomb, MS

Lois J. Young, Hurricane, WV

Lona S. Blankenship, Culloden, WV

Long Hoang & Tu Phan, Antioch, TN

Lonnie Blake, New Martinsville, WV

Lora Price, West Union, WV

Loretta Lee Ferguson Bingham, Calhoun City, MS

Lori A. Pierson, Ripley, WV

Lori Birckhead, Joelton, TN

Lori Johnson, Cane Ridge, TN

Lori Lundin, Wellsburg, WV

Lori Zimmerle, Nashville, TN

Lornamire Williams, Nashville, TN

Lorraine L. Guth, Antioch, TN

Lou Anne Scott, Antioch, TN

Lou Rife, Nashville, TN

Lowell & Selma Humphreys, Ripley, WV

Lowell & Terri Clay, Barboursville, WV

Lowell E. & Jeannette Parker, Antioch, TN

Lucy E. Harper, St. Petersburg, FL

Luis & Barbara Ferrar, Bloomington, IL

Luke & Joyce Moody, Antioch, TN

Lyndall & Deborah Williams, Culloden, WV

Lynwood K. Ireland, Pullman, WV

M & M Trust by Jarrell Mairs, Sissonville, WV

M & R Investments, LLC, Birmingham, AL

M4 Midstream, LLC, Durango, CO

MAC LLC, Vienna, WV

Magna Development Corp, Brentwood, TN

Marc Scholl, Ripley, WV

Marcia Adams, Nashville, TN

Marcus & Sheri Wood, Moundsville, VA

Marcus C. & Marie C. Razo, Antioch, TN

Marcus M. Williams & Jephanie S. Price, Antioch, TN

Marcy Webb, Nashville, TN

Margaret Cartozzo, Antioch, TN

Margaret McIntyre-Williams & James McIntyre, Snellville, GA

Margot B. Crowder, West Union, WV

Marie Waybright, Ripley, WV

Marielena Ramos, Nashville, TN

Marilyn & Paul Dracos, Antioch, TN

Marine & Charles Rush, Summer Shade, KY

Marion J. Owens, Red House, WV

Marjorie Bell And Ruth Cobb (LE), New Albany, MS

Mark & Rebecca Miles, West Union, WV

Mark A. & Kimberly R. Mozingo, Antioch, TN

Mark A. & P.M. Wainwright, Antioch, TN

Mark A. Hutson, Salem, WV

Mark Daniel & Courtney G. Cornette, Grayson, KY

Mark E. & Abra Niemiec, Antioch, TN

Mark Heath, Frankfort, KY

Mark Hileman, Salem, WV

Mark J. Porter, Charleston, WV

Mark P. Williford, Jr., Antioch, TN

Mark R. & Justie D. Kouns, Hitchins, KY

Mark Travierso, Antioch, TN

Mark Vincent & Mark Christopher Schumacher, Bridgeport, WV

Markwest Liberty Midstream & Resources, LLC, Denver, CO

Marla Hicks & Melissa Moss, Summer Shade, KY

Marshall & Loretta Strickland, Ripley, WV

Martha Bragg C/O Philip Shive, Summer Shade, KY

Martin L. Haggard Jr. and Tina Haggard, Waynesboro, TN

Mary & Awad Fadlallah, Antioch, TN

Mary & George Powell, Cane Ridge, TN

Mary Crandell Living Trust, Akron, OH

Mary E. Egan, Batavia, OH

Mary Frances Kouns, Grayson, KY

Mary Ganiel, Ripley, WV

Mary L. Glaspell, West Union, WV

Mary L. Harshbarger, Milton, WV

Mary Lou Anderson, Huntington, WV

Mary M. Scites, etal, Ripley, WV

Mary Rose, Leon, WV

Mary Sansom, Cross Lanes, WV

Mary Wildfire, Spencer, WV

Mary Ann P. Nease, Given, WV

MaryAnn P. Nease, Given, WV

Mason Dixon Farms, LLC, Melboure, FL

Matt Arcaini, Cane Ridge, TN

Matt Franklin, Versailles, KY

Matt Huff, Nashville, TN

Mattew Evan Hall, Ripley, WV

Matthew & Cynthia Grace, Antioch, TN

Matthew & Regina Griffith, Grayson, KY

Matthew D. & Ashleigh M. Grawford, Red House, WV

Matthew Guest, Cane Ridge, TN

Max Flesher, Reedy, WV

Max Hardin Shaw and Carolyn Shaw, Waynesboro, TN

Maxwell G. Mitchell, Antioch, TN

McIntyre Cemetery c/o Mike Waybright, Elkins, WV

Meagan J. Keiser, Statoil Natural Gas LLC, Stamford, CT

Medhanit Ayalke, Antioch, TN

Megan J. & Christopher S. Parker, Antioch, TN

Meghan Gruebner, Eversheds Sutherland (US) LLP, Washington, DC

Melba J. Templeton, Sistersville, WV

Melinda J. Gathers & David L. Jones Etal, Lenoir City, TN

Melissa Hutchinson C/O Rhonda Wright, Paden City, WV

Melissa L. Wheeler, South Point, OH

Melissa Thorner, Hurricane, WV

Melody Benedict, Antioch, TN

Melvin Leek, Pine Grove, WV

Melvin Ray Kelley, Grayson, KY

Mercedes L. Martinez & Manuel Rodriguez, Antioch, TN

Meredith L. & Kevin L. Powell, Antioch, TN

Metro Gov't RP Real Property Service, Nashville, TN

Mi H. Kim, Antioch, TN

Micah Hargrove, Mill Creek Watershed Association, Nashville, TN

Michael & Dulcie Bonnell, Des Moines, IA

Michael & Janet Nicholson, New Milton, WV

Michael & Kathy Knopp, Ripley, WV

Michael & Peggy J Suttles, Grayson, KY

Michael & Sherry Henson, Berea, WV

Michael & Tracy Rine, Glen Easton, WV

Michael & Velva Lasure, New Martinsville, WV

Michael & Vicki C. Norman, Palestine, WV

Michael A. & Katrina Oberholzer Spencer, Antioch, TN

Michael A. Powell & Barbara R. Pafeti, Antioch, TN

Michael A. Whetzel, Glen Easton, WV

Michael A. & Christine R. Murphy, Milton, WV

Michael C & April D Tooley, Grayson, KY

Michael C. Rush, Wileyville, WV

Michael E & Libby Caudill, Morehead, KY

Michael E. Goodrich, Lake Milton, OH

Michael Eplin, Barboursville, WV

Michael Eugene Caudill & Justin Caudill, Morehead, KY

Michael Foster, Buffalo, WV

Michael Greer & Anthony Cunningham, Antioch, TN

Michael J. & Susan Lorusso, Salem, WV

Michael Jones, Goodlettsville, TN

Michael L. & Charlene Fiorentino, Antioch, TN

Michael L. O'Donnell, Moundsville, WV

Michael M. Dickerson, Parkersburg, WV

Michael Milhoan, Reedy, WV

Michael O'connell, Antioch, TN

Michael P. & Ellen J. Livingston, Antioch, TN

Michael Romans, Pinehurst, NC

Michael Ross, Nashville, TN

Michael Rozenboom, Antioch, TN

Michael Snider, Smithville, WV

Michael Stover, Leon, WV

Michael V. Waybright, Elkins, WV

Michael & Miranda N. Freeman, Huntington, WV

Michelle Dove & Troy B. Tomlinson, Bealeton, VA

Michelle Henderson, Antioch, TN

Michelle Joan Bahner, Antioch, TN

Michelle L Stover, Liberty, WV

Michelle N Motzer, Grayson, KY

Michelle R Mendoza, Manager, Pipeline Services, Piedmont Natural Gas Company, Inc.,

Charlotte, NC

Mickey & Latisha Lundy, Antioch, TN

Mickey & Charlotte Poole Trust, Lake Frederick, VA

Mike Pannell, New Albany, MS

Mike Ross INC, Buckhannon, WV

Mike Younger, White Creek, TN

Milan & Melanie Reeves-Miller, Antioch, TN

Mildred Collins, etal, Ravenswood, WV

Mildred Jackson, Milton, WV

Milford Greene, Ripley, WV

Millard C. Boggess, Leon, WV

Millard F. Riggs, Sr., Harrisville, PA

Milton L. Carney, Ripley, WV

Mirijana Beram, West Union, WV

Misty Arrington Burton, Grayson, KY

Mitchell & Connie Lamb, Paint Lick, KY

Mitchell I. Lankin Etux and Gina Lynne Mitchell Lankin, New Albany, MS

Mitchell Lamb, Paint Lick, KY

Mohammed, Antioch, TN

Moufeed Hannaalla & Susan Tadros, Antioch, TN

Mountain View Estates HOA, Ripley, WV

Mt. Salem Revival Grounds, West Union, WV

Mt. Zion Methodist Church, Grantsville, WV

Nahid Sedaghat, Los Angelas, CA

Nam Van Tran, Antioch, TN

Nancey Lee Rexrode, Friendly, WV

Nancy L. Hamann & Margaret G. Moore, Antioch, TN

Nancy L. Stone, Given, WV

Nathan Mitchell & Lila M. Pryor, Antioch, TN

Nathaniel & Myra-Belle Martin, Pine Grove, WV

Neil E. Eads, Buffalo, WV

Nelda F. Gill, Smithville, WV

Nenna L. Davis, Harrisville, WV

Nicholas A. & Jenna D. Lilly, Antioch, TN

Nicholas D. & Kathryn N. Sinas, Antioch, TN

Nick Caudill, Morehead, KY

Niles G. & Sharon R. Ashley, Mineral Wells, WV

Nina A. Fields, Ravenswood, WV

Nora A. Reimoning, Antioch, TN

Norfolk Southern RR, Philadelphia, PA

Norma Davis, Pennsboro, WV

Norma Grace Dean, New Milton, WV

Norma J. Carnell, Nitro, WV

Norma K. Jones, Brohard, WV

Norman & Nancy Keeney, Westminster, MD

Norman Devol, Parkersburg, WV

Oak Highlands Homeowners Assoc, Inc., Antioch, TN

Oak Highlands/Deer Valley Homeowners Assoc Inc., Nolensville, TN

Oil Gas & Industrial Historical & Association, Parkersburg, WV

Olen D. Archer, Palestine, WV

Olga P. Nita, Antioch, TN

Olivia S. & Lamar B. Barker, Antioch, TN

Ona Laurabell Ayers, etal, Smithville, WV

Ona Laurabell Ayers, etal, Smithville, WV

Orland K. & Barbara L. Greenleaf, Reedy, WV

Orpha Hale Heirs c/o Thomas Hale, Big Springs, WV

Otis Waybright, Washington, WV

P H Glatfelter Company, Chillicothe, OH

P. Scott & Pillar Harris, Liberty, MO

Pamela & William Skotnicki, Ripley, WV

Pamela Cole Grigsby, Killen, AL

Pamela I. Murphy, Akron, OH

Pamela Wu, Morgan Lewis & Bockius, LLP, Washington, DC

Pannell Farms Partnership, New Albany, MS

Pansy I. Rush, Reader, WV

Parke K Butts Estate C/O Glenda Ruth Butts, Glasgow, KY

Pat and Steve Owens, Cane Ridge, TN

Patricia Nolan (Land Contract Buyer), Pine Grove, WV

Patrick & Penny Price, West Union, WV

Patrick J. Tarmey, Senior Counsel, FERC Regulator, National Grid, Waltham, MA

Patrick L. Morris, Sistersville, WV

Patrick Merritt, Antioch, TN

Patrick Scott King, Ripley, WV

Patsy BoHannon, Given, WV

Paul & Teresa Sagraves, Grayson, KY

Paul & Vanessa Hall, Smithville, WV

Paul Blake, Life Estate, New Martinsville, WV

Paul D. Hardman, Smithville, WV

Paul David Nutter, II, Harrisville, WV

Paul F Forshay, Attorney, Eversheds Sutherland (US) LLP, Washington, DC

Paul M. & Cathy S. Rice, Grayson, KY

Paul Newland, Grayson, KY

Paul S. & Teresa Dunbar-Patterson, Antioch, TN

Paul Schmucker, Reedy, WV

Paul Stout, Baltimore, MD

Paul U. Garber, Dundee, OH

Paula Prunty, Millwood, WV

Pauline F. Parsons, Ripley, WV

Pearl K. Morton, Rainier, WA

Peggy A. Whitaker, Antioch, TN

Penny Day, New Martinsville, WV

Perry J Russell Testamentary Family Trust Bill Calvert Jr Trustee, Mount Sterling, KY

Pete Peterson, Antioch, TN

Peter A. Miller, Moundsville, WV

Peter Anthony & Wendy J. Garcia, Antioch, TN

PHH Mortgage Corp., Mount Laurel, NJ

Philip M. & Shelia C. McMillan, West Union, WV

Phillip & Edith Steele, Antioch, TN

Phillip & J. Craig Thorne, Parkersburg, WV

Phillip & Jill Barker, Mineral Wells, WV

Phillip A. & Kimberley D. Garton, Antioch, TN

Phillip B. Davis, Antioch, TN

Phillip Barker, Mineral Wells, WV

Phillip Jason Stephenson, ESQ, Vice President, General Counsel, Vectren Corporation,

Evansville, IN

Phillip Michael Garner, Antioch, TN

Phoebe D. Sharp & David J. Beresford, Antioch, TN

Phoebe Denise Ross, Antioch, TN

Phouthasack & Khammouane Boupharath, Antioch, TN

Phylanice A. Nashe, Antioch, TN

Phyllis Elkins, Ironton, OH

Phyllis Gillispie, Hurricane, WV

Piedmont LLC, Durham, NC

Pine Oaks Properties Two, LLP, Nolensville, TN

Pingxi Xu & Xiaojing Xi, Davis, CA

Pleasant Hill Baptist Church Trustees, New Albany, MS

Preston Groce C/O Ruth J. Capps, Summer Shade, KY

Progress Residential 2015-2 Borrower LLC, Tampa, FL

Quinette Ezell, Antioch, TN

R.L. Hall, Pine Grove, WV

Rachel E. Julian & Anne M. Harding-Julian, Antioch, TN

Rachel Perry, Charleston, WV

Ralph & Judith Valentine, West Union, WV

Ralph & Robin Holmes, Moundsville, WV

Ralph Ferrebee Jr., Industry, PA

Ralph Lacy, et ux, West Union, WV

Ralph M. & Lisa M. Wair, Sr., Antioch, TN

Ralph Thacker & J. Maurice Carlisle Jr., Boonsville, MD

Ralph W. & Brenda K. Bassett, Jr., Culloden, WV

Randall L. & Janet L. Workman, Buffalo, WV

Randall L. & Janet L. Workman, Buffalo, WV

Randall Moody, Antioch, TN

Randall Ray Maggard, Catlettsburg, KY

Randall Russell, West Union, WV

Randolph Alan Huffman, Et Ux, Antioch, TN

Randy & Lisa A. McDowell, Cameron, WV

Randy Bevis, Waynesboro, TN

Randy S. Epling, Ripley, WV

Randy Taylor Revivals, West Union, WV

Ray and Debra K. Newland, Grayson, KY

Ray Jr. & Nancy Swecker, Charleston, WV

Raymond & Cindy White, Glen Easton, WV

Raymond & Garald Clevenger, Harrisville, WV

Raymond & Linda Heilman, Atwater, OH

Raymond A. Claxton, Et Ux, Antioch, TN

Raymond E. Shreve, Ripley, WV

Raymond E. Worrell, Jr., Antioch, TN

Raymond J. & Patricia Devries, Antioch, TN

Reba M. Scales, Antioch, TN

Rebecca J. Winter, Ripley, WV

Rebekah Loyd, Antioch, TN

Rebwar A. Hawez, Antioch, TN

Reed C. Deitz, Huntington, WV

Regina Enochs, Antioch, TN

Reid H. & Sarah E. Tinsley, Antioch, TN

Rexall M. Crislip, etal, New Milton, WV

Rhonda & Cleo Sivert, Scio, OH

Richard & Brenda Greene, Ravenswood, WV

Richard & Carolyn Unger, Antioch, TN

Richard & Elizabeth Brown, West Union, WV

Richard & Geraldine Markus, Antioch, TN

Richard & Jeanette Saskowski, Antioch, TN

Richard & Sarah Hite, Saint Albans, WV

Richard & Sarah Hite, Saint Albans, WV

Richard & Vickie Shultz, West Union, WV

Richard and Becky Kratzenberg, Grayson, KY

Richard Barrett & LJ Barrett, Edmonton, KY

Richard Bryan, Antioch, TN

Richard D. Bralow, TransCanada, Houston, TX

Richard Dale Painter, Given, WV

Richard E. Parsons, Hurricane, WV

Richard Ford, Fairmont, WV

Richard Harman, Reader, WV

Richard Keith Given Revocable Trust, Given, WV

Richard Mullen, Mineral Wells, WV

Richard W. Withrow, Nitro, WV

Rick Apostolec, Martins Ferry, WV

Ricky D. & Linda J. Griffin, Antioch, TN

Ricky Fluharty, Pine Grove, WV

Ricky L. Rhodes, LeRoy, WV

Ricky V. Dooley, Red House, WV

Ricky Whitlatch, Glenn Easton, WV

Ricky Winemiller, West Union, WV

Ridgetop Capital, LP, McMurray, PA

Riley Walker, Antioch, TN

Roach Cemetery A/K/A Stony Point Cemetery, Reedy, WV

Robert & Arlene Bland, etal, West Union, WV

Robert Argo, Cane Ridge, TN

Robert & Condalora Collins, Barboursville, WV

Robert & Julie Cunningham, Wheeling, WV

Robert & Linda Johnson, Ripley, WV

Robert & Mary Roush, Ripley, WV

Robert & Mildred Maxwell, West Union, WV

Robert & Terri McCloy, Given, WV

Robert A. & Laurie B. Mertz, Antioch, TN

Robert A. & Miranda L. Hamilton, LeRoy, WV

Robert A. & Sherry A. Ramsey, Culloden, WV

Robert A. Anderson, III, Antioch, TN

Robert Bryan & Jayna Marie Ratliff, Antioch, TN

Robert Conley, Eleanor, WV

Robert Cress, Ellenboro, WV

Robert D. Jackson, Columbia Gas Transmission, LLC, Houston, TX

Robert E. McEldowner, Charleston, WV

Robert E. Orr, Antioch, TN

Robert G. & Mai Jen Gunter, Antioch, TN

Robert G. Wade, Glen Dale, WV

Robert G. & Geraldine M. Foster, Milton, WV

Robert Gary Clanton, Holcomb, MS

Robert Harris, Creston, WV

Robert Haught, etal, Glaucester, VA

Robert Hudson Hickman & Susan Pitts Hickman, New Albany, MS

Robert J & Brenda J Dudon, Grayson, KY

Robert J. & Priscilla G. Tabor, Culloden, WV

Robert K. Gillispie, Fraziers Bottom, WV

Robert Kenneth, John Paul, and Anthony Gene Martin, Sr., Salem, WV

Robert L. Clark, Moundsville, WV

Robert Lee Falls, LeRoy, WV

Robert M. Sullivan, Moundsville, WV

Robert Matheny, Mineral Wells, WV

Robert Merritt, Seth, WV

Robert Morris Cemetery, Reader, WV

Robert Munoz, Jr, Pinon Hills, CA

Robert O. Moore, Jr., Certificates Lead, Columbia Gas Transmission, LLC, Charleston, WV

Robert Olsen, Antioch, TN

Robert P. & Charita C. Gunter, Antioch, TN

Robert Parsons, Buffalo, WV

Robert Richard, Wheeling, WV

Robert S. Spires, Antioch, TN

Robert Swiger, New Milton, WV

Robert T. Ivy & Traci L. Yash, Antioch, TN

Robert Taylor, New Milton, WV

Robert Torman, etal, New Martinsville, WV

Robert Yeager, Pine Grove, WV

Roberta & Nancy Streets, Lewistown, PA

Roberta N. & Timothy Lee Brownlee, Antioch, TN

Roberta Parker, Antioch, TN

Robin Blakeman, Huntington, WV

Robin Davis, Poca, WV

Robin L. Duncan Lindsey, New Albany, MS

Robin Wright Albarran, Nashville, TN

Robyn Mccormack, Antioch, TN

Rodel Properties, Charleston, WV

Roderick & Angela Boyd, Antioch, TN

Roderick L & Dinah Bustetter, Grayson, KY

Rodney D. & LaDonna K. Patterson, Milton, WV

Rodney E. & Donna Rowe, Culloden, WV

Rodney Hitch, Morehead, KY

Rodney L. Smith, Liberty, WV

Rodney Smith, Liberty, WV

Rodney Wasner, Middle River, MD

Roger & Carol Clark, Moundsville, WV

Roger & Deanna Hodge, Harrisville, WV

Roger & Joetta Griffitts, Trustees, Washington Courthouse, OH

Roger & Stacy McClain, West Union, WV

Roger & Tammy Travis, West Union, WV

Roger D. & Charlotte M. Young, Palestine, WV

Roger D. & Debbie K. Skaggs, Grayson, KY

Roger D. & Deborah L. Yates, Grayson, KY

Roger Gumm, Grayson, KY

Roger K. Randolph Trust, Scott Depot, WV

Roger L. & Rebecca S. Kingery, Williamstown, WV

Roger Rotoni, Cane Ridge, TN

Roger Sparks, Sandyville, WV

Roger White, et ux, Buffalo, WV

Roger Woodard, Culloden, WV

Romie W. & Mary M. Maddox Revocable Trust, Manakin Sabot, VA

Ronald & Deanna A. Stewart, Palestine, WV

Ronald & Deanna Stewart, Palestine, WV

Ronald A. & Riley A. White, Spencer, WV

Ronald B Martin & Myrtle Martin, Morehead, KY

Ronald B. Jacobs, Hurricane, WV

Ronald Barnes, Howard, PA

Ronald Casto, Cleveland, OH

Ronald E Christian, Evansville, IN

Ronald Haynes, Reedy, WV

Ronald L. Law, Colliers, WV

Ronald Lee & Erica Roberts, Antioch, TN

Ronald Lee Stubbs, West Union, WV

Ronald T. Jennings, Director - Gas Supply, Baltimore Gas & Electric Company, Baltimore, MD

Ronald W. Aston, Weirton, WV

Ronette Adams-Taylor & Lawrence Taylor, Jr., Antioch, TN

Ronnell F. Griffin, Antioch, TN

Ronnie & Patricia Hager, Peytona, WV

Ronnie & Yvonne Wade, New Martinsville, WV

Ronnie Carl Doak, etal, West Union, WV

Ronnie Cunningham, Ripley, WV

Ronnie D. & Maria R. Evans, Antioch, TN

Ronnie D. & Ruby D. Morton, Milton, WV

Ronnie E. Nease, Antioch, TN

Ronnie L. & Kimberly D. Mayes, Milton, WV

Ronny Jared Goodpasture, Antioch, TN

Rosanna M. Neal, Milton, WV

Rose Boggess, Leon, WV

Rose Boggess, Leon, WV

Rose Lennon, Washington Gas Light Company, Washington, DC

Ross McPherson, Middleport, OH

Rover Pipeline, LLC, Houston, TX

Roy Lee & Pauline Brown, Morehead, KY

Roy Lee Dubree, Louisville, KY

Roy M. Noe, Paint Lick, KY

Royce & Royal Watts, Morgantown, WV

Ruby Ballenger, West Union, WV

Ruby Ballenger, West Union, WV

Rudy Bradley, Hurricane, WV

Rudy R. and Clyda L. Hester, Catlettsburg, KY

Rudy Raynes, Eleanor, WV

Ruel Jones, Nashville, TN

Russell & Carol Stackpole, Middlebourne, WV

Russell L. & Regina K. Hupp, Creston, WV

Russell Ray Payne, Antioch, TN

Russell Ripley, Milton, WV

Russell W. & Flista H. Hanshaw, Reedy, WV

Rutendo Farai Pasipanodya, Antioch, TN

Ruth E. Gaughan, Timonium, MD

Ruth E. Gibson, Grayson, KY

Ruth E. Phillips, etal, Harrisonburg, VA

Ryan J. & Michelle L. Riddle, Callahan, FL

Ryan N & Cooksey Brooke H Knipp, Grayson, KY

Ryan Talbott, Appalachian Mountain Advocates, Lewisburg, WV

Sabrina Williams, Antioch, TN

Sadik Yusuf Ahmed, Antioch, TN

Sally Keffer, Grayson, KY

Salt Rock Sewer Public Service, Ona, WV

Sam Cartozzo, Antioch, TN

Samantha J. & Stephen R. Swanson, Antioch, TN

Samara A. Jaffe, Cullen and Dykman LLP, Washington, DC

Samir Atwan, Nashville, TN

Sammy & Nancy Kozee, Grayson, KY

Samuel & Glenda Gilbert, Antioch, TN

Samuel & Sherri Hammett and Robert Hammett, Waverly, WV

Samuel & Wilma Morris, Reader, WV

Samuel A. Berry, Antioch, TN

Samuel and Clara Haught, Reader, WV

Samuel and Lesa McCrary, Antioch, TN

Samuel T. & Paula J. Weekley, West Union, WV

Samuel Witalley, Cane Ridge, TN

Samy N Badie Abd El Massih & Fadia Boutrous, Antioch, TN

Sandor Manyoky, Anchorage, AK

Sandra Bergum, Liberty, WV

Sandra Fertruy, Pine Grove, WV

Sandra Johnson, Grayson, KY

Sandra W. Jaudon, Nashville, TN

Sandy Joe & Lottie Faye Brady, Nashville, TN

Sandy Sonrel, Culloden, WV

Sarah Bradford, Antioch, TN

Sarah G. Novosel, ESQ, Senior VP and Managing Counsel, Calpine Corporation, Washington, DC

Sarhan A. & Aljowfi Salah, Wadad Mohamed Hizam, Antioch, TN

Scott Butler, Consolidated Edison Company of New York, Inc. and Orange and Rockland

Utilities, Inc., New York, NY

Scott Castlemen, Charleston, WV

Scott H. & Tram Mays, Antioch, TN

Scott J. & Bassma M. Phillips, Antioch, TN

Scott Kitchen, Scott Depot, WV

Scott Nickerson, Wheeling, WV

Scott Patrick & Franci Rena Burchett, Grayson, KY

Scott Russom, Antioch, TN

Sealand Waste LLC, Rush, NY

Sean T. Spradlin, Antioch, TN

Sean Wasmer, et al, Middle River, MD

Serena Bower, Parkersburg, WV

Sergio Guitierrez, Antioch, TN

Seth Justice, Grayson, KY

Shaikh Rahman & Nujat Jabeen, Antioch, TN

Shannon Tompson, Antioch, TN

Shara Farag, Antioch, TN

Sharon Christ, Reedy, WV

Sharon Garton, Red House, WV

Sharon J. Davis, Milton, WV

Sharon Lanham, Kenna, WV

Sharon Powell, Allison Park, PA

Sharon Tucker, Moundsville, WV

Shawn A. Glaspell, West Union, WV

Sheila D. Curtis, Antioch, TN

Sheila Fisher, Triadelphia, WV

Shelby Ann & Benjamin Phillip Peterson, Antioch, TN

Sheldon L. & Wendy D. Bailey, Red House, WV

Shelton & Rhonda Malone Cammon, Antioch, TN

Sherman & Arlita D. Black-Swanson, Antioch, TN

Sherman Swanson, Antioch, TN

Sherri Crane, St. Albans, WV

Shirley Jackson, Grayson, KY

Shirley P. Taylor, Culloden, WV

Shivan T. & Sipan T. Galnasky, Antioch, TN

Sibyl Haggard Et Al, Waynesboro, TN

Sidney W. Wair & Arthur E. Wair, Jr., Antioch, TN

Sidney W. Wair & Larry M. Mullins, Antioch, TN

Slema Walker, Buffalo, WV

Smithfield Foods Inc., Grayson, KY

Solaiman Chowdhury, Md, Antioch, TN

Sonia L. Byrd, Antioch, TN

Southern Jackson Co. Public Service Dist., Ripley, WV

Sparks Enterprises, Given, WV

Sperry Hardwoods, Salem, WV

Stacey Hagemeister, Nashville, TN

Stacey Lynn Hall, Antioch, TN

Stacy L. & David W. Cox, Antioch, TN

Stanford Village Homeowners Association, Nashville, TN

Stanley & Hilda Smith, Littleton, WV

Stanley & Rebecca Lewis, Charleston, WV

Stanley G. and Clara R. Alsip, Catlettsburg, KY

Stanley Morrison, Ripley, WV

Stanley Wheeler, Given, WV

Stephan Swanson, Antioch, TN

Stephanie & Scott Maclaughlin, Antioch, TN

Stephanie & Tyrone Dickerson, Antioch, TN

Stephanie M. Davis Moore, Grayson, KY

Stephanie Michelle Davis, Grayson, KY

Stephen & Pamela Moore, Ripley, WV

Stephen & Teresa Eagle, LeRoy, WV

Stephen A. & Norma J. Kiper, Grayson, KY

Stephen Caudill, Morehead, KY

Stephen F. Salese, Manager, FERC Matters, Direct Energy Business, LLC, Woodbridge, NJ

Stephen K & Jennifer H. Witthrow, Grayson, KY

Stephen Michael & Taylor Winters, Antioch, TN

Stephen P. Glover, Jacksonburg, WV

Stephen P. Winter, Ripley, WV

Stephen Parish & Katie L. Miller, Antioch, TN

Stephen Ryan Holbrook, Grayson, KY

Stephen Shepherd, Antioch, TN

Stephen T. & Miriam Tedeschi, Antioch, TN

Stephen T. George, Antioch, TN

Stephen & Myrna Farley, Life Estates, Fraziers Bottom, WV

Steve McDiffitt, Glen Easton, WV

Steve & Monica Bratton, Antioch, TN

Steven & Alvin Crane, St. Albans, WV

Steven & Amanda Carper, West Union, WV

Steven & Amanda Shaffer, Ripley, WV

Steven & Shirley Hawkins, Antioch, TN

Steven A. Browning, Barboursville, WV

Steven A. & Terrian J. Morrison, Culloden, WV

Steven Ferrusi, Antioch, TN

Steven G. Inman, Antioch, TN

Steven H & Mary Frances Shaffer, Grayson, KY

Steven V. & Cheri L. Call, Culloden, WV

Steven W. & Tanya Stone, Antioch, TN

Steven, William E., & Ronald S. Jones, & Lisa J. Haddock, Lawrenceburg, TN

Stonegate Mortgage Corporation, Dallas, TX

Stonewall Jackson Et Ux, Brentwood, TN

Storall King LLC, Grayson, KY

Stout Family Trust, Parkersburg, WV

Sucheta Misra, Antioch, TN

Sue Ann Spiker, Jane Lew, WV

Sugar Valley, GP, Murfreesboro, TN

Suong T. Tran & Xuan Mai & Son T., Antioch, TN

Susan & Roger Walters, North Canton, OH

Susan B. & Geoffry A. Haddad, Charleston, WV

Susan C. (Sager) Caldwell, Harrisonburg, VA

Susan Couch, Cane Ridge, TN

Susan Francis, New Cumberland, WV

Susan Maher, Antioch, TN

Sutton Farms, LLC, Springfield, VA

Suzanne D. Goodman, Cane Ridge, TN

Suzanne Perry, Ripley, WV

Talton Family Investment LLC, Belden, MS

Tamara P. & Joseph A. Ross, Antioch, TN

Tamatha Cheke, Milton, WV

Tammy Beamer, Salem, WV

Tanja M. Marchman, Antioch, TN

Tawanda L. Bryant, Antioch, TN

Ted A. Garmon, Edmonton, KY

Ted W. & Maryna V. Miller, Antioch, TN

Teigh & Mary Byrne, New Milton, WV

Teresa L. Counts, Given, WV

Terrance L. Campbell, Ripley, WV

Terrence Allums, Leon, WV

Terri Parke, Summer Shade, KY

Terry & Carol Jean Hall, Morehead, KY

Terry Ash, Fairmont, WV

Terry Davis, Chester, WV

Terry Flesher, St. Johns, LF

Terry L. & Dawn D. Hudson, Antioch, TN

Terry L. Long, Mansfield, OH

Terry Norman, Antioch, TN

Terry Smith, Antioch, TN

Thad A. & Judith A. Edwards, Antioch, TN

Thanh Vo & Thuytien Thi Tran, Antioch, TN

The Estate of Ernest Goff, Harrisville, WV

The Haught Family Trust, Harrisville, WV

The Hite Family Trust, Marietta, OH

Theodore & Paula Adamerovich, Latrobe, PA

Thomas & Annette Clark, Glenn Easton, WV

Thomas & Brenda Smith, Smithville, WV

Thomas & Victoria Bates, West Union, WV

Thomas A. & Rachel N. Hoffman, Antioch, TN

Thomas Brian Rucker, Antioch, TN

Thomas F. Simmons Jr., Edgewater, MD

Thomas H & Melissa J Voeltz, Marietta, OH

Thomas J. Cummings Jr., Buffalo, WV

Thomas Miller & Jimmie Duke Reed, Chester, WV

Thomas P. Thackston, Associate General Counsel, Direct Energy Business, LLC, Woodbridge, NJ

Thomas R & Marcia L Riffe, Grayson, KY

Tiffany Michele Waugh, Grayson, KY

Tim Holt, New Albany, MS

Tim Roberson, New Albany, MS

Timmey Orr, Antioch, TN

Timmy & Elizabeth Morris, Reader, WV

Timothy & Amanda Parsons, LeRoy, WV

Timothy & Elizabeth Stalnaker, Antioch, TN

Timothy & Rebecca Clyne, West Union, WV

Timothy & Robin Schiele, Atwater, OH

Timothy Cart, Red House, WV

Timothy D. Carey, Antioch, TN

Timothy Edward and Erma Jane Cottrill, West Union, WV

Timothy G. & Susan B. Saxe, Barboursville, WV

Timothy J. & Becky J. Cooper, Red House, WV

Timothy Jordan, Red House, WV

Timothy S. Owens, Baltimore, MD

Timothy Tosh, Reedy, WV

Timothy Wells, New Martinsville, WV

Tina D. Dallison, New Martinsville, WV

Tina Del Prete, West Union, WV

Tina L. Osborne, West Union, WV

Tina L. Sampson, Antioch, TN

TLM LLC, Vienna, WV

Tod J. & Irene Faller, Culloden, WV

Todd & August King, Given, WV

Todd & Micah Dailey Douthit, Antioch, TN

Todd & Tracey Jones, Ripley, WV

Todd E. & Anna Roberson, Antioch, TN

Tomas S. & Roselle Abana, Antioch, TN

Tommy Bassett, Pine Grove, WV

Tommy H. Huff, Jr & Rachel E. Huff, Antioch, TN

Tommy Parke & Shirley Parke, Summer Shade, KY

Tony Kelly & Crystal R. Murphy, PHH Mortgage Corporation, Mount Lauren, NJ

Tony W. Weatherford, Et Ux, Antioch, TN

Traci Daun Wair Cooper, Antioch, TN

Tracy & Mary Beth, Troy & Deborah Wilson, Given, WV

Trampus Shannon, Astor, FL

Travis B. French, Waynesboro, TN

Travis L & Amanda Mccall, Grayson, KY

Trisha Kuhl, etal, Ripley, WV

Trixie Robinson, Augusta, WV

Troy Carpenter, Ripley, WV

Two Mile Real Estate, LLC, Parkersburg, WV

Tyler Lejeune, Antioch, TN

U.S. Bank National Association, Owensboro, KY

Vafa Alieyvali & Parisa Heidari, Antioch, TN

Valdeacourt Farm Limited Partnership, Charleston, WV

Valerie A. Lamb, Goleta, CA

Valerie Crockett, Tennessee Valley Authority, Chattanooga, TN

Vanessa Harmon, Leon, WV

Vanessa Harmon, Leon, WV

Veatrice E. Storey, Antioch, TN

Veril Blake, et al, Baltimore, MD

Vernon L. Randolph, Smithburg, WV

Veronica Mayes, Antioch, TN

Vester E & Peggy A Stephens, Grayson, KY

Vicki J. Livingston, Antioch, TN

Vicki Moore, Vandalia, OH

Victor & Peggy Smith, West Union, WV

Victor L. & Soutsaha Bustillo, Antioch, TN

Victor W. Burden, Antioch, TN

Viginia Parsons, Barboursville, WV

Vilma Acosta, Inwood, WV

Virgil Lee & Sue Messer, Grayson, KY

Virginia D. Tracy, Reader, WV

Virginia I. Milhoan, LeRoy, WV

Viscose Athletic Association, Eleanor, WV

Vivian Irene Ferguson, Holcomb, MS

Vivian Parks, etal, Pine Grove, WV

Vivian Stockman, Ohio Valley Environmental Coalition Project Coordinator, Huntington, WV

William & Marianne Hughes, Ohio Valley Environmental Coalition, Huntington, WV

Viyan Aziz & Hawar M. Hasan, Antioch, TN

W. Bracey & Allison B. Halbrook, Antioch, TN

W. C. Tate, New Albany, MS

W. Clyde Crane, Harrisville, WV

W. Garcia, Antioch, TN

W. Williams, Nashville, TN

Walker Thompson, Given, WV

Walter and Dorisann Mullins, Grayson, KY

Walter and Loretta Jeffrey, Milwood, WV

Walter L. & Amy J. Jacques, Antioch, TN

Walter Lee & Grace Jacques, Antioch, TN

Wanda & Gary Dillon, Culloden, WV

Warren Haught, Smithville, WV

Wayne Conley, Red House, WV

Wayne Douglas & Lora Art, Paint Lick, KY

Wayne L. Goddard, New Martinsville, WV

Welby J. Sandidge, Edmonton, KY

Wendy Romine, Reedy, WV

Wesley L. Landers Sr., Given, WV

West Virginia Properties LLC, Lakewood, OH

Wheeling Jesuit University, Wheeling, WV

William & Barbara Wagner, New Martinsville, WV

William & Georgette Healy, Smithville, WV

William & Geraldine Hensley, etal, Williamson, WV

William & Kara Casto, Ripley, WV

William & Kathy Johnson, Given, WV

William & Linda Hamilton, West Union, WV

William & Melissa Sheets, Ripley, WV

William & Pamela Heis, LeRoy, WV

William A. Sala, Jr., Sr. Counsel, TransCanada, Houston, TX

William and Rosemary Kartune, Grayson, KY

William B. Meador, Iuka, MS

William DePaulo, Director & Counsel, Keeper of the Mountains Foundation, Charleston, WV

William E. Walden, Antioch, TN

William Glenn Brannen, Antioch, TN

William J. & Ann M. Woods, Grenada, MS

William K. Stern, Glen Easton, WV

William L. Young, Et Ux, New Albany, MS

William P. Hatton, III, Antioch, TN

William Potter, Poca, WV

William R Milton, Culloden, WV

William R. & Janet B. Huffman, Antioch, TN

William R. Hardbarger, Harrisville, WV

William R. Milton, Culloden, WV

William Robert Helton Etux, Antioch, TN

William Trent, Elgin, IL

Williams Ohio Valley Midstream LLC, Attn: Amy DiMaria, Tulsa, OK

Willie S. Swanson, Et Ux, Antioch, TN

Young & Young Lumber Company, Inc., Nitro, WV

Yousef Khallilollahi & Heather Pham, Union City, CA

Yves J. Bourgeois, Manager Regulatory Affairs, Anadarko Energy Services Company, The Woodlands, TX


Zachary M. Blair, Glen Dale, WV


Zachary Raynes, Eleanor, WV

Zachery Shamblin, Ravenswood, WV

Mapping and Constructi	APPENDIX B-1 on Drawings for the I	Mountaineer XPress Pr	[,] oject

Mountaineer XPress Project
Project Overview Mapping

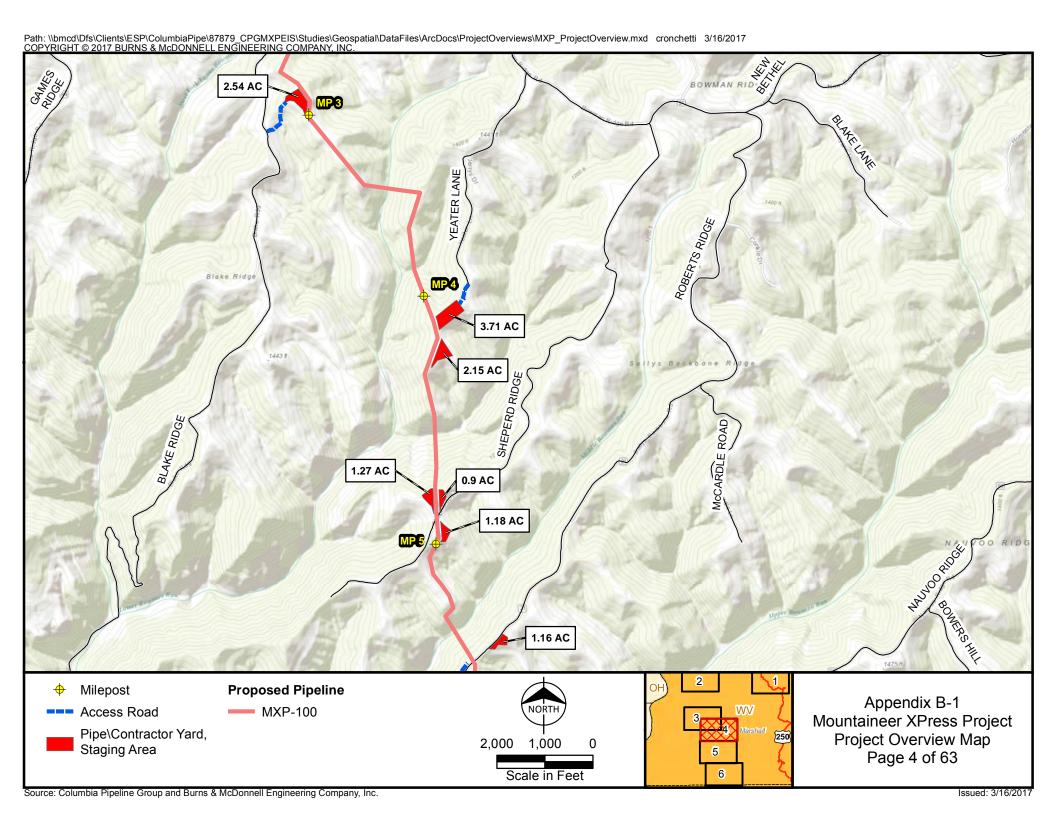

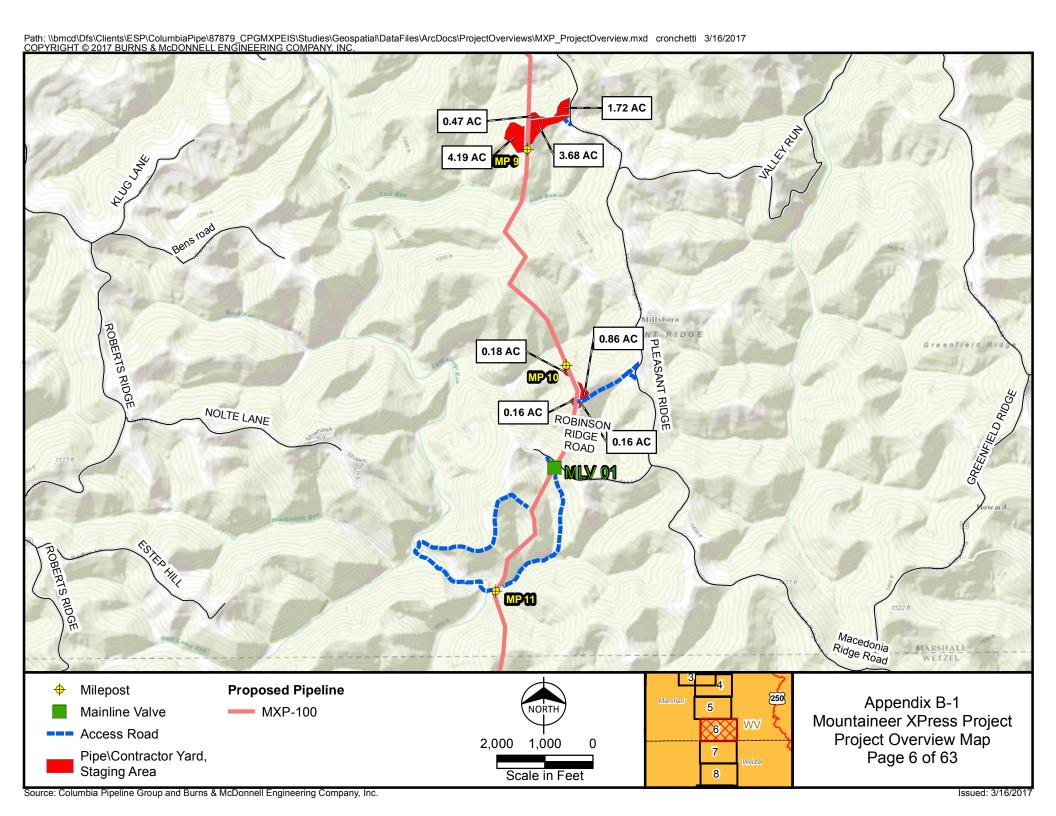


Issued: 3/16/2017


Source: Columbia Pipeline Group and Burns & McDonnell Engineering Company, Inc.


Scale in Feet


13

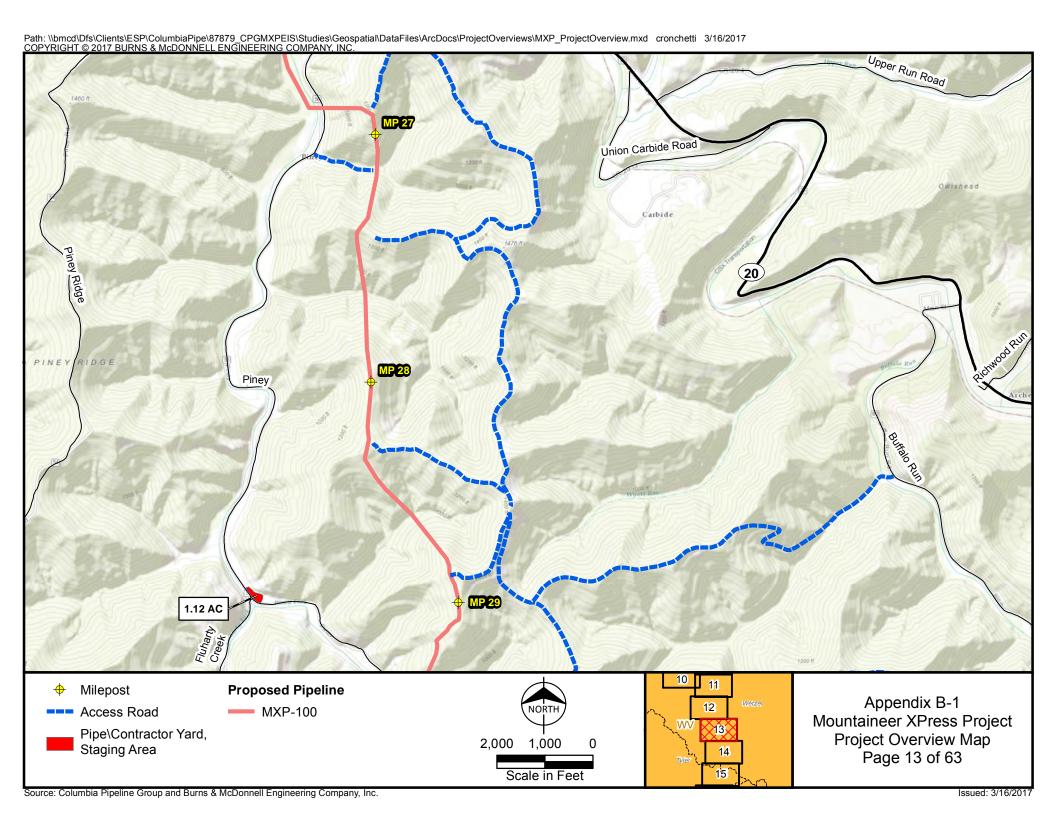



Scale in Feet

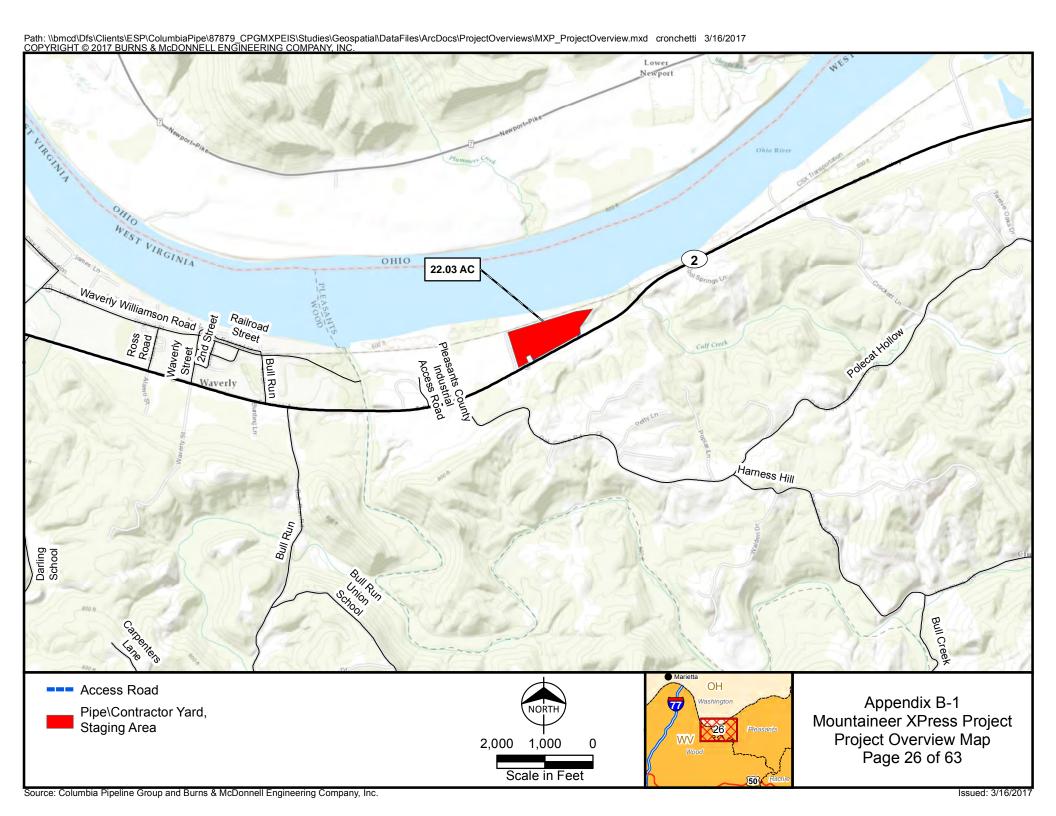


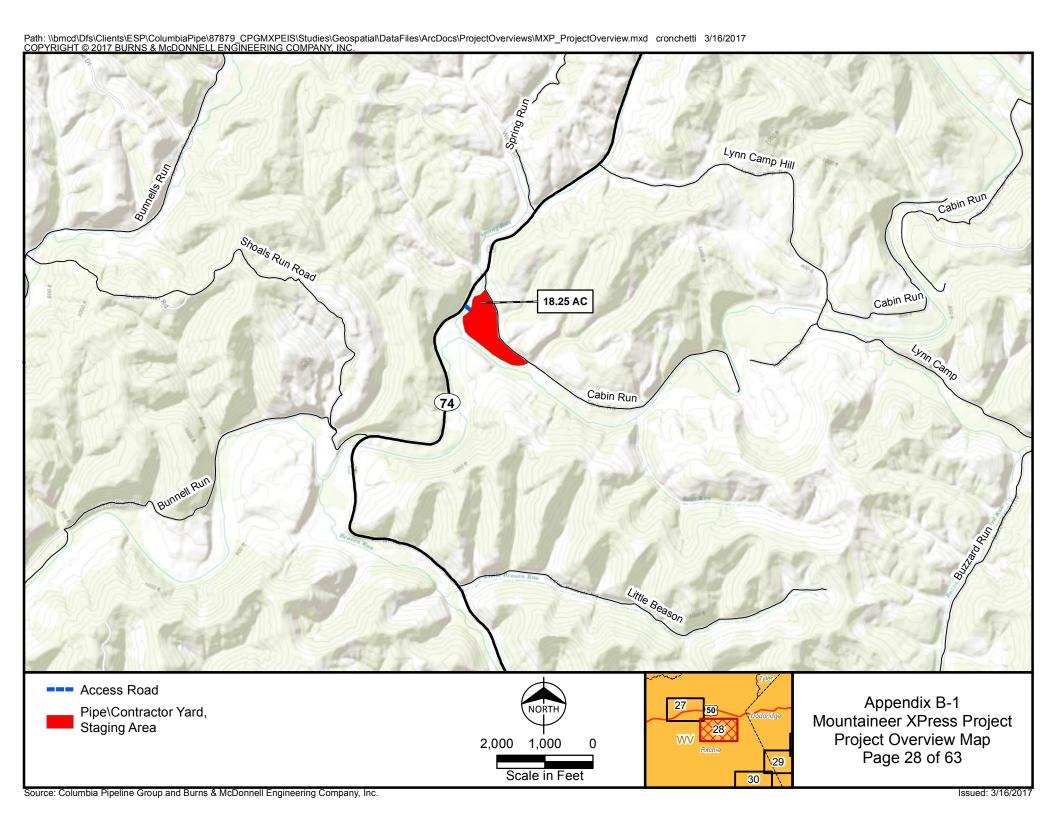

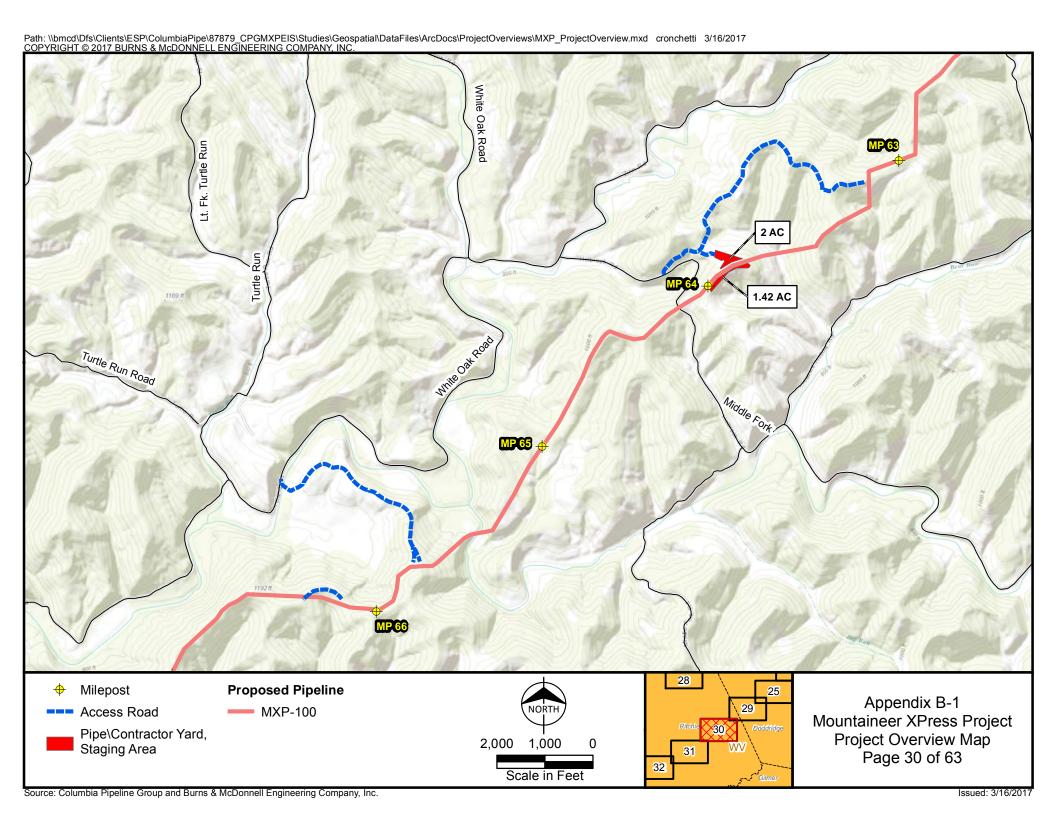


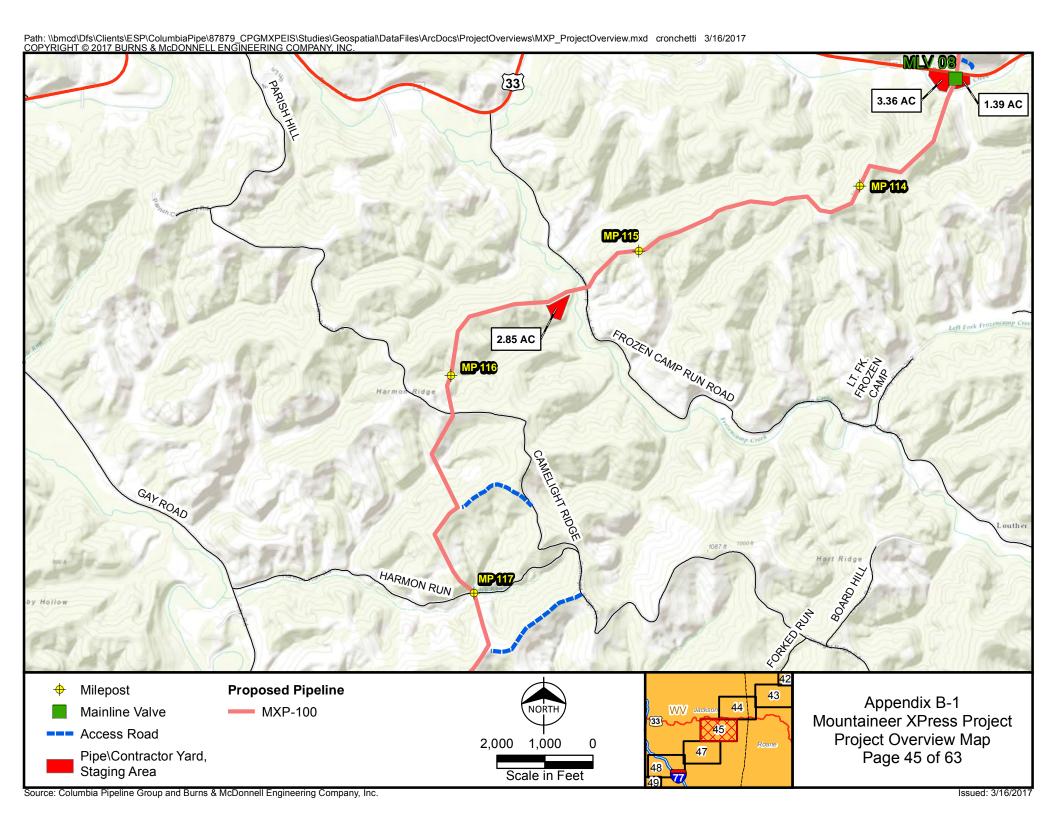

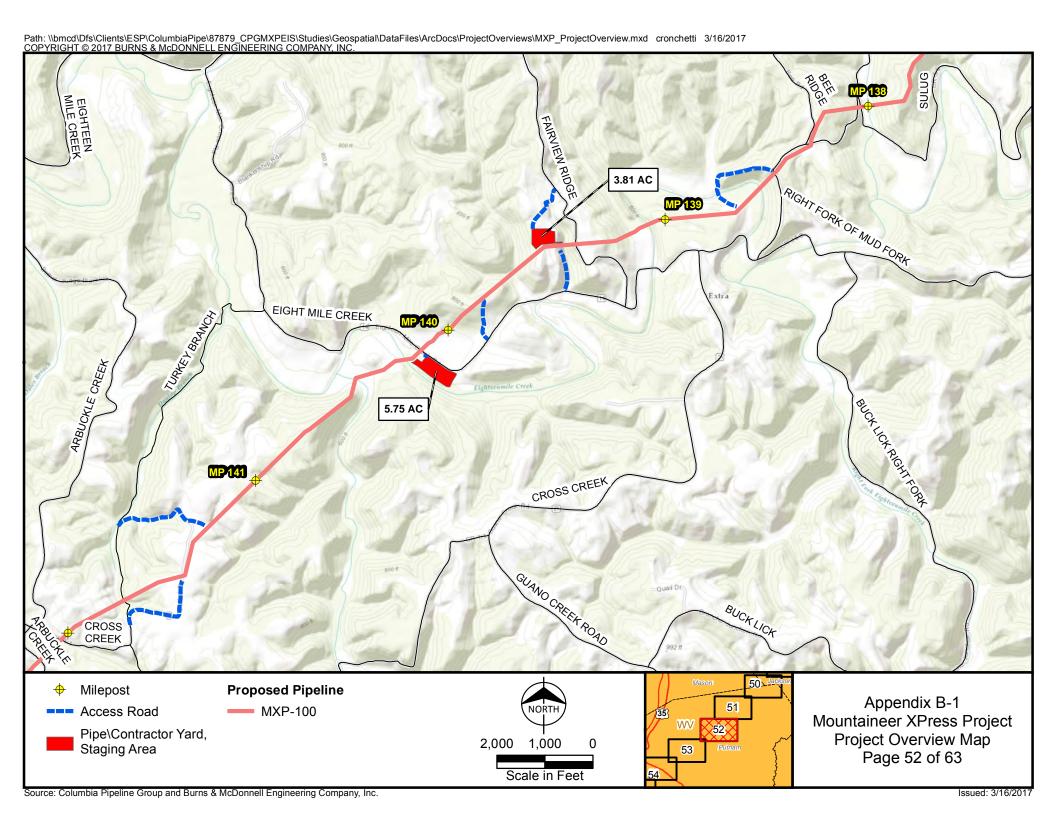

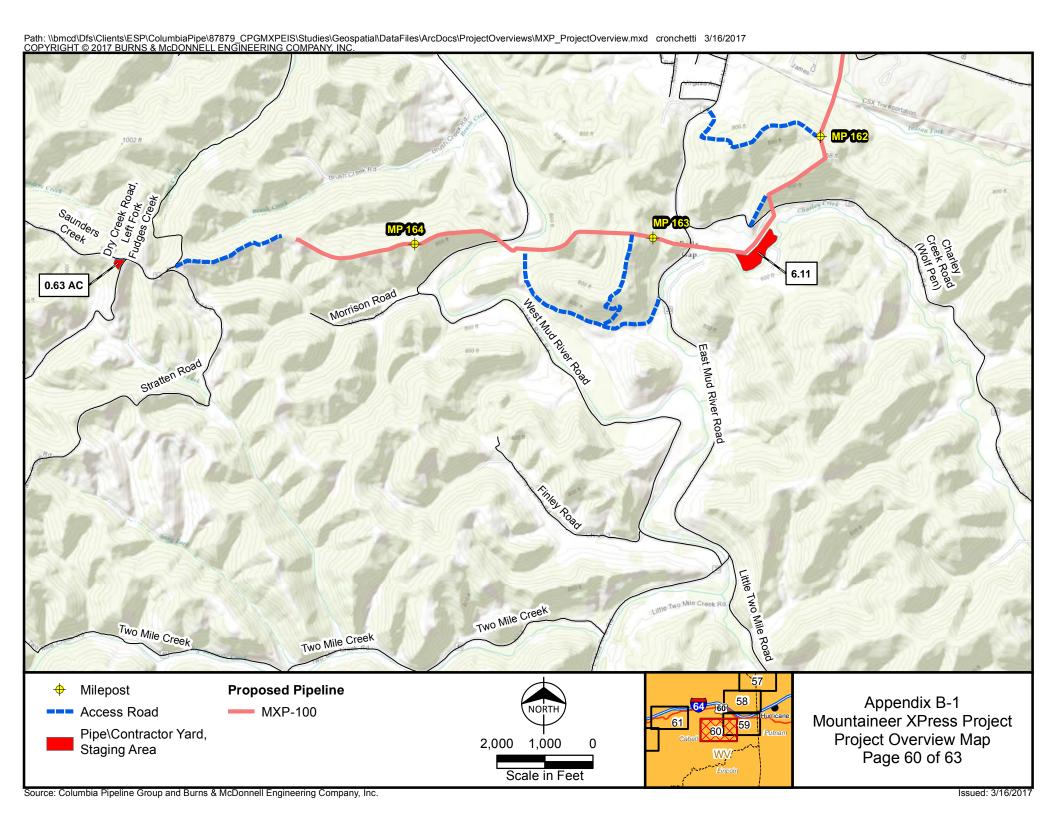

Mountaineer XPress Project
Site-specific Stream and Highway Crossing Drawings

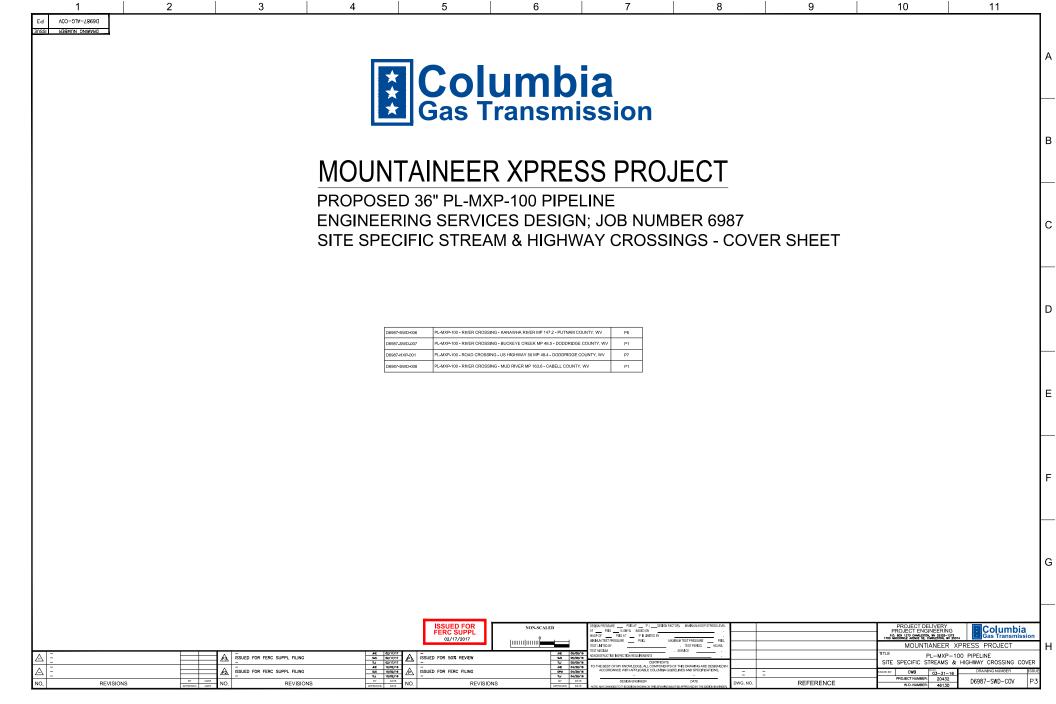

DODDRIDGE COUNTY. WEST VIRGINIA WV-D0-0256,000 WV-D0-0260.000 DIRECT PIPE ENTRY LAT. 39° 17' 14.438" US 50 ONG. -80° 42' 36.198 APPARENT N 833103.8748 O.W. FENCE 380' WIDE N39.286602 LONG: W80.710138 EXISTING ANTERO PIPELINE EXISTING ANTERO WATERLIN N39.286341* W80.710167 B-5 LONG: (WV-D0-0250,001) WASMER SEAN et al. MACHINE PIT RECEIVING PIT

PROPOSED 36" PL-MXP-100

US HWY 50 38' WIDE

ASPHALT ROAD

WV-D0-0249.001

ADDITIONAL TEMPORARY WORKSPACE

4/29/

SJO

PAR-0001 ACCESS ROAD NUMBER

SSUED FOR FERC DATA REQUEST

SSUED FOR FERC SUPPL FILING

REVISIONS

ACCESS ROAD


____X___EENCE

REVISIONS

- BOLITE

ISSUED FOR FERC FILING

ISSUED FOR 50% REVIEW

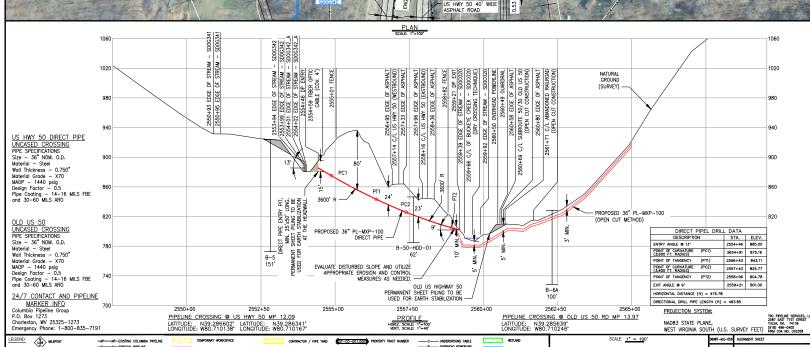

SJO


WATERROOT

ISSUED FOR PERMIT

ISSUED FOR FERC SUPPL FILING

REVISIONS

CC CANTADY STATE

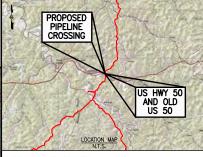

DIRECT BORE CONSTRUCTION NOTES:

EXISTING 1" PIPELINE (ABOVE GROUND)

YPICAL HOD ENTRY WORKSPACE

STATE RAIL AUTHORITY

SJC

M6067_999_004

MXP-100 RIVER CROSSING/BUCKEYE CREE

REFERENCE

TEMPORARY ROAD ENTRANCE ROCK PAGE

(WV-DO-0280.002)

DLD US 50 22' WIDE ASPHALT ROAD 110' R.O.W. SHEET PILING AS NECESSARY

THOMAS, DONALD & ILENA

(WV-DO-0250 002)

EXISTING DRIVEWAY TO BE BLOCKED

WITH DRUMS AT THE EDGE OF WORKSPACE

TO STABILIZATION EARTH

N39.285639* W80.710246

EXISTING DRIVEWAY TO BE LOCKED WITH DRUMS AT

THE EDGE OF WORKSPACE

B-6A

100v86

DIRECT PIPE EXIT LAT. 39° 17' 09.755"

N 832629.751

LONG. -80° 42' 36.722

- ALL EQUIPMENT MUST ACCESS THE SITE ALONG THE CONSTRUCTION RIGHT-OF-WAY OR FROM APPROVED ACCESS ROADS. NO VEHICULAR OR PEDESTRIAN TRAFFIC SHALL ENTER OR EXIT THE WORKSPACE FROM US 50.
- WORK SPACE: MAXIMUM WORK SPACE LIMITS ARE DEPICTED, RESTRICT CLEARING TO THE WORK SPACE INDICATED AT THE ENTRY AND EXIT POINTS AND PRODUCT PIPE STRINGING AND FABRICATION AREA ALONG THE CONSTRUCTION RIGHT-OF-WAY.
- WATER SOURCE: DRILL WATER AND HYDROSTATIC TEST WATER SHALL BE OBTAINED FROM AN APPROVED SOURCE.
- OBJUNED FROM AN AFFORMED SOURCE.

 HYDROSTATIC TEST: PRE-INSTALLATION HYDROSTATIC TESTS SHALL BE
 CONDUCTED IN ACCORDANCE WITH THE HYDROSTATIC TEST PLAN. TEST WATER SHALL BE SAMPLED AND TESTED IN ACCORDANCE WITH PERMIT REQUIREMENTS. THE TEST WATER SHALL BE USED IN THE DRILLING PROCESS OR DISCHARGED IN AN UPLAND AREA INTO AN EROSION CONTROL STRUCTURE AND/OR SILT FENCES, GEOTEXTILE FILTER BAG, OR COLLECTED IN A TRUCK AND HAULED TO AN APPROVED DISPOSAL SITE, UPON COMPLETION OF DEWATERING AND DRYING, A CALIPER PIG SURVEY SHALL BE COMPLETED IN ACCORDANCE WITH THE CONTRACT DOCUMENTS.
- SPILL-PREVENTION: REFUELING OF ALL EQUIPMENT SHALL BE COMPLETED IN ACCORDANCE WITH THE SPCC PLAN.
- ACCORDANCE WITH THE SPECE PENN.
 EROSION AND SEDIMENT CONTROL: CONTRACTOR SHALL SUPPLY, INSTALL AND
 MAINTAIN SEDIMENT CONTROL STRUCTURES IN ACCORDANCE WITH CONTRACT DOCUMENTS. CONTRACTOR SHALL INSTALL ADDITIONAL EROSION CONTROL STRUCTURES AS DIRECTED BY THE ENVIRONMENTAL INSPECTOR.
- INSTALLATION: THE DIRECT PIPE SHALL BE COMPLETED USING A HERRENKNECHT 36" DIRECT PIPE MICROTUNNELING MACHINE. CONTRACTOR WILL CONTINUOUSLY MONITOR THRUST PRESSURE AND PIPE DEFLECTION TO AVOID OVERSTRESS OF THE PIPE CONTRACTOR SHALL REPORT DAILY FEET OF PROGRESS, THRUST PRESSURES, VERTICAL AND HORIZONTAL DEFLECTION,
- OF PRODRESS, HENDEL PRESSURES, VERTICAL AND HORIZONIAL DEFLECTION, AND VARIANCE FROM THE DESIGN CLOVE.

 DRILLING FLUID DISPOSAL: CONTRACTOR SHALL DISPOSE OF EXCESS DRILLING ELUID AS DIRECTED BY COLUMBA'S REPRESENTATIVE IN ACCORDANCE WITH PERMIT CONDITIONS. UNDER NO CIRCUMSTANCES SHALL DRILLING FLUID BE PERMIT CONDITIONS: ONDER NO INCOMPANDES STANDE DIRECTOR FLUID BE DISPOSED OF IN WATER BODIES OR WETLANDS. ANY ORILLING FLUID WHICH INADVERTENTLY SURFACES AT POINTS OTHER THAN THE ENTRY OR EXIT POINTS SHALL BE CONTAINED AND COLLECTED TO THE EXTENT PRACTICABLE AND DISPOSED OF AS DIRECTED BY COLUMBIA'S REPRESENTATIVE IN ACCORDANCE WITH PERMIT CONDITIONS.

 CLEANUP/STABILIZATION/RESTORATION: ALL DISTURBED AREAS SHALL BE
- RETURNED TO THE ORIGINAL CONTOURS. DISTURBED AREAS SHALL BE SEEDED AS SPECIFIED IN THE CLEAN-UP AND RESTORATION REQUIREMENTS. IF THE FERRAIN ALLOWS AND ACCESS IS PERMITTED, CONTRACTOR SHALL UTILIZE LOW GROUND PRESSURE EQUIPMENT OR OTHER EQUIPMENT APPROVED BY COLUMBIA TO FACILITATE CONTAINMENT AND CLEAN-UP OF ANY INADVERTENT RETURNS THAT OCCUR DURING THE DIRECT PIPE INSTALLATION PROCESS.
- CONTRACTOR IS RESPONSIBLE FOR CALLING WEST VIRGINIA ONE-CALL AND LOCATING ALL UNDERGROUND UTILITIES PRIOR TO BEGINNING CONSTRUCTION.

 IF ANY UTILITY IS LOCATED WITHIN 15 FEET OF THE DESIGNED DIRECT PIPE IF ANY OHLIT SECOND WITHIN 13 FEEL OF THE DESIGNED DIRECT PIPE PROFILE AND ALIGNMENT, CONTRACTOR SHALL OBTAIN APPROVAL FROM COLUMBIA PRIOR TO INITIATING DIRECT PIPE OPERATIONS, IT IT IS THE CONTRACTORS RESPONSIBILITY TO IDENTIFY AND PROTECT ANY FOREIGN UTILITY THAT MAY BE AFFECTED BY THE DIRECT PIPE OPERATIONS.
- CONTRACTOR SHALL ADHERE TO THE SPECIFICATIONS AND REQUIREMENTS PER COLUMBIA'S SPECIFICATIONS, CONTRACT DOCUMENT AND SPECIAL PERMIT
- CONDITIONS, EXCEPT AS NOTED ON THIS DRAWING.

 14. ACCESS TO THE RESIDENTS WILL BE CONSTRUCTED PRIOR TO CLOSURE OF OLD HWY 50. THIS ACCESS IS NOTED ON THE DRAWING AS ARDOOO7.2 AND
- ARD0007 21 15. OLD HWY 50 WILL BE REPAIRED AND RECONSTRUCTED PER SHEET 2.

 16. REFER TO PSI GEOTECHNICAL REPORTS DATED APRIL 15, 2016 FOR B-5 AND
- B-6A. AND SUPPLEMENTAL REPORT DATED NOVEMBER 14, 2016 FOR B-50-HDD-01



Columbia PROJECT ENGINEERING TYPICAL WORKSPACE LAYOUT FOR DIRECTIONAL DRILL MOUNTAINEER XPRESS PROJECT PL-MXP-100 - ROAD CROSSING

US HIGHWAY 50 MP 48.4 - DODDRIDGE CO, WV

D6987-HXP-00

1 OF

- GENERAL NOTES:

 1. THIS DRAWING IS FOR PERMITTING PURPOSES ONLY.

 2. ALL TOWN AND MATERIALS WITHIN RIGHT—OF-WAY MUST

 3. NO IMPACTS TO THE PARKENIT STRUCTURE ARE ANTICIPATED

 THE PARKENIT STRUCTURE ARE ANTICIPATED.
- WITH BORE OR DIRECTIONAL DRILL CONSTRUCTION.
 ON ROADS WHERE OPEN-CUT CONSTRUCTION METHODS ARE USED, THE EXISTING ROAD SURFACE SHOULD BE RESTORED TO ORIGINAL CONDITIONS AFTER COMPLETION OF THE WORK.
- ORIGINAL CONDITIONS AFTER COMPLETION OF THE MORA.
 AFTER THIS LINE IS IN SERVICE, REPAIRS AND/OR
 REPLACEMENT OF THE INSTALLED PIPE WILL BE OUTSIDE OF
 THE ROADWAY RIGHT—OF—WAY WHEN POSSIBLE. WHEN THE THE ROADWAR RIGHT-OF-WAT WHEN PUSSIEL. WHEN IN REPAIRS ARE REQUIRED INSIDE OF THE ROADWAY RIGHT-OF-WAY, THE PIPELINE WILL BE ABANDONED BY REMOVING THE LINE FROM SERVICE, FILLING THE PIPE WITH AN APPROPRIATE GROUT, AND CAPPING BOTH ENDS. NEW CROSSING WILL BE INSTALLED A SAFE DISTANCE A WAY AND TIED INTO THE EXISTING PIPELINE.
- THE CONTRACTOR IS RESPONSIBLE FOR DETERMINING THE EXACT LOCATION, SIZES AND DEPTH OF ALL UTILITIES PRIOR TO
- LINE MARKERS WILL BE LOCATED AT THE ROAD RIGHT-OF-WAY LINES INDICATING THE ADDRESS AND TELEPHONE NUMBER OF OPERATOR AND THAT THE UTILITY IS A NATURAL GAS PIPELINE. WORK ZONE TRAFFIC CONTROL CASES C1 & C4 SHALL BE
- APPLIED AS SHOWN IN WYDOHS MANUAL ON TEMPORARY TRAFFIC CONTROL FOR STREETS AND HIGHWAY, 2006 EDITION.
 CONTRACTOR SHALL MAINTAIN 5 FEET COVER OVER PIPELINE
- WITHIN THE LIMITS OF THE ROAD RIGHT-OF-WAY ON NON-I IMITED ROADS AND 10' MINIMUM COVER OVER PIPELINE WITHIN THE ROADWAY RIGHT-OF-WAY FOR LIMITED ACCESS
- THE CONTRACTOR SHALL EXERCISE CARE TO AVOID DAMAGES TO
- ALL EXISTING UTILITIES.
 THIS GAS AND/OR PETROLEUM PIPELINE INSTALLATION AND MAINTENANCE TO BE DESIGNED TO MEET ALL RULES. REGULATIONS AND PIPELINE CRITERIA CONTAINED IN 49 CFR 192 AND/OR CFR FEDERAL SAFETY STANDARDS.
- CONTRACTOR TO INSTALL SHORING AS NECESSARY TO MAINTAIN STABLE PIPE TRENCHES.
- PIPE PROFILE REPRESENTS MINIMUM DEPTH OF COVER REQUIREMENTS. ACTUAL CONSTRUCTION DEPTH TO BE DETERMINED BASED ON SITE—SPECIFIC CONDITIONS.

- THE CATHODIC PROTECTION FOR THE PIPELINE WILL BE PROVIDED BY IMPRESSED CURRENT.
- NO EXCAVATION ANTICIPATED WITHIN THE WYDOH RIGHT-OF-WAY
- ANY SURFACE DISTURBANCE DUE TO TEST PIT/POTHOLE OF EXISTING UTILITIES SHALL BE REPAIRED IN ACCORDANCE
- WITH LOCAL STATE/COUNTY/TOWNSHIP AUTHORITIES.
 HORIZONTAL DATUM BASED ON NAD83, WEST VIRGINIA STATE PLANE SOUTH, US FOOT, VERTICAL DATUM BASED ON NAVD88.
- PROPERTY LINES SHOWN ON THESE SHEETS ARE APPROXIMATE AND NOT BASED ON A BOUNDARY SURVEY.
- THIS SURVEY WAS CONDUCTED BY TRC 2016

UTILITY NOTES:


1. THE UNDERGROUND UTILITIES SHOWN HEREON WERE COMPILED


ORDANISM DEPORTS ON ORTAINED FROM EXISTING PLANS, SURFACE FROM INFORMATION OBTAINED FROM EXISTING PLANS, SURFACE FACILITIES, AND FIELD WORK. UTILITIES ARE SHOWN AS ACCURATELY AS POSSIBLE FROM THE INFORMATION AVAILABLE. NO GUARANTEE OF ACTUAL LOCATION IS GIVEN

UNTIL SAID LINES ARE UNCOVERED IN FIELD FOR VERIFICATION.
PIPELINE SHALL BE REGISTERED WITH WEST VIRGINIA 8-1-1 UTILITIES PROTECTION SERVICE: 1-800-245-4548


- WEST VIRGINIA DOH NOTES:

 1. APPLICATIONS FOR PIPELINE ACCESSES SHALL BEAR THE SIGNATURE OF THE PROPERTY OWNER OR PROPERTY OWNER'S AUTHORIZED AGENT (IF APPLICABLE) AND THE SIGNATURE OF THE OIL AND GAS COMPANY REPRESENTATIVE.
- YOU MUST CONTACT THE WYDOH TRANSPORTATION MANAGER 48 HOURS PRIOR TO STARTING ANY WORK AND LIPON COMPLETION
- A COPY OF THE PERMIT AND APPROVED PLANS MUST BE ON SITE AT ALL TIMES WHILE WORK IS BEING PERFORMED WITHIN THE STATE RIGHT-OF-WAY.

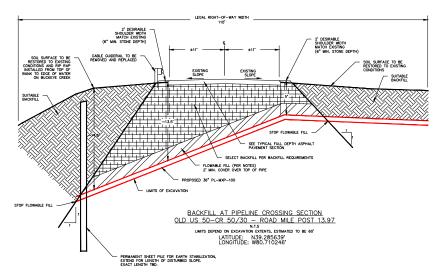

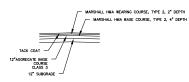


TYPICAL FULL DEPTH ASPHALT PAVEMENT SECTION

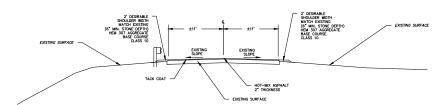

TYPICAL PAVEMENT OVERLAY SECTION N.I.S

LIMITS TO BE APPROXIMATELY 10' ON EACH SIDE OF THE FULL DEPTH EXCAVATION

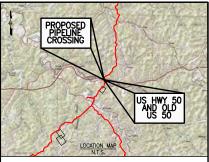

SELECT BACKFILL REQUIREMENTS

- THE FOLLOWING BACKFILLING SPECIFICATION IS TO BE USED IN CONNECTION
- WITH ANY UTILITY WORK PERFORMED WITHIN HIGHWAY RIGHT OF WAY.

 AFTER THE CASING CONDUIT OR OTHER UNDERGROUND FACILITY IS INSTALLED, AFTER THE CASING CONDUIT OR OTHER VIDERSONIUM FAULTI SINSTALLEY. THE TRENOH IS TO BE BACKFILLED. ALL BACKFILL MATERIAL SHALL: BE FREE FROM PARTICLES LARGER THAN 3 INCHES (75MM): NOT BE FROZEN; CONTAIN NO CINDERS, ASHES, REFUSE, ORGANIC, VEGETABLE OR OTHER LIKE MATTER; NOT ANY OTHER MATERIAL DEEMED UNSUITABLE BY THE DISTRICT ENGINEER OR HIS AUTHORIZED REPRESENTATIVE. CARE SHALL BE TAKEN TO COMPACT THE MATERIAL UNDER THE HAUNCHES OF THE CASING, CONDUIT PIPE OR OTHER FACILITY AND TO PLACE THE BACKFILL EVENLY ON EACH SIDE. THE BACKFILL MATERIAL SHALL BE DEPOSITED IN THE TRENCH FOR ITS FULL WIDTH IN LAYERS NOT EXCEEDING 4 INCHES (100MM) AFTER COMPACTION. THIS METHOD SHALL BE FOLLOWED UNTIL THE TRENCH IS FULLY BACKFILLED. THE TARGET PERCENTAGE OF DRY DENSITY FOR THE BACKFILL MATERIAL WILL BE 95% OR THE DENSITY OF THE EXISTING MATERIAL, AS EVIDENCED BY TESTING, IF THE EXISTING DENSITY IS LOWER THAN 95% IN AREAS OUTSIDE THE LIMITS OF THE TRAVELED WAY AND SHOULDERS, COMPACTION TO THE DENSITY OF THE ORIGINAL GROUND IS SUFFICIENT.
- ALL BACKFILL MATERIAL AND COMPACTION REQUIREMENTS SHALL BE IN ACCORDANCE WITH THE SPECIFICATIONS IN THIS MANUAL AND SUBJECT TO DIVISION OF HIGHWAYS APPROVAL. EVIDENCE OF PROPER COMPACTION BY
 TESTING WILL BE THE RESPONSIBILITY OF THE APPLICANT. THE TESTING SHALL BE 1 (ONE) PER DAY OF EVERY 500 LINEAL FEET (150M) OR AS DETERMINED BY THE DISTRICT ENGINEER OF THIS AUTHORIZED REPRESENTATIVE.
- APPROPRIATE AGGREGATE BASE COURSE AND/OR AGGREGATE SHOULDER STONE
 IS TO BE PLACED ON THE SHOULDER AT A THICKNESS EQUAL TO 6 INCHES (150MM) OR ITS ORIGINAL THICKNESS WHICHEVER IS GREATER. PAVED SHOULDER SHALL BE REPAVED

FLOWABLE FILL

- PIPELINE WILL BE BACKFILLED WITH FLOWABLE FILL TO A MINIMUM OF 2' OF COVER WITHIN THE ANGLE OF INFLUENCE.

 2. FLOWABLE FILL TO BE PER MIXTURE SPECIFIED ON TYPICAL.

GENERAL NOTES FOR TYPICAL SECTIONS

- SOIL SURFACE WILL BE SCARIFIED AND SEEDED IN ACCORDANCE WITH WVDOH STANDARDS.
- 2. ROADWAY MARKINGS, SIGNAGE, AND LINE STRIPING SHALL BE RESTORED TO EXISTING CONDITIONS IN ACCORDANCE WITH WYDOH STANDARDS
- 3. NEW ROADWAY SURFACE SHALL BE TIED INTO EXISTING ROADWAY
- SURFACE IN ACCORDANCE WITH WYDOH STANDARD DETAILS.

 4. ALL MATERIALS AND CONSTRUCTION SHALL BE IN ACCORDANCE

WITH MYDOH STANDARD SPECIFICATIONS, ROADS, AND BRIDGES
2010 AND MOST CURRENT SUPPLEMENTAL SPECIFICATIONS.

OLD US 50 UNCASED CROSSING Size - 36" NOM. O.D. Material - Steel Wall Thickness - 0.750° Material Grade - X70 MAOP - 1440 psig Design Factor - 0.5

WEST VIRGINIA DOH APP, NO.

TRENCH PLUG

Knew what's below. Call before we-

Pipe Coating - 14-16 MILS FBE and 30-60 MILS ARO

24/7 CONTACT AND PIPELINE MARKER INFO P.O. Box 1273


Charleston, WV 25325-1273 Emergency Phone: 1-800-835-7191 LEGEND SIT FING

02/17/2017

		_											_				(818) 496-0400 FIRM COA NO. C02358	IIII IIII WATS	=0000000 WATERBAR	
LEG	END (1,00) MLEPOST	-//- EXISTING COLUMBIA PIPELINE	7.Z7.2 TEM	PORARY WOR	RKSPACE		CONTRACTOR / PIPE YARD	ST-CO-001,000 PROPERTY TRACT NUMBER		GROUND CA		WETLAND	SCALE: NONE			D6987-ALC-056	ALIGNMENT SHEET		PROJECT DELIVERY PROJECT ENGINEERING	Columbia
	•	PERMANENT ROW	XXXX ADD	ITTONAL TEM	PORARY WO	RKSPACE		WPADJCCC2 WETLAND ID	——P—— OVERH ——W—— WATER		NE 📴	SECRECAS WATERSODY		_		A6967-TYP-54	TYPICAL ROAD REPAIR DETAIL (TYPE C)/FLOWABLE I	FILL MIX SPECIFICATION		Gas Transmission
		——X——FENCE	ACC	ESS ROAD			ARMICOT ACCESS ROAD NUMBER	SPADACOCC WATERBODY ID	COUNT		_	—SS—— SANITARY SEMER		3		A6987-TYP-25	TEMPORARY ROAD ENTRANCE ROCK PADS		MOUNTAINEER XP	RESS PROJECT
Δ	ISSUED FOR PERMIT				02/07/17	Λ					Λ		-						TITLE PL-MXP-100 - I	
<u>∠P1\</u>	ISSUED FOR FERMIT			JIJ	02/07/17	\triangle					\triangle								SUBROUTE 50/30 OLD US 50 M	P 48.5 - DODDRIDGE CO, WV
ρĐ	ISSUED FOR FERC SUPPL FILING			SJO	02/17//17	Δ					\Box								DRAWNER: SJS DATE: 1/03/17 DRA	AWING NUMBER SHEET ISSUE
No		REVISIONS		APPROVED	DATE	No	-	REVISIONS	APPROV	ED DAT	E No.		REVISIONS	APPROVED	DATE	DWG. NO.	REFERENCE		20432 D69	87-HXP-001 2 OF 4 P2
140.		TEVIOIONO		BY	07116	HO.	'	TE VIOIONO	BY		110.		TETIOIOTO	BY	001110		TELLETOE		NAMES 46130	




DODDRIDGE COUNTY, WEST VIRGINIA

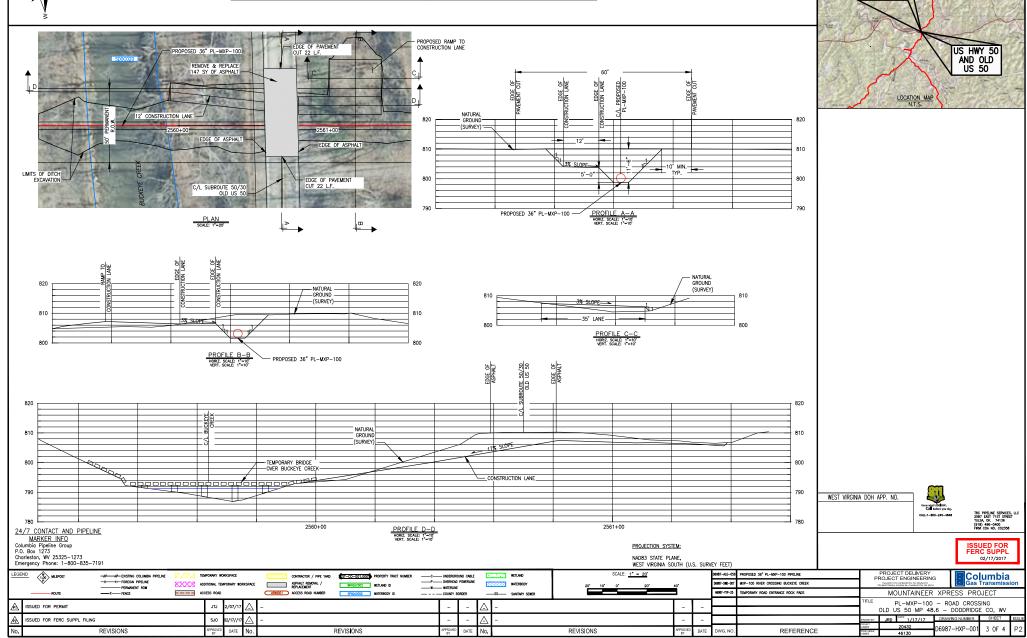


PROPOSED PIPELINE

CROSSING

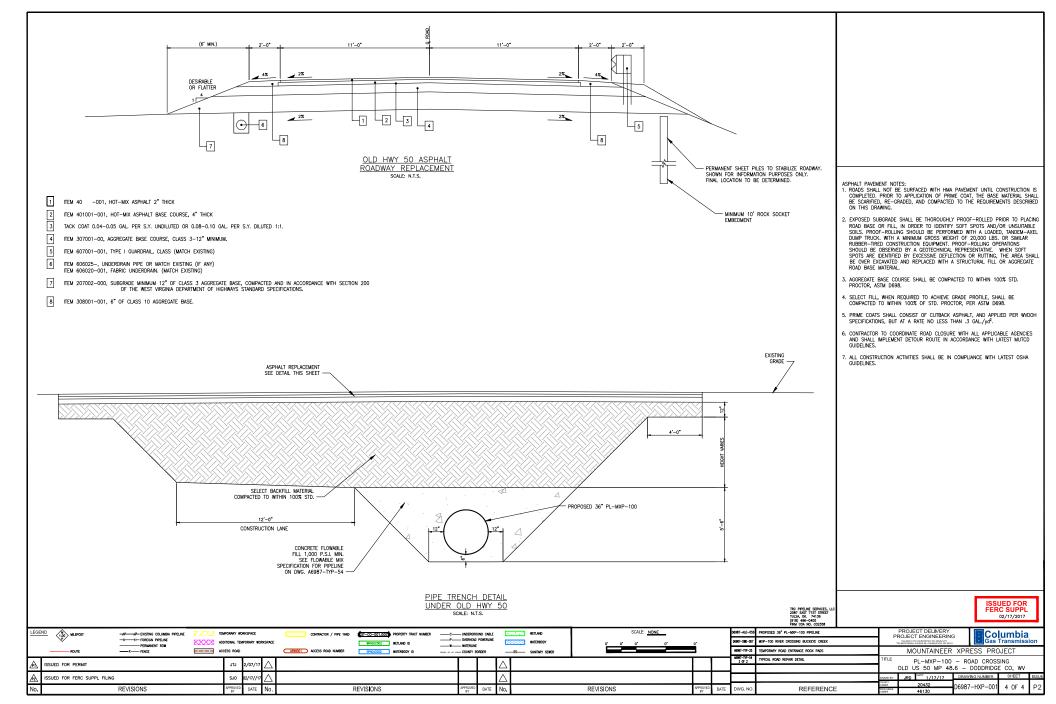



PUTNAM COUNTY, WEST VIRGINIA

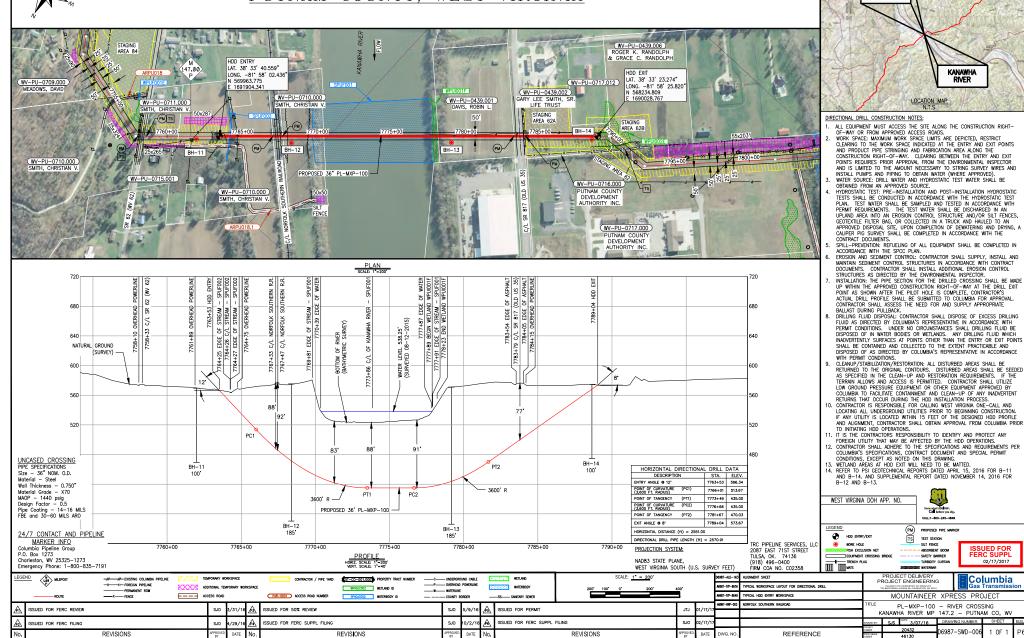

PROPOSED PIPELINE

CROSSING




-//---//- EXISTING COLUMBIA PIPELINE

REVISIONS

DODDRIDGE COUNTY. WEST VIRGINIA



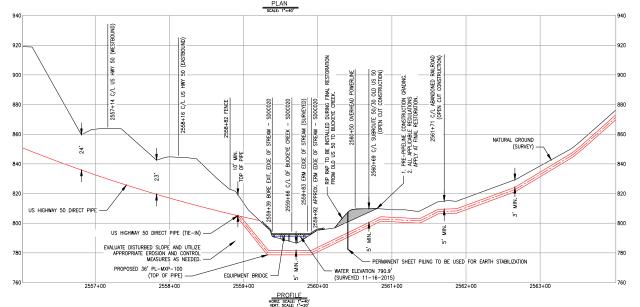

CONTRACTOR / PIPE YARD

#ST-CO-001,000 PROPERTY TRACT NUMBER

REVISIONS



CONSTRUCTION NOTES:

- THE BUCKEYE CREEK CONSTRUCTION CONSISTS OF THE INSTALLATION OF A
 - NEW 36" LINE IN A NEW TRENCH.
 TRENCH SHALL BE BACKFILLED TO CONFORM TO RIVER BOTTOM
- ELEVATIONS EXISTING PRIOR TO CONSTRUCTION.

 BUOYANCY CONTROL TO BE USED 10 FEET OUTSIDE OF ENVIRONMENTAL FEATURE BOUNDARIES.

ENVIRONMENTAL CONTROLS AND DETAILS:

- EROSION/SEDIMENT CONTROL STRUCTURES (SILT FENCES) TO BE INSTALLED PRIOR TO EARTH DISTURBANCE AND MAINTAINED DAILY TO MINIMIZE IMPACTS.
- DISTURBED AREAS TO BE STABILIZED/RESTORED PRIOR TO REMOVAL OF
- EROSION/SEDIMENT CONTROL STRUCTURES.
 TRENCH DEWATERING TO BE DIRECTED TO FILTER BAGS LOCATED IN AN UPLAND
- AREA IN A MANNER SO AS NOT TO CAUSE SEDIMENT TRANSPORT TO RIVER. EROSION CONTROL DEVICES WILL BE INSTALLED AROUND FILTER BAG.
- NO HEAVY EQUIPMENT REFUELING TO TAKE PLACE WITHIN RIVER, FLOODPLAIN, WETLAND. OR 100-FOOT WATERBODY SETBACK AREA.
- THE USE OF PUMPS WITHIN 100' OF A WATERBODY OR WETLAND WILL COMPLY WITH COLUMBIA'S FCS.
- DEPLOY ABSORBENT BOOMS "AT THE READY", ONSHORE DOWNSTREAM OF THE
- WORK AREA. EROSION CONTROL MEASURES AS DEPICTED IN THESE PLANS ARE INTENDED AS GUIDELINES AND MAY BE ADJUSTED BY COLUMBIA'S ENVIRONMENTAL INSPECTORS
- TO MEET ACTUAL FIELD CONDITIONS. EQUIPMENT WILL OPERATE ON A (MATTING, RAILCAR BRIDGE OR ROCK AND
- FLUME) DUE TO ACTUAL SITE CONDITIONS. BACKUP PUMPS (AS SAME NUMBER AND CAPACITY AS ACTIVE PUMPS) WILL
- BE READILY AVAILABLE IN WORKING CONDITION ON SITE AT CROSSING.
- INSTALL SEDIMENT CONTROL DEVICES ALONG ACCESS ROAD, AS NEEDED.
 PROPOSED DAM UTILIZED WILL BE SANDBAGS, AQUA DAM AND/OR COFFER DAM
- OR EQUIVALENT AND SHALL BE OF ADEQUATE HEIGHT TO IMPOUND WATER.
 INSTALL REMOVABLE EROSION CONTROL DEVICE ACROSS TRAVEL LANE. REPLACE
- AT THE END OF EACH DAY.

 ALL PUMPS MUST BE PLACED IN APPROPRIATE SECONDARY CONTAINMENT.
- CONSTRUCT AND MAINTAIN EQUIPMENT BRIDGES TO ALLOW UNRESTRICTED FLOW AND TO PREVENT SOIL FROM ENTERING THE WATERBODY. BRIDGE SHOULD BE
- DESIGNED AND MAINTAINED TO WITHSTAND AND PASS THE HIGHEST FLOW EXPECTED TO OCCUR WHILE THE BRIDGE IS IN PLACE. PIPELINE SACK WEIGHTS WILL BE 17 FEET FROM CENTER TO CENTER OF BAGS, OR USE 6.25" THICK CONCRETE COATED PIPE.

PROJECTION SYSTEM:

NAD83 STATE PLANE,

WEST VIRGINIA SOUTH (U.S. SURVEY FEET)

Size - 36" NOM. O.D.

LIGNMENT SHEET

REFERENCE

Material - Steel Wall Thickness - 0.750'

Emergency Phone: 1-800-835-7191

24/7 CONTACT AND PIPELINE MARKER INFO

LEGEND **₽₩** TS HOD ENTRY/EXT BORE HOLE EQUIPMENT CROSSING BRIDGE M Mars

PROPOSED PIPE MARKER TEST STATION SILT FENCE SAFETY BARRIER


02/17/2017 PROJECT DELIVERY Columbia

LEGEND LOO MLEPOST PROJECT ENGINEERING -I-FOREIGN PIPELINE YPICAL STREAM CROSSING DAM AND PUMP ADDITIONAL TEMPORARY WORKSPACE WATERBODY WETLAND ID ACCESS ROAD ARMOOT ACCESS ROAD NUMBER WATERBODY ID MOVP-100 ROAD CROSSING/US HIGHWAY 50 MOUNTAINEER XPRESS PROJECT ____X___EENCE _____ COUNTY BODGE _____ CC_____ CAUITADV CEWE PL-MXP-100 - RIVER CROSSING ISSUED FOR FERC SUPPL FILING BUCKEYE CREEK MP 48.5 - DODDRIDGE CO, WV ISSUED FOR FERC SUPPL FILING D6987-SWD-007

REVISIONS



CABELL COUNTY, WEST VIRGINIA

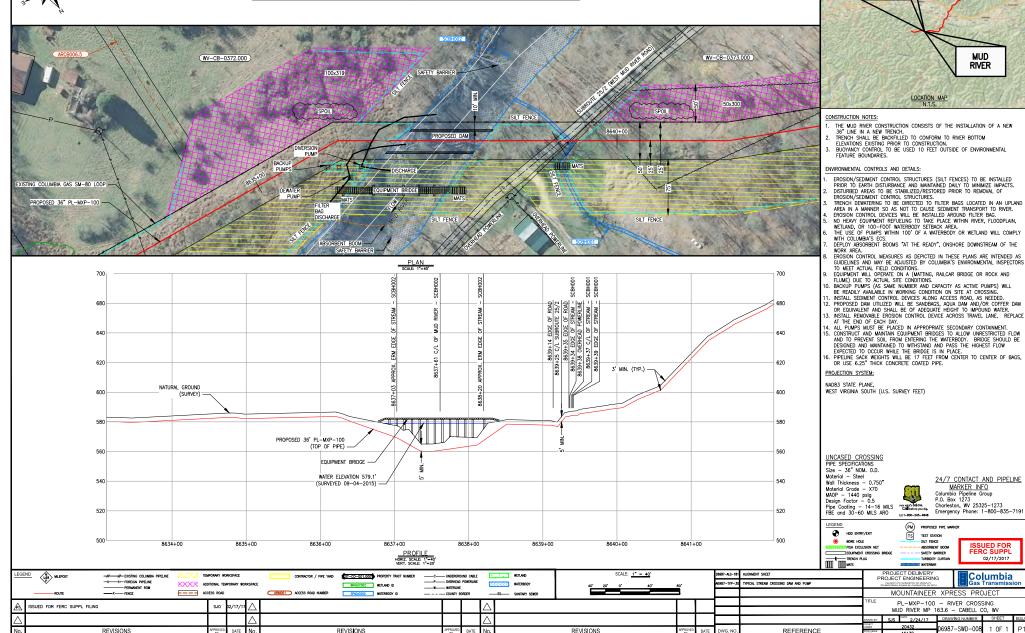

PROPOSED PIPELINE

CROSSING

Mountaineer XPress Project
Site-specific Residential Drawings

Mountaineer XPress Project

MXP-100 Site-specific Residential Drawings



MOUNTAINEER XPRESS - MXP

PROPOSED 36" PL-MXP-100 PIPELINE ENGINEERING SERVICES DESIGN; JOB NUMBER 6987 SITE SPECIFIC RESIDENTIAL PLANS - COVER SHEET

DRAWING NO.	DRAWING TITLE	TRACT NO.	REV.
D6987-RSD-04	PL-MXP-100 MP 22.7 RESIDENTIAL DETAIL - WETZEL COUNTY, WV	WV-WZ-0421.000	P2
D6987-RSD-05	PL-MXP-100 MP 23.2 RESIDENTIAL DETAIL - WETZEL COUNTY, WV	WV-WZ-0422.000	P2
D6987-RSD-06	PL-MXP-100 MP 24.8 RESIDENTIAL DETAIL WETZEL COUNTY, WV	WV-WZ-0429.000	P2
D6987-RSD-07	PL-MXP-100 MP 25.13 RESIDENTIAL DETAIL - WETZEL COUNTY, WV	WV-WZ-0430.000	P3
D6987-RSD-09	PL-MXP-100 MP-46.1 RESIDENTIAL DETAIL DODDRIDGE COUNTY, WV	WV-DO-0184.000	P1
D6987-RSD-10	PL-MXP-100 MP 50.81 RESIDENTIAL DETAIL - DODDRIDGE COUNTY, WV	WV-DO-0278.007	P3
D6987-RSD-11	PL-MXP 100 MP 56.5 RESIDENTIAL DETAIL DODDRIDGE COUNTY, WV	WV-DO-0358.001	P1
D6987-RSD-13	PL-MXP-100 MP 68.13 RESIDENTIAL DETAIL - RITCHIE COUNTY, WV	WV-RI-0078.000	Р3
D6987-RSD-14	PL-MXP-100 MP 69.75 RESIDENTIAL DETAIL - RITCHIE COUNTY, WV	WV-RI-0203.000	P2
D6987-RSD-15	PL-MXP-100 MP 72.25 RESIDENTIAL DETAIL - RITCHIE COUNTY, WV	WV-RI-0248.000	P3
D6987-RSD-18	PL-MXP-100 MP 79.1 RESIDENTIAL DETAIL - RITCHIE COUNTY, WV	WV-RI-0434.000	P2
D6987-RSD-19	PL-MXP-100 MP 88.13 RESIDENTIAL DETAIL - WIRT COUNTY, WV	WV-WI-0094.000	P2
D6987-RSD-22	PL-MXP-100 MP 123.94 RESIDENTIAL DETAIL - JACKSON COUNTY, WV	WV-JA-0364.000	Р3
D6987-RSD-24	PL-MXP-100 MP 124.53 RESIDENTIAL DETAIL - JACKSON COUNTY, WV	WV-JA-0424.000	P2
D6987-RSD-25	PL-MXP-100 MP 124.75 RESIDENTIAL DETAIL - JACKSON COUNTY, WV	WV-JA-0368.000	P3
D6987-RSD-26	PL-MXP-100 MP 129.8 RESIDENTIAL DETAIL - JACKSON COUNTY, WV	WV-JA-0623.000	P2
D6987-RSD-28	PL-MXP-100 MP 134.9 RESIDENTIAL DETAIL - PUTNAM COUNTY, WV	WV-PU-0062.001	P2
D6987-RSD-29	PL-MXP-100 MP 138.5 RESIDENTIAL DETAIL - PUTNAM COUNTY, WV	WV-PU-0175.000	P2
D6987-RSD-32	PL-MXP-100 MP 143.3 RESIDENTIAL DETAIL - PUTNAM COUNTY, WV	WV-PU-0239.000	P2
D6987-RSD-40	PL-MXP-100 MP 158.20 RESIDENTIAL DETAIL - CABELL COUNTY, WV	WV-CB-0065.000	P3
D6987-RSD-41	PL-MXP-100 MP 160.6 RESIDENTIAL DETAIL - CABELL COUNTY, WV	WV-CB-0194.000	P2
D6987-RSD-42	PL-MXP-100 MP 160.6 RESIDENTIAL DETAIL - CABELL COUNTY, WV	WV-CB-0109.000	P2
D6987-RSD-47	PL-MXP-100 MP 162.41 RESIDENTIAL DETAIL - CABELL COUNTY, WV	WV-CB-0208.000	P3

HIGHLIGHTED RESIDENTIAL DETAILS BELOW ARE NEW THIS ISSUE

DRAWING NO.	DRAWING TITLE	TRACT NO.	REV.
D6987-RSD-49	PL-MXP-100 MP 7.1 RESIDENTIAL DETAIL - MARSHALL COUNTY, WV	WV-MA-0181.001	P1
D6987-RSD-50	PL-MXP-100 MP 21.2 RESIDENTIAL DETAIL - WETZEL COUNTY, WV	WV-WZ-0270.000	P1
D6987-RSD-51	PL-MXP-100 MP 24.4 RESIDENTIAL DETAIL - WETZEL COUNTY, WV	WV-WZ-0329.000	P1
D6987-RSD-52	PL-MXP-100 MP 35.1 RESIDENTIAL DETAIL - TYLER COUNTY, WV	WV-TY-0049.000	P1
D6987-RSD-53	PL-MXP-100 MP 42.8 RESIDENTIAL DETAIL - DODDRIDGE COUNTY, WV	WV-DO-0009.000	P1
D6987-RSD-54	PL-MXP-100 MP 43.9 RESIDENTIAL DETAIL - DODDRIDGE COUNTY, WV	WV-DO-0158.000	P1
D6987-RSD-55	PL-MXP-100 MP 43.8 RESIDENTIAL DETAIL - DODDRIDGE COUNTY, WV	WV-DO-0157.000	P1
D6987-RSD-56	PL-MXP-100 MP 45.02 RESIDENTIAL DETAIL - DODDRIDGE COUNTY, WV	WV-DO-0196.000	P1
D6987-RSD-57	PL-MXP-100 MP 77.7 RESIDENTIAL DETAIL - RITCHIE COUNTY, WV	WV-RI-0349.000	P1
D6987-RSD-58	PL-MXP-100 MP 77.7 RESIDENTIAL DETAIL - RITCHIE COUNTY, WV	WV-RI-0415.000	P1
D6987-RSD-59	PL-MXP-100 MP 91.72 RESIDENTIAL DETAIL - WIRT COUNTY, WV	WV-WI-0142.000	P1
D6987-RSD-60	PL-MXP-100 MP 106.08 RESIDENTIAL DETAIL - ROANE COUNTY, WV	WV-RO-0195.000	P1
D6987-RSD-61	PL-MXP-100 MP 107.4 RESIDENTIAL DETAIL - ROANE COUNTY, WV	WV-RO-0200.000	P1
D6987-RSD-62	PL-MXP-100 MP 112.12 RESIDENTIAL DETAIL - JACKSON COUNTY, WV	WV-JA-0059.000	P1
D6987-RSD-63	PL-MXP-100 MP 145.3 RESIDENTIAL DETAIL - PUTNAM COUNTY, WV	WV-PU-0405.000	P1
D6987-RSD-64	PL-MXP-100 MP 156.8 RESIDENTIAL DETAIL - CABELL COUNTY, WV	WV-CB-0006.001	P1
D6987-RSD-65	PL-MXP-100 MP 161.9 RESIDENTIAL DETAIL - CABELL COUNTY, WV	WV-CB-0371.000	P1
		•	•

		ISSUED FOR FERC SUPPL 02/17/2017 0	DESIGN PRESSURE	PROJECT DELIVERY PROJECT ENGINEERING 1.P.O. 80X 1273 CHARLESTON, W. 25325-1273. 1.P.O. 80X 1273 CHARLESTON, W. 25325-1273. Gas Transmission
H		SSUED FOR FERC SUPPL FILING HE 10/02/16	TEST LIMITED BY	MOUNTAINEER XPRESS — MXP TITLE PROPOSED PL—MXP—100 PIPELINE SITE SPECIFIC RESIDENTIAL PLANS — COVER SHEET
	#E 02/17/17 FERC SUPPL FILING	JHE 04/29/16 GPU 04/29/16 GPU 04/29/16 TIJ 04/29/16 TIJ 04/29/16 GPU	TO THE BEST OF MY KNOWLEDGE, ALL COMPONENTS OF THIS DRAWING ARE DESIGNED N ACCORDANCE WITH APPLICABLE COLUMBIA GUIDELINES AND SPECIFICATIONS	GRAWN BY: GPM DATE: DRAWING NUMBER ISSUE
N	O. REVISIONS BY DATE NO. REVISIONS	NO. REVISIONS	DESIGN ENGINEER DATE DWG, NO. REFERENCE	PROJECT NUMBER: 20432 D6987—RSD—COV P3



TRACT WV-WZ-0421.000

WETZEL COUNTY, WEST VIRGINIA



C UNDERGROUND CABLE
P OVERHEAD POWER LINE

ISSUED FOR FERC SUPPL FILING

REVISIONS

-//- EXISTING COLUMBIA PIPELINE

——X——FENCE

- ACCESS ROAD

WPADJC002 WETLAND ID

SAFETY FENCE SPADJC002 WATERBODY II

ADDITIONAL TEMPORARY WORKSPACE

REVISIONS

CONTRACTOR / PIPE YARD

ARWIOD1 ACCESS ROAD NUMBER

SANITARY SEWER PROPERTY LINE

REVISIONS

DESCRIPTION

THIS DRAWING DOCUMENTS MITIGATION MEASURES THAT WILL BE IMPLEMENTED FOR ALL RESIDENCES WITHIN 50 FEET OF THE PROPOSED CONSTRUCTION WORK AREA. CONTRACTOR SHALL COMPLY WITH THE FOLLOWING CONSTRUCTION MITIGATION REQUIREMENTS IN ADDITION TO THOSE LISTED IN THE CONSTRUCTION SPECIFICATIONS.

CONSTRUCTION REQUIREMENTS

- 1. CONTRACTOR SHALL ERECT AND MAINTAIN A SAFETY FENCE BETWEEN THE CONSTRUCTION ZONE AND THE ADJACENT RESIDENCES EXTENDING 100 FEET ON EITHER SIDE OF THE RESIDENCE TO ENSURE THAT EQUIPMENT, MATERIALS AND SPOIL REMAIN WITHIN THE CONSTRUCTION WORK AREA.
- 2. A MINIMUM OF 25 FEET WILL BE MAINTAINED BETWEEN THE RESIDENCE AND CONSTRUCTION WORK AREA FOR A DISTANCE OF 100 FEET ON EITHER SIDE OF THE RESIDENCE. IF THE FACILITY MUST BE WITHIN 25 FEET OF A RESIDENCE, IT MUST BE INSTALLED SUCH THAT THE TRENCH DOES NOT REMAIN OPEN OVERNIGHT.
- 3. MATURE TREES AND LANDSCAPING WILL NOT BE REMOVED FROM WITHIN THE EDGE OF THE CONSTRUCTION WORK AREA UNLESS NECESSARY FOR SAFE OPERATION OF CONSTRUCTION EQUIPMENT OR AS SPECIFIED IN LANDOWNER AGREEMENTS.
- 4. OTHER EXISTING PHYSICAL FEATURES THAT NEED TO BE PROTECTED WILL BE ENCLOSED IN SAFETY FENCE TO AVOID DISTURBANCE DURING CONSTRUCTION.
- 5. TRENCH SHALL NOT BE EXCAVATED UNTIL PIPELINE IS READY FOR INSTALLATION AND SHALL BE BACKFILLED IN SAME DAY AS PIPE INSTALLATION IN THIS AREA. ALL OPEN DITCHES SHALL BE BARRICADED/FENCED OFF OR PLATED WHEN CONSTRUCTION ACTIVITIES ARE NOT IN PROGRESS.
- 6. IMMEDIATELY AFTER BACKFILLING THE TRENCH, ALL LAWN AND LANDSCAPING WILL BE RESTORED TO FINAL RESTORATION, OR TEMPORARY RESTORATION PENDING WEATHER AND SOIL CONDITIONS. IF SEASONAL OR WEATHER CONDITIONS PREVENT COMPLIANCE WITH THESE TIME FRAMES, TEMPORARY EROSION CONTROLS MUST BE MONITORED AND MAINTAINED UNTIL CONDITIONS ALLOW COMPLETION OF RESTORATION.
- 7. CONTRACTOR SHALL UTILIZE WATER TRUCKS AS NECESSARY TO MINIMIZE FUGITIVE DUST FROM CONSTRUCTION ACTIVITIES NEAR RESIDENCES/BUSINESSES.
- 8. ACCESS TO RESIDENCES BY CAR WILL BE MAINTAINED AT ALL TIMES, OR OTHER ACCOMMODATIONS WILL BE MADE WITH EACH RESPECTIVE LANDOWNER.
- 9. CONTRACTOR SHALL MAINTAIN AGREED UPON ACCESS TO THE IMPACTED AREA DURING CONSTRUCTION.
- 10. CONTRACTOR SHALL LIMIT WORK IN THIS AREA TO DAYLIGHT HOURS, UNLESS OTHERWISE AGREED UPON WITH LANDOWNER/OCCUPANT.
- 11. LANDOWNER/OCCUPANT SHALL BE NOTIFIED OF PROPOSED CONSTRUCTION ACTIVITIES PRIOR TO CONSTRUCTION WORK.

PROJECT DELIVERY PROJECT ENGINEERING

ROPOSED 36" PL-MXP-100 PIPELINE

REFERENCE

ISSUED FOR FERC SUPPL

MOUNTAINEER XPRESS PROJECT

WETZEL COUNTY, WV

TLE PL-MXP-100 MP 22.7 - RESIDENTIAL DETAIL



TRACT WV-WZ-0422.000

WETZEL COUNTY, WEST VIRGINIA



ISSUED FOR FERC SUPPL FILING ISSUED FOR FERC SUPPL FILING

REVISIONS

REVISIONS

DESCRIPTION

THIS DRAWING DOCUMENTS MITIGATION MEASURES THAT WILL BE IMPLEMENTED FOR ALL RESIDENCES WITHIN 50 FEET OF THE PROPOSED CONSTRUCTION WORK AREA. CONTRACTOR SHALL COMPLY WITH THE FOLLOWING CONSTRUCTION MITIGATION REQUIREMENTS IN ADDITION TO

- 1. CONTRACTOR SHALL ERECT AND MAINTAIN A SAFETY FENCE BETWEEN THE CONSTRUCTION ZONE AND THE ADJACENT RESIDENCES EXTENDING 100 FEET ON EITHER SIDE OF THE RESIDENCE TO ENSURE THAT EQUIPMENT, MATERIALS AND SPOIL REMAIN WITHIN THE
- 2. A MINIMUM OF 25 FEET WILL BE MAINTAINED BETWEEN THE RESIDENCE AND CONSTRUCTION WORK AREA FOR A DISTANCE OF 100 FEET ON EITHER SIDE OF THE RESIDENCE. IF THE FACILITY MUST BE WITHIN 25 FEET OF A RESIDENCE, IT MUST BE INSTALLED SUCH THAT THE TRENCH DOES NOT REMAIN OPEN OVERNIGHT.
- 3. MATURE TREES AND LANDSCAPING WILL NOT BE REMOVED FROM WITHIN THE EDGE OF THE CONSTRUCTION WORK AREA UNLESS NECESSARY FOR SAFE OPERATION OF CONSTRUCTION EQUIPMENT OR AS SPECIFIED IN LANDOWNER AGREEMENTS.
- 4. OTHER EXISTING PHYSICAL FEATURES THAT NEED TO BE PROTECTED WILL BE ENCLOSED IN SAFETY FENCE TO AVOID DISTURBANCE DURING CONSTRUCTION.
- 5. TRENCH SHALL NOT BE EXCAVATED UNTIL PIPELINE IS READY FOR INSTALLATION AND SHALL BE BACKFILLED IN SAME DAY AS PIPE INSTALLATION IN THIS AREA. ALL OPEN DITCHES SHALL BE BARRICADED/FENCED OFF OR PLATED WHEN CONSTRUCTION ACTIVITIES ARE
- 6. IMMEDIATELY AFTER BACKFILLING THE TRENCH, ALL LAWN AND LANDSCAPING WILL BE RESTORED TO FINAL RESTORATION, OR TEMPORARY RESTORATION PENDING WEATHER AND SOIL CONDITIONS. IF SEASONAL OR WEATHER CONDITIONS PREVENT COMPLIANCE WITH THESE TIME FRAMES, TEMPORARY EROSION CONTROLS MUST BE MONITORED AND MAINTAINED UNTIL
- 7. CONTRACTOR SHALL UTILIZE WATER TRUCKS AS NECESSARY TO MINIMIZE FUGITIVE DUST FROM
- 8. ACCESS TO RESIDENCES BY CAR WILL BE MAINTAINED AT ALL TIMES, OR OTHER ACCOMMODATIONS WILL BE MADE WITH EACH RESPECTIVE LANDOWNER.
- 9. CONTRACTOR SHALL MAINTAIN AGREED UPON ACCESS TO THE IMPACTED AREA DURING CONSTRUCTION.
- DAYLIGHT HOURS, UNLESS OTHERWISE AGREED UPON
- PROPOSED CONSTRUCTION ACTIVITIES PRIOR TO


REFERENCE

^{ITLE} PL-MXP-100 MP 23.2 - RESIDENTIAL DETAIL WETZEL COUNTY, WV

Co<u>l</u>umbia



TRACT WV-WZ-0430.000

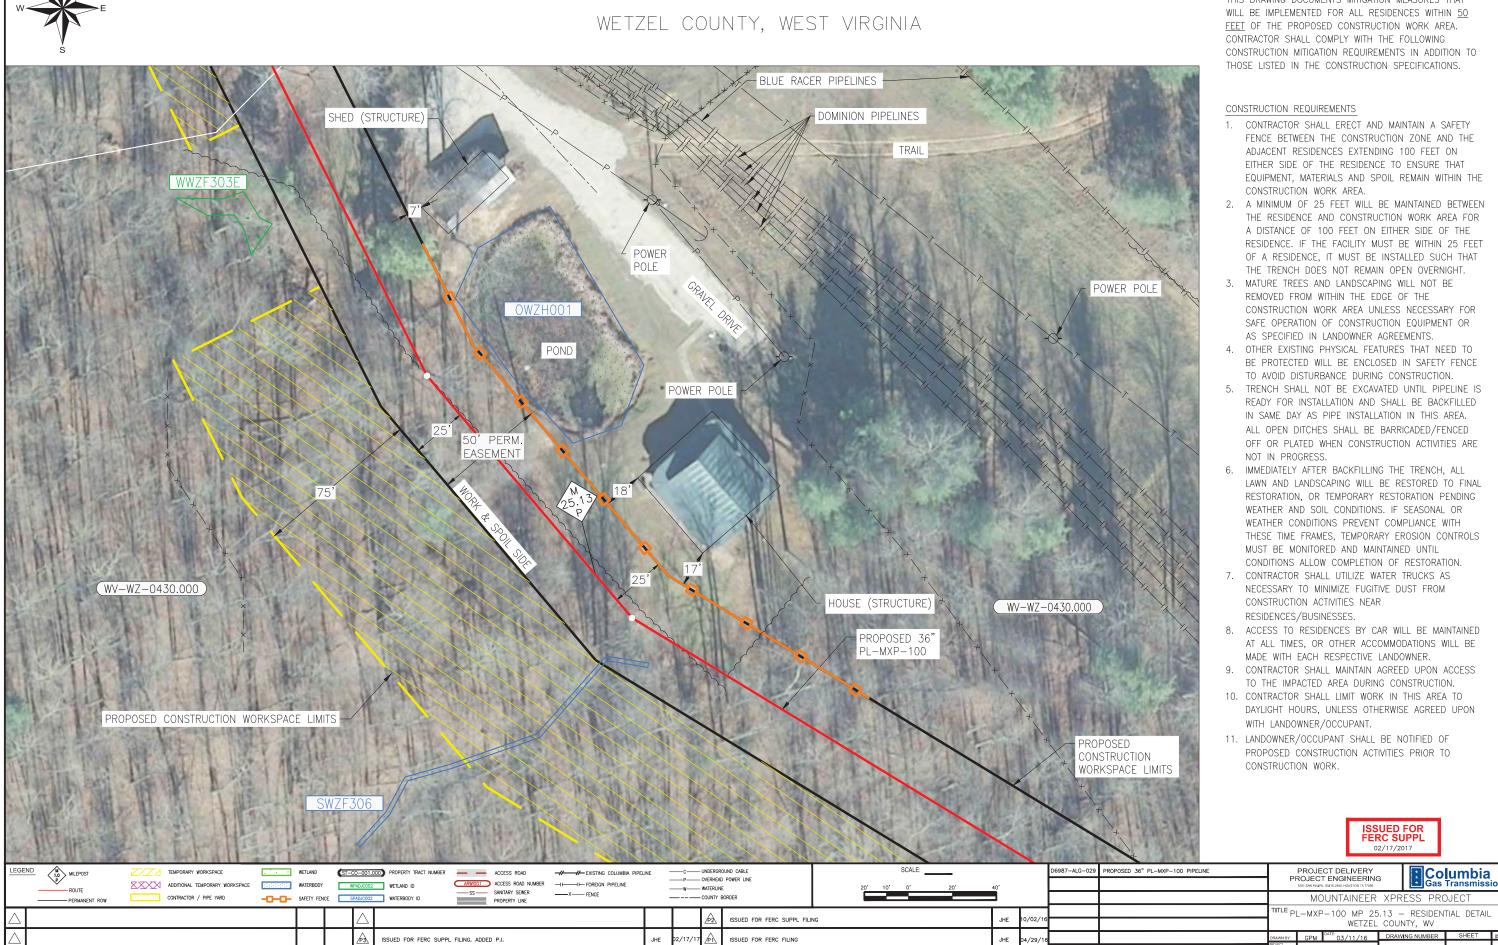

REVISIONS

REVISIONS

DESCRIPTION


REFERENCE

THIS DRAWING DOCUMENTS MITIGATION MEASURES THAT



TRACT WV-D0-0278.007

DODDRIDGE COUNTY, WEST VIRGINIA

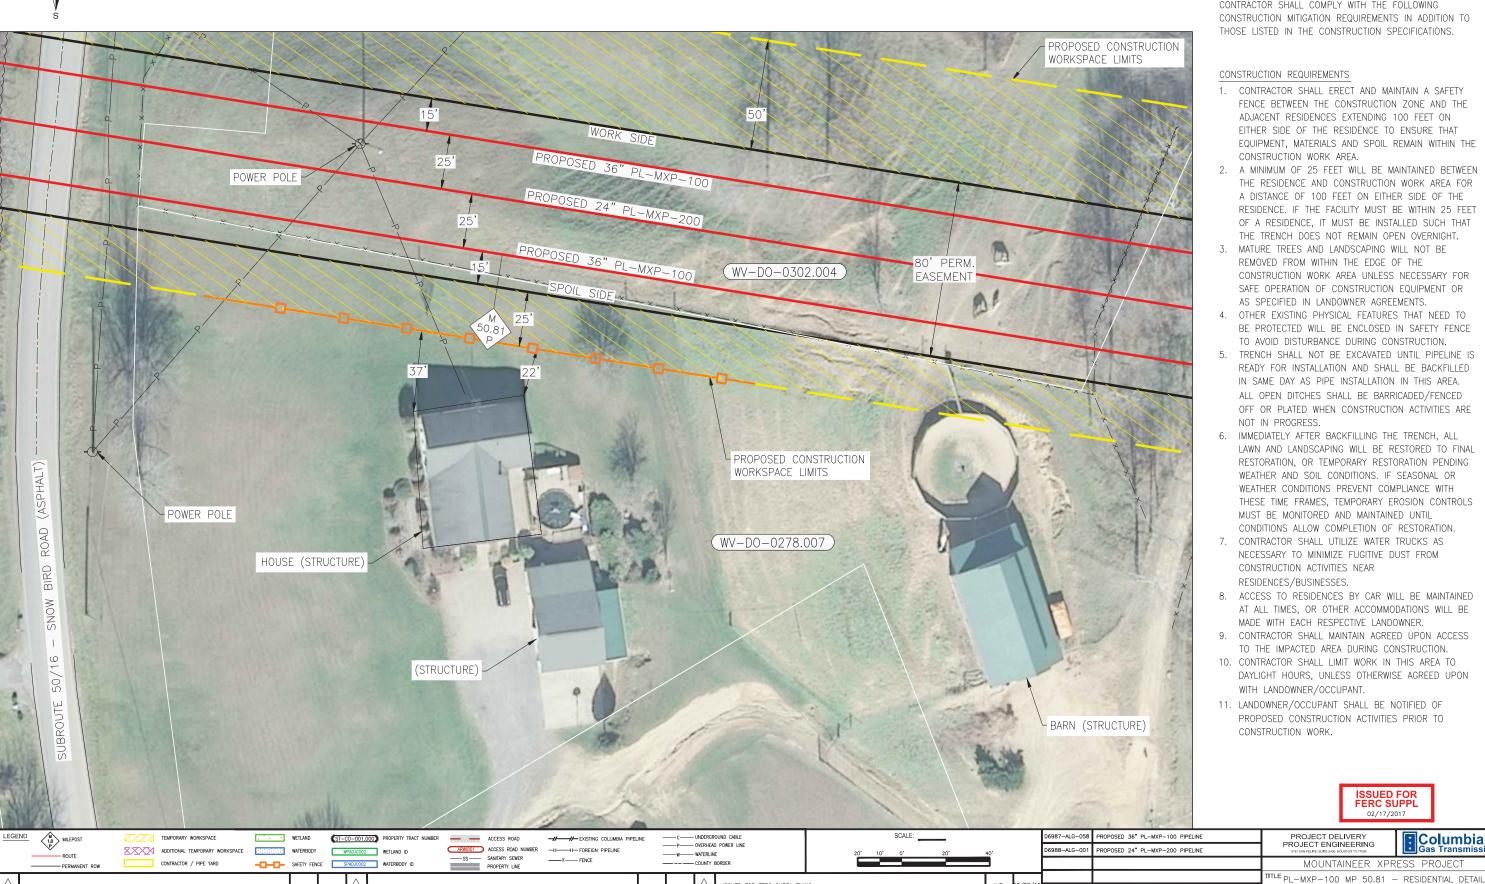

ISSUED FOR FERC SUPPL FILING

REVISIONS

ISSUED FOR FERC FILING

ISSUED FOR FERC SUPPL FILING

REVISIONS

REVISIONS

DESCRIPTION

THIS DRAWING DOCUMENTS MITIGATION MEASURES THAT WILL BE IMPLEMENTED FOR ALL RESIDENCES WITHIN 50 FEET OF THE PROPOSED CONSTRUCTION WORK AREA. CONTRACTOR SHALL COMPLY WITH THE FOLLOWING CONSTRUCTION MITIGATION REQUIREMENTS IN ADDITION TO THOSE LISTED IN THE CONSTRUCTION SPECIFICATIONS.

- 1. CONTRACTOR SHALL ERECT AND MAINTAIN A SAFETY FENCE BETWEEN THE CONSTRUCTION ZONE AND THE ADJACENT RESIDENCES EXTENDING 100 FEET ON EITHER SIDE OF THE RESIDENCE TO ENSURE THAT EQUIPMENT, MATERIALS AND SPOIL REMAIN WITHIN THE
- 2. A MINIMUM OF 25 FEET WILL BE MAINTAINED BETWEEN THE RESIDENCE AND CONSTRUCTION WORK AREA FOR A DISTANCE OF 100 FEET ON EITHER SIDE OF THE RESIDENCE. IF THE FACILITY MUST BE WITHIN 25 FEET OF A RESIDENCE, IT MUST BE INSTALLED SUCH THAT THE TRENCH DOES NOT REMAIN OPEN OVERNIGHT.
- MATURE TREES AND LANDSCAPING WILL NOT BE REMOVED FROM WITHIN THE EDGE OF THE CONSTRUCTION WORK AREA UNLESS NECESSARY FOR SAFE OPERATION OF CONSTRUCTION EQUIPMENT OR AS SPECIFIED IN LANDOWNER AGREEMENTS.
- 4. OTHER EXISTING PHYSICAL FEATURES THAT NEED TO BE PROTECTED WILL BE ENCLOSED IN SAFETY FENCE TO AVOID DISTURBANCE DURING CONSTRUCTION.
- TRENCH SHALL NOT BE EXCAVATED UNTIL PIPELINE IS READY FOR INSTALLATION AND SHALL BE BACKFILLED IN SAME DAY AS PIPE INSTALLATION IN THIS AREA. ALL OPEN DITCHES SHALL BE BARRICADED/FENCED OFF OR PLATED WHEN CONSTRUCTION ACTIVITIES ARE
- 6. IMMEDIATELY AFTER BACKFILLING THE TRENCH, ALL LAWN AND LANDSCAPING WILL BE RESTORED TO FINAL RESTORATION, OR TEMPORARY RESTORATION PENDING WEATHER AND SOIL CONDITIONS. IF SEASONAL OR WEATHER CONDITIONS PREVENT COMPLIANCE WITH THESE TIME FRAMES, TEMPORARY EROSION CONTROLS MUST BE MONITORED AND MAINTAINED UNTIL CONDITIONS ALLOW COMPLETION OF RESTORATION.
- 7. CONTRACTOR SHALL UTILIZE WATER TRUCKS AS NECESSARY TO MINIMIZE FUGITIVE DUST FROM CONSTRUCTION ACTIVITIES NEAR
- 8. ACCESS TO RESIDENCES BY CAR WILL BE MAINTAINED AT ALL TIMES, OR OTHER ACCOMMODATIONS WILL BE MADE WITH EACH RESPECTIVE LANDOWNER.
- 9. CONTRACTOR SHALL MAINTAIN AGREED UPON ACCESS TO THE IMPACTED AREA DURING CONSTRUCTION.
- 10. CONTRACTOR SHALL LIMIT WORK IN THIS AREA TO DAYLIGHT HOURS, UNLESS OTHERWISE AGREED UPON WITH LANDOWNER/OCCUPANT.
- 11. LANDOWNER/OCCUPANT SHALL BE NOTIFIED OF PROPOSED CONSTRUCTION ACTIVITIES PRIOR TO

REFERENCE

ISSUED FOR FERC SUPPL


DODDRIDGE COUNTY, WV

Columbia Gas Transmissi



TRACT WV-RI-0078.000

RITCHIE COUNTY, WEST VIRGINIA

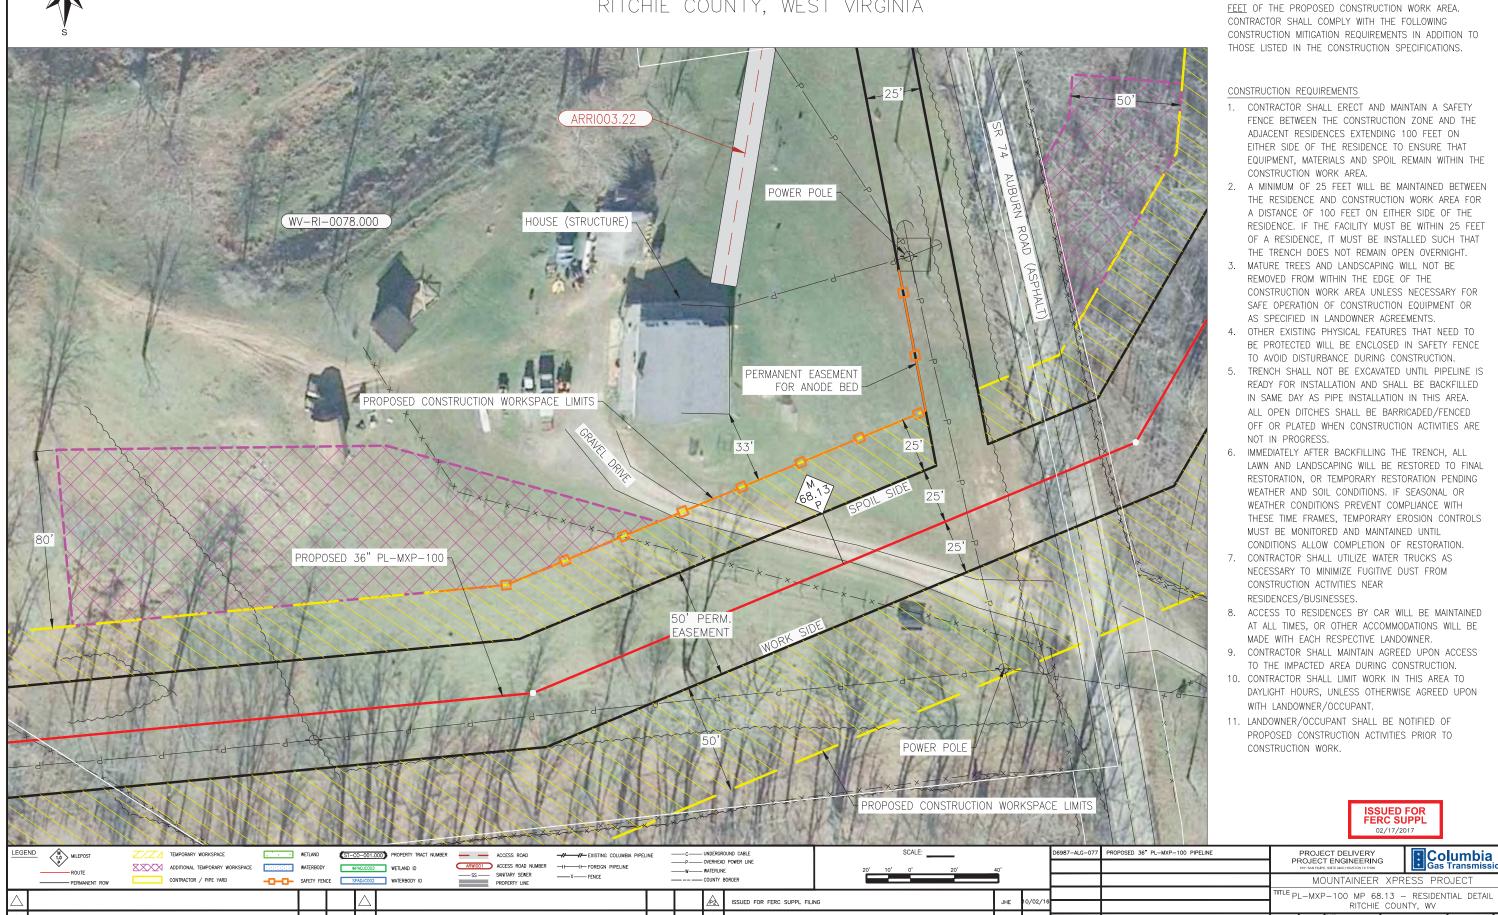

ISSUED FOR FERC FILING

REVISIONS


ISSUED FOR FERC SUPPL FILING

REVISIONS

REVISIONS


THIS DRAWING DOCUMENTS MITIGATION MEASURES THAT WILL BE IMPLEMENTED FOR ALL RESIDENCES WITHIN 50

D6987-RSD-1

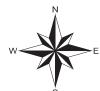

TRACT WV-RI-0203.000

RITCHIE COUNTY, WEST VIRGINIA

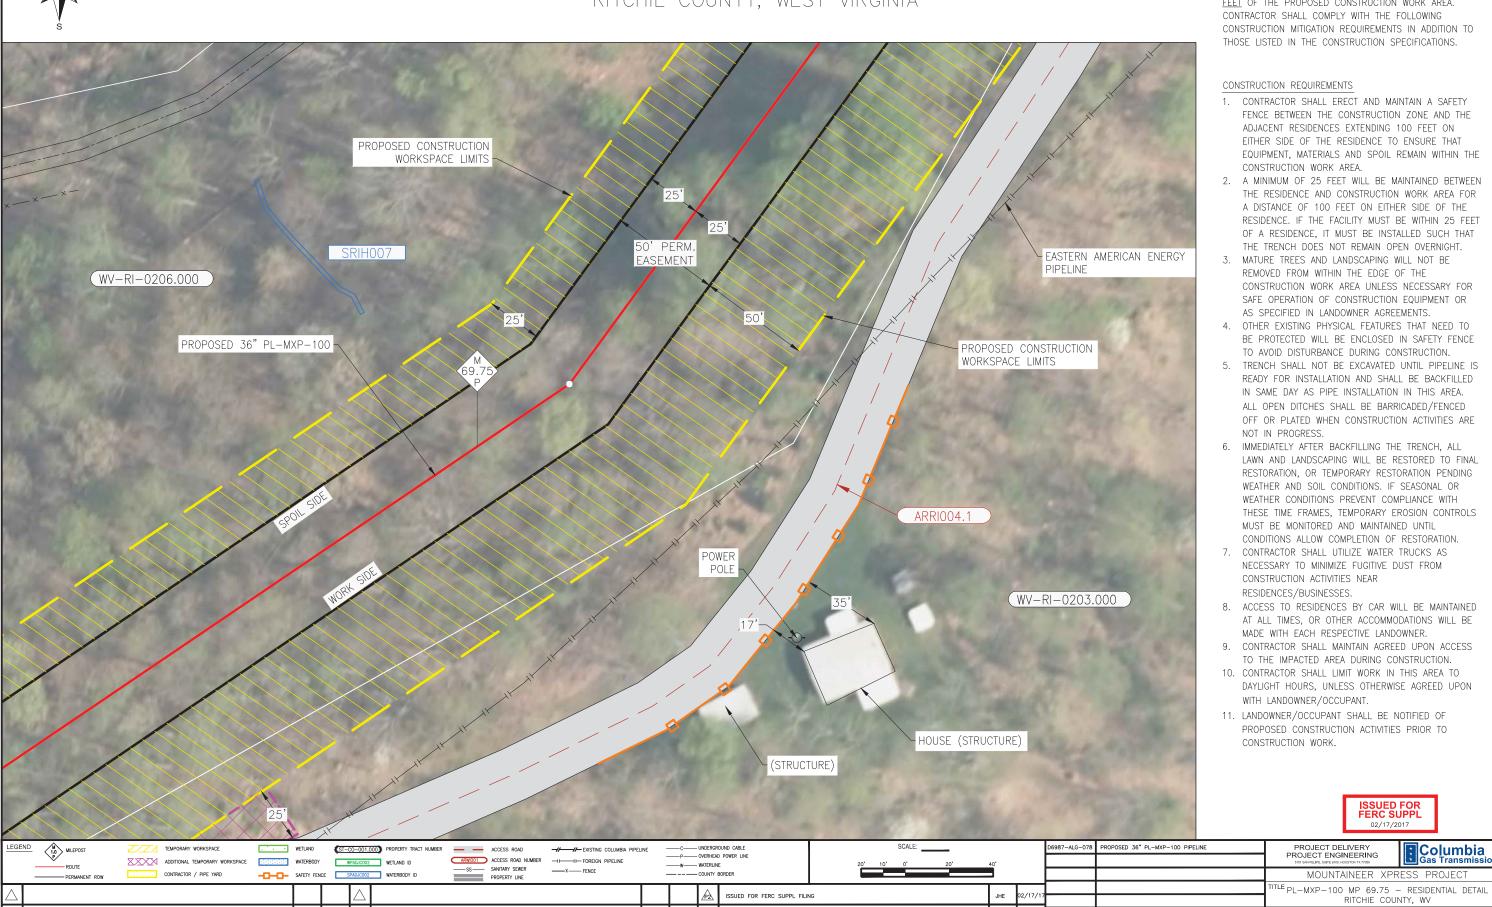

ISSUED FOR FERC SUPPL FILING

REVISIONS

REVISIONS

DESCRIPTION


THIS DRAWING DOCUMENTS MITIGATION MEASURES THAT WILL BE IMPLEMENTED FOR ALL RESIDENCES WITHIN 50 FEET OF THE PROPOSED CONSTRUCTION WORK AREA.

06987-RSD-1



TRACT WV-RI-0248.000

RITCHIE COUNTY, WEST VIRGINIA

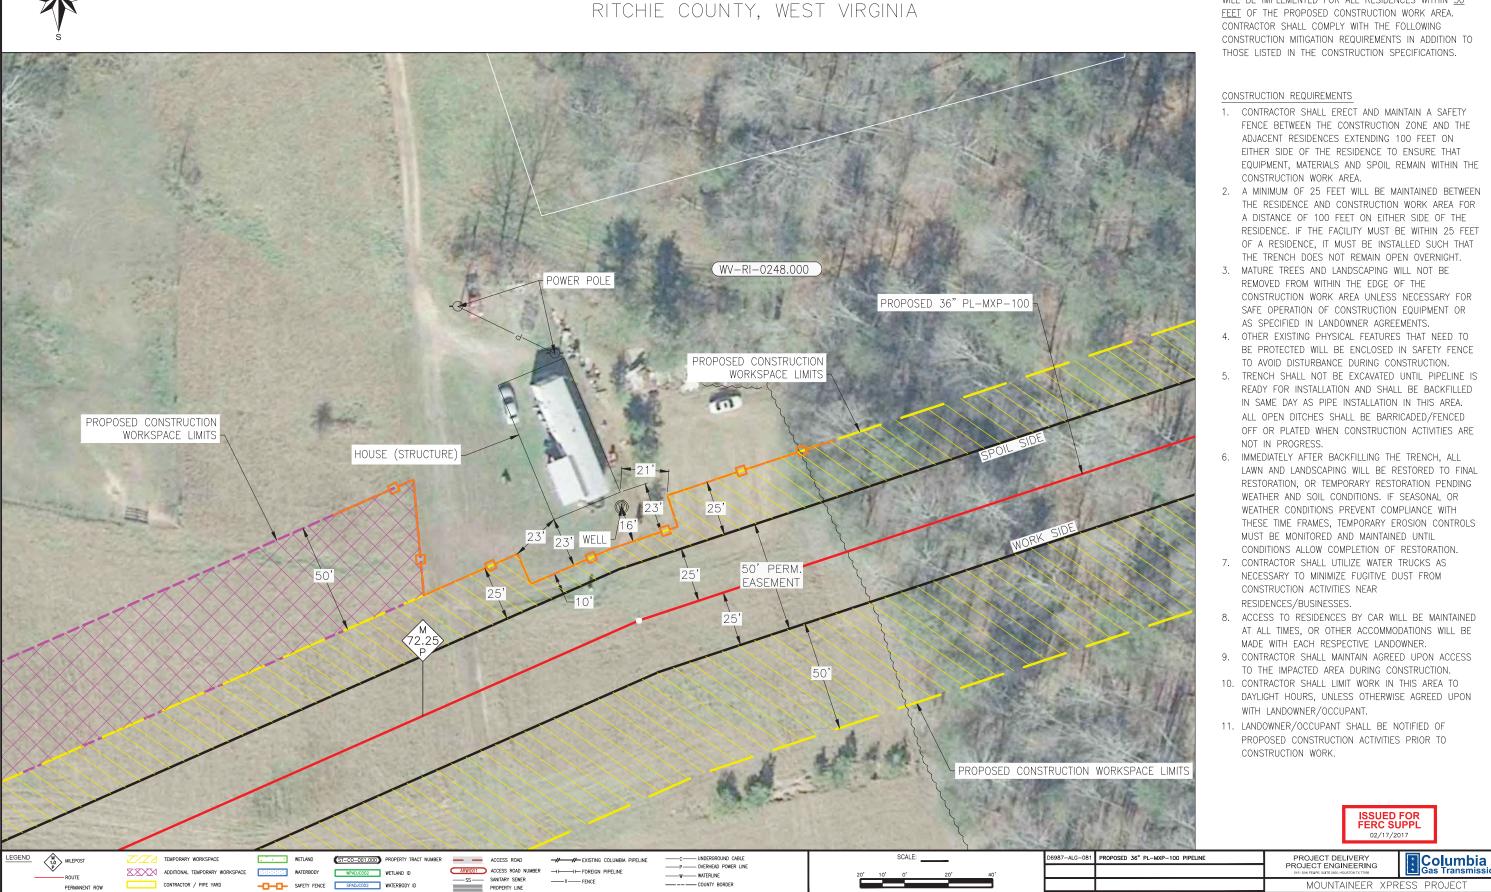

ISSUED FOR FERC SUPPL FILING

REVISIONS

ISSUED FOR FERC FILING

ISSUED FOR FERC SUPPL FILING

REVISIONS

REVISIONS

DESCRIPTION

THIS DRAWING DOCUMENTS MITIGATION MEASURES THAT WILL BE IMPLEMENTED FOR ALL RESIDENCES WITHIN 50 FEET OF THE PROPOSED CONSTRUCTION WORK AREA. CONTRACTOR SHALL COMPLY WITH THE FOLLOWING CONSTRUCTION MITIGATION REQUIREMENTS IN ADDITION TO

- 1. CONTRACTOR SHALL ERECT AND MAINTAIN A SAFETY FENCE BETWEEN THE CONSTRUCTION ZONE AND THE ADJACENT RESIDENCES EXTENDING 100 FEET ON EITHER SIDE OF THE RESIDENCE TO ENSURE THAT EQUIPMENT, MATERIALS AND SPOIL REMAIN WITHIN THE
- 2. A MINIMUM OF 25 FEET WILL BE MAINTAINED BETWEEN THE RESIDENCE AND CONSTRUCTION WORK AREA FOR A DISTANCE OF 100 FEET ON EITHER SIDE OF THE RESIDENCE. IF THE FACILITY MUST BE WITHIN 25 FEET OF A RESIDENCE, IT MUST BE INSTALLED SUCH THAT THE TRENCH DOES NOT REMAIN OPEN OVERNIGHT.
- CONSTRUCTION WORK AREA UNLESS NECESSARY FOR SAFE OPERATION OF CONSTRUCTION EQUIPMENT OR
- 4. OTHER EXISTING PHYSICAL FEATURES THAT NEED TO BE PROTECTED WILL BE ENCLOSED IN SAFETY FENCE TO AVOID DISTURBANCE DURING CONSTRUCTION.
- READY FOR INSTALLATION AND SHALL BE BACKFILLED IN SAME DAY AS PIPE INSTALLATION IN THIS AREA. ALL OPEN DITCHES SHALL BE BARRICADED/FENCED OFF OR PLATED WHEN CONSTRUCTION ACTIVITIES ARE
- LAWN AND LANDSCAPING WILL BE RESTORED TO FINAL RESTORATION, OR TEMPORARY RESTORATION PENDING WEATHER AND SOIL CONDITIONS. IF SEASONAL OR WEATHER CONDITIONS PREVENT COMPLIANCE WITH THESE TIME FRAMES, TEMPORARY EROSION CONTROLS MUST BE MONITORED AND MAINTAINED UNTIL CONDITIONS ALLOW COMPLETION OF RESTORATION.
- NECESSARY TO MINIMIZE FUGITIVE DUST FROM
- AT ALL TIMES, OR OTHER ACCOMMODATIONS WILL BE
- TO THE IMPACTED AREA DURING CONSTRUCTION.
- DAYLIGHT HOURS, UNLESS OTHERWISE AGREED UPON

^{ITLE} PL-MXP-100 MP 72.25 - RESIDENTIAL DETAIL

6987-RSD-1

PROPOSED CONSTRUCTION ACTIVITIES PRIOR TO



CONTRACTOR / PIPE YARD

REVISIONS

SAFETY FENCE SPADJC002 WATERBODY ID

TRACT WV-RI-0434.000

RITCHIE COUNTY, WEST VIRGINIA



ISSUED FOR FERC SUPPL FILING ISSUED FOR FERC SUPPL FILING

REVISIONS

----X----FENCE

REVISIONS

DESCRIPTION

THIS DRAWING DOCUMENTS MITIGATION MEASURES THAT WILL BE IMPLEMENTED FOR ALL RESIDENCES WITHIN 50 FEET OF THE PROPOSED CONSTRUCTION WORK AREA. CONTRACTOR SHALL COMPLY WITH THE FOLLOWING CONSTRUCTION MITIGATION REQUIREMENTS IN ADDITION TO THOSE LISTED IN THE CONSTRUCTION SPECIFICATIONS.

- 1. CONTRACTOR SHALL ERECT AND MAINTAIN A SAFETY FENCE BETWEEN THE CONSTRUCTION ZONE AND THE ADJACENT RESIDENCES EXTENDING 100 FEET ON EITHER SIDE OF THE RESIDENCE TO ENSURE THAT EQUIPMENT, MATERIALS AND SPOIL REMAIN WITHIN THE
- 2. A MINIMUM OF 25 FEET WILL BE MAINTAINED BETWEEN THE RESIDENCE AND CONSTRUCTION WORK AREA FOR A DISTANCE OF 100 FEET ON EITHER SIDE OF THE RESIDENCE. IF THE FACILITY MUST BE WITHIN 25 FEET OF A RESIDENCE, IT MUST BE INSTALLED SUCH THAT THE TRENCH DOES NOT REMAIN OPEN OVERNIGHT.
- 3. MATURE TREES AND LANDSCAPING WILL NOT BE REMOVED FROM WITHIN THE EDGE OF THE CONSTRUCTION WORK AREA UNLESS NECESSARY FOR SAFE OPERATION OF CONSTRUCTION EQUIPMENT OR AS SPECIFIED IN LANDOWNER AGREEMENTS.
- 4. OTHER EXISTING PHYSICAL FEATURES THAT NEED TO BE PROTECTED WILL BE ENCLOSED IN SAFETY FENCE TO AVOID DISTURBANCE DURING CONSTRUCTION.
- 5. TRENCH SHALL NOT BE EXCAVATED UNTIL PIPELINE IS READY FOR INSTALLATION AND SHALL BE BACKFILLED IN SAME DAY AS PIPE INSTALLATION IN THIS AREA. ALL OPEN DITCHES SHALL BE BARRICADED/FENCED OFF OR PLATED WHEN CONSTRUCTION ACTIVITIES ARE
- 6. IMMEDIATELY AFTER BACKFILLING THE TRENCH, ALL LAWN AND LANDSCAPING WILL BE RESTORED TO FINAL RESTORATION, OR TEMPORARY RESTORATION PENDING WEATHER AND SOIL CONDITIONS. IF SEASONAL OR WEATHER CONDITIONS PREVENT COMPLIANCE WITH THESE TIME FRAMES, TEMPORARY EROSION CONTROLS MUST BE MONITORED AND MAINTAINED UNTIL CONDITIONS ALLOW COMPLETION OF RESTORATION.
- 7. CONTRACTOR SHALL UTILIZE WATER TRUCKS AS NECESSARY TO MINIMIZE FUGITIVE DUST FROM CONSTRUCTION ACTIVITIES NEAR
- 8. ACCESS TO RESIDENCES BY CAR WILL BE MAINTAINED AT ALL TIMES, OR OTHER ACCOMMODATIONS WILL BE MADE WITH EACH RESPECTIVE LANDOWNER.
- 9. CONTRACTOR SHALL MAINTAIN AGREED UPON ACCESS TO THE IMPACTED AREA DURING CONSTRUCTION.
- 10. CONTRACTOR SHALL LIMIT WORK IN THIS AREA TO DAYLIGHT HOURS, UNLESS OTHERWISE AGREED UPON WITH LANDOWNER/OCCUPANT.
- 11. LANDOWNER/OCCUPANT SHALL BE NOTIFIED OF PROPOSED CONSTRUCTION ACTIVITIES PRIOR TO

REFERENCE


MOUNTAINEER XPRESS PROJECT

06987-RSD-1

^{ITLE} PL-MXP-100 MP 79.1 - RESIDENTIAL DETAIL RITCHIE COUNTY, WV



TRACT WV-WI-0094.000

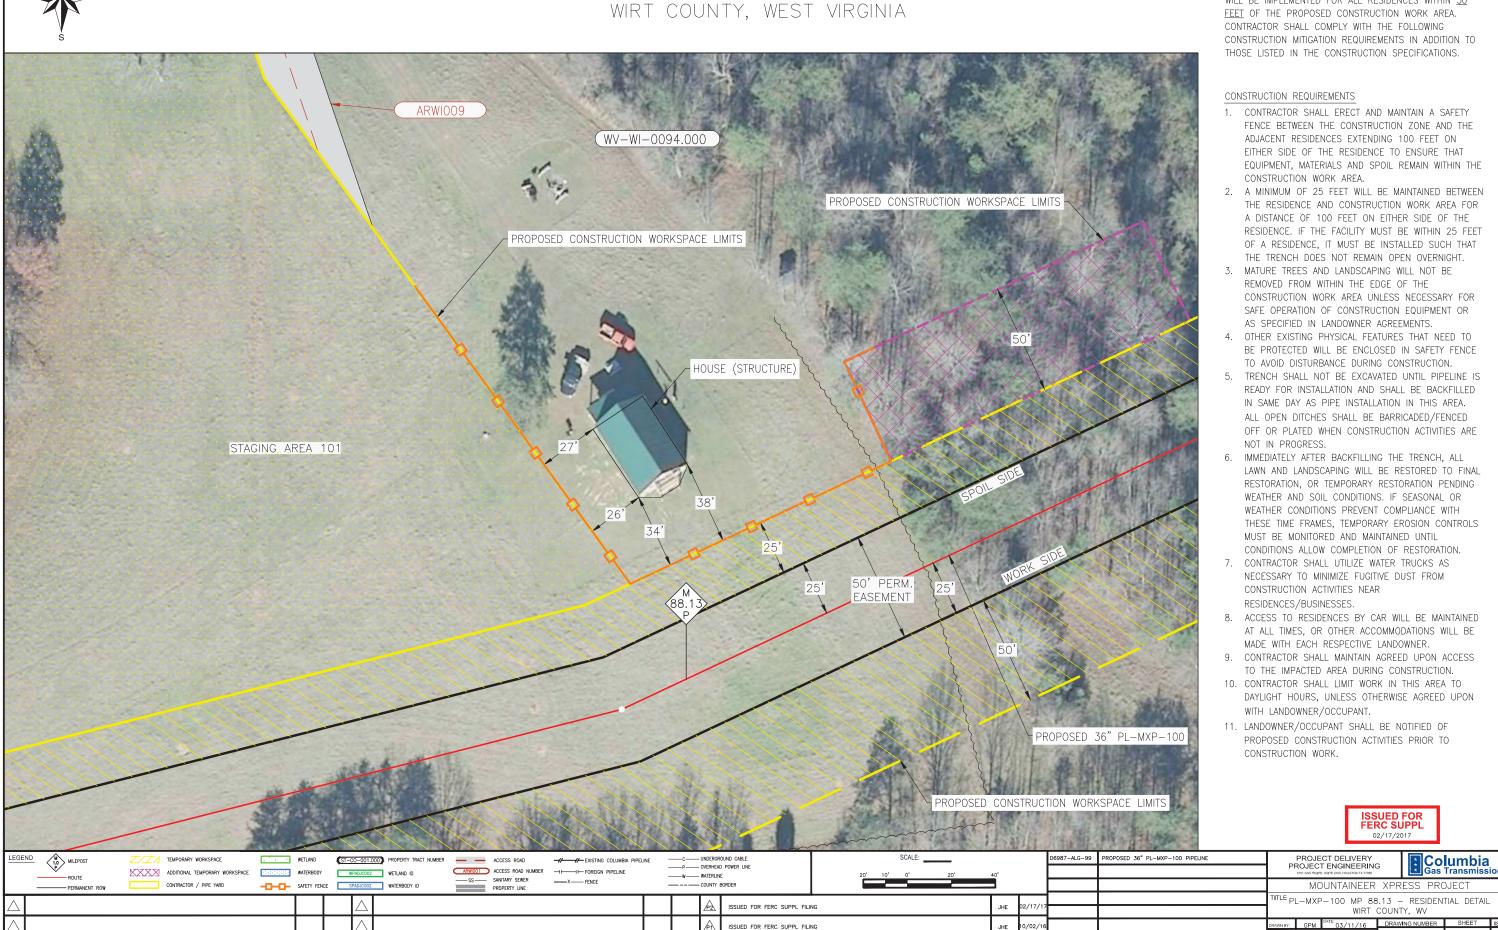

REVISIONS

REVISIONS

DESCRIPTION

REFERENCE

WG. NO.

THIS DRAWING DOCUMENTS MITIGATION MEASURES THAT WILL BE IMPLEMENTED FOR ALL RESIDENCES WITHIN 50




TRACT WV-JA-0364.000

DESCRIPTION

THIS DRAWING DOCUMENTS MITIGATION MEASURES THAT WILL BE IMPLEMENTED FOR ALL RESIDENCES WITHIN 50

JACKSON COUNTY, WEST VIRGINIA

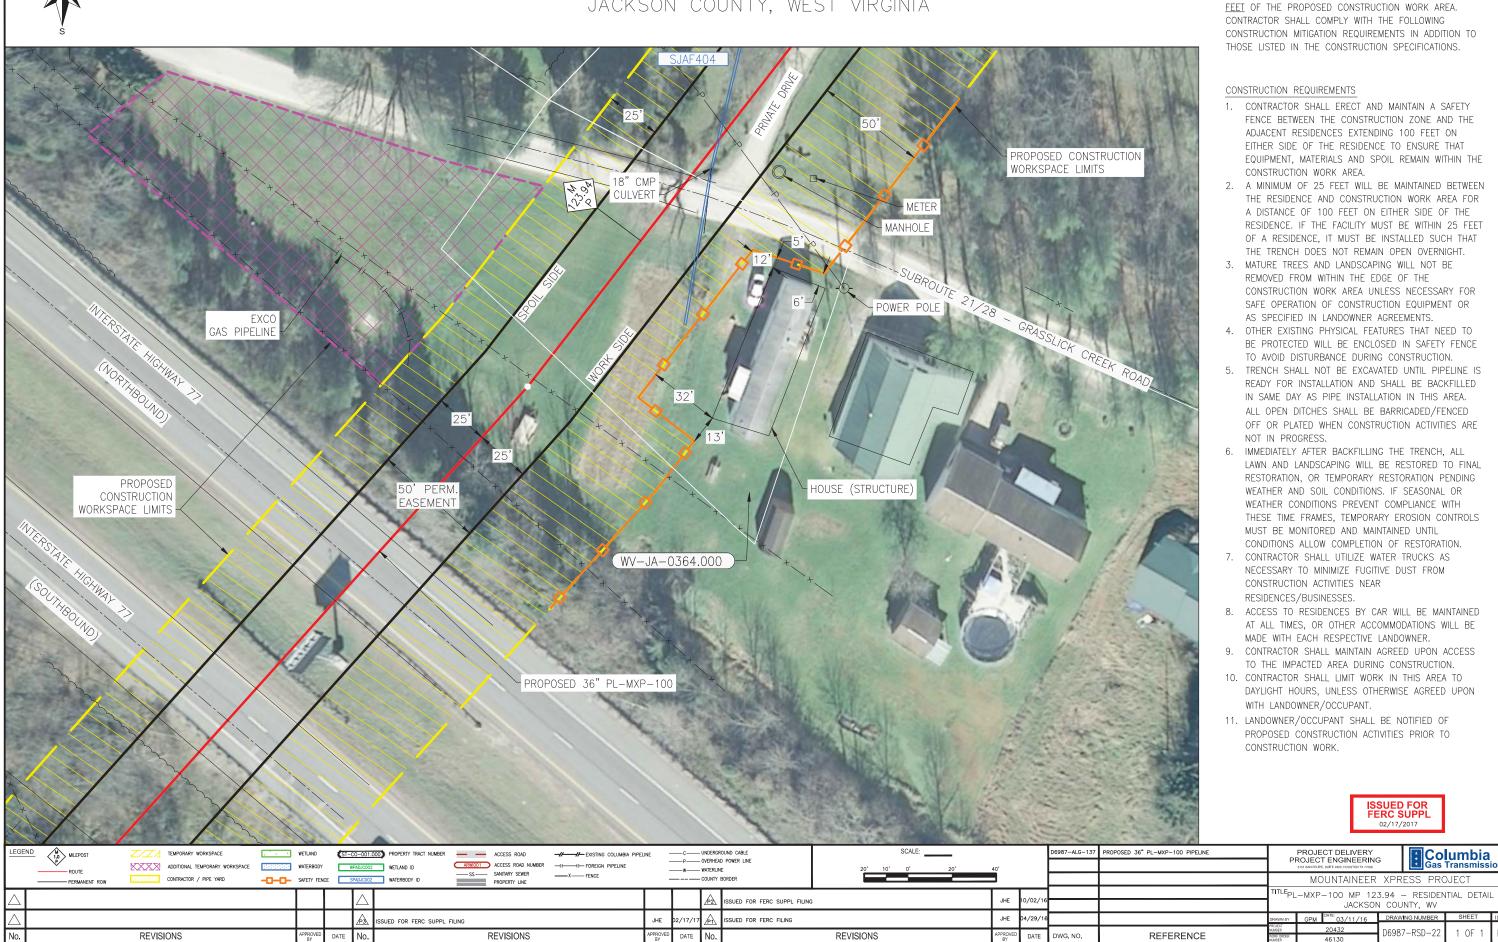



TRACT WV-JA-0424.000


DESCRIPTION

REFERENCE

THIS DRAWING DOCUMENTS MITIGATION MEASURES THAT WILL BE IMPLEMENTED FOR ALL RESIDENCES WITHIN 50

FEET OF THE PROPOSED CONSTRUCTION WORK AREA.

JACKSON COUNTY, WEST VIRGINIA

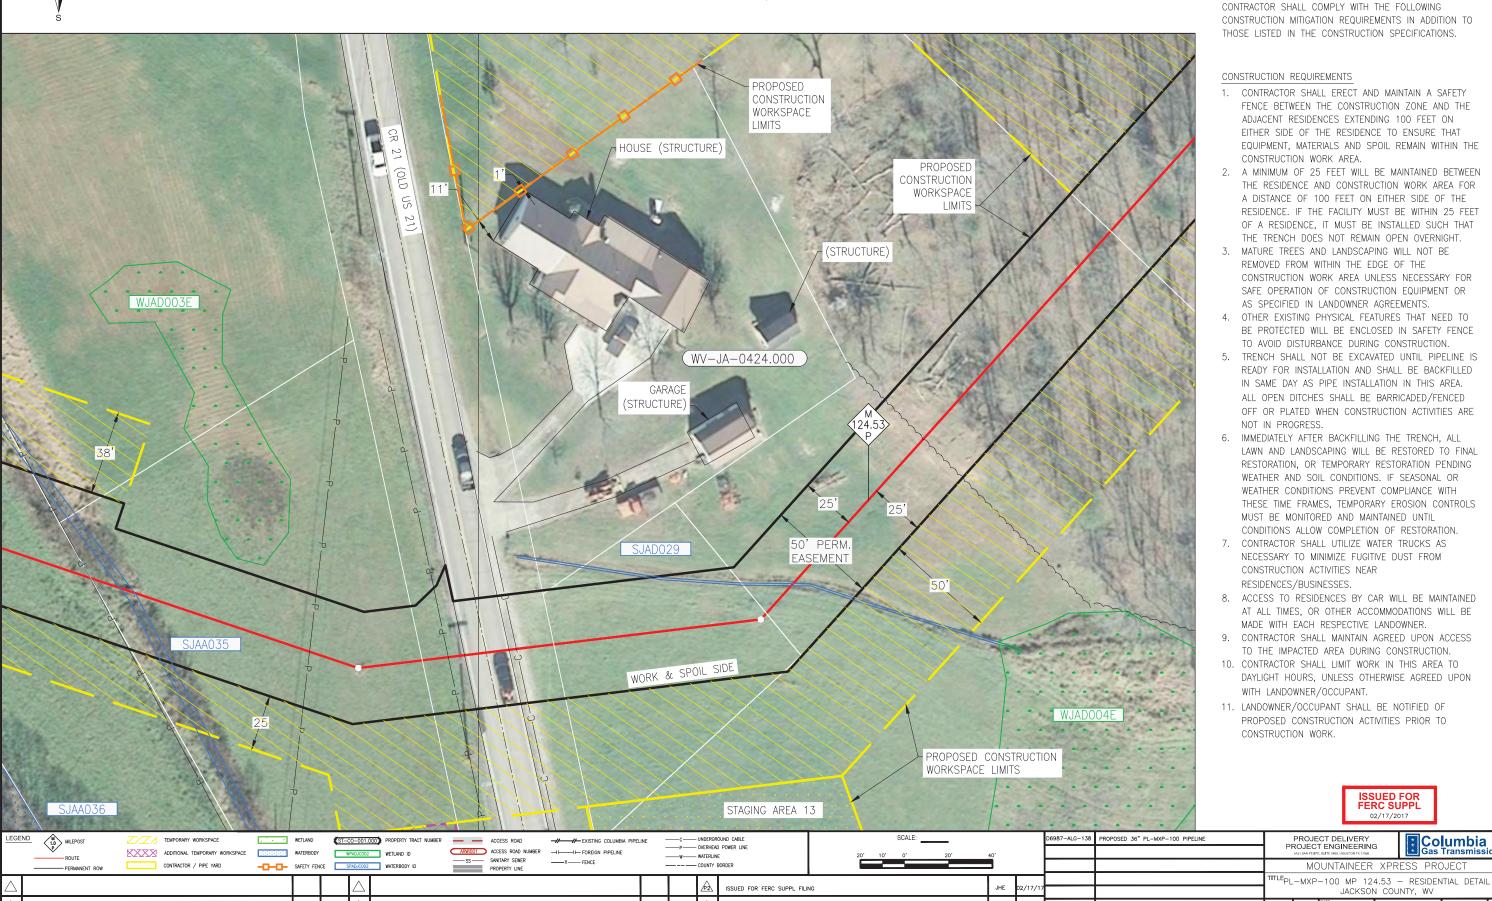

ISSUED FOR FERC SUPPL FILING


REVISIONS

REVISIONS



TRACT WV-JA-0368.000

JACKSON COUNTY, WEST VIRGINIA

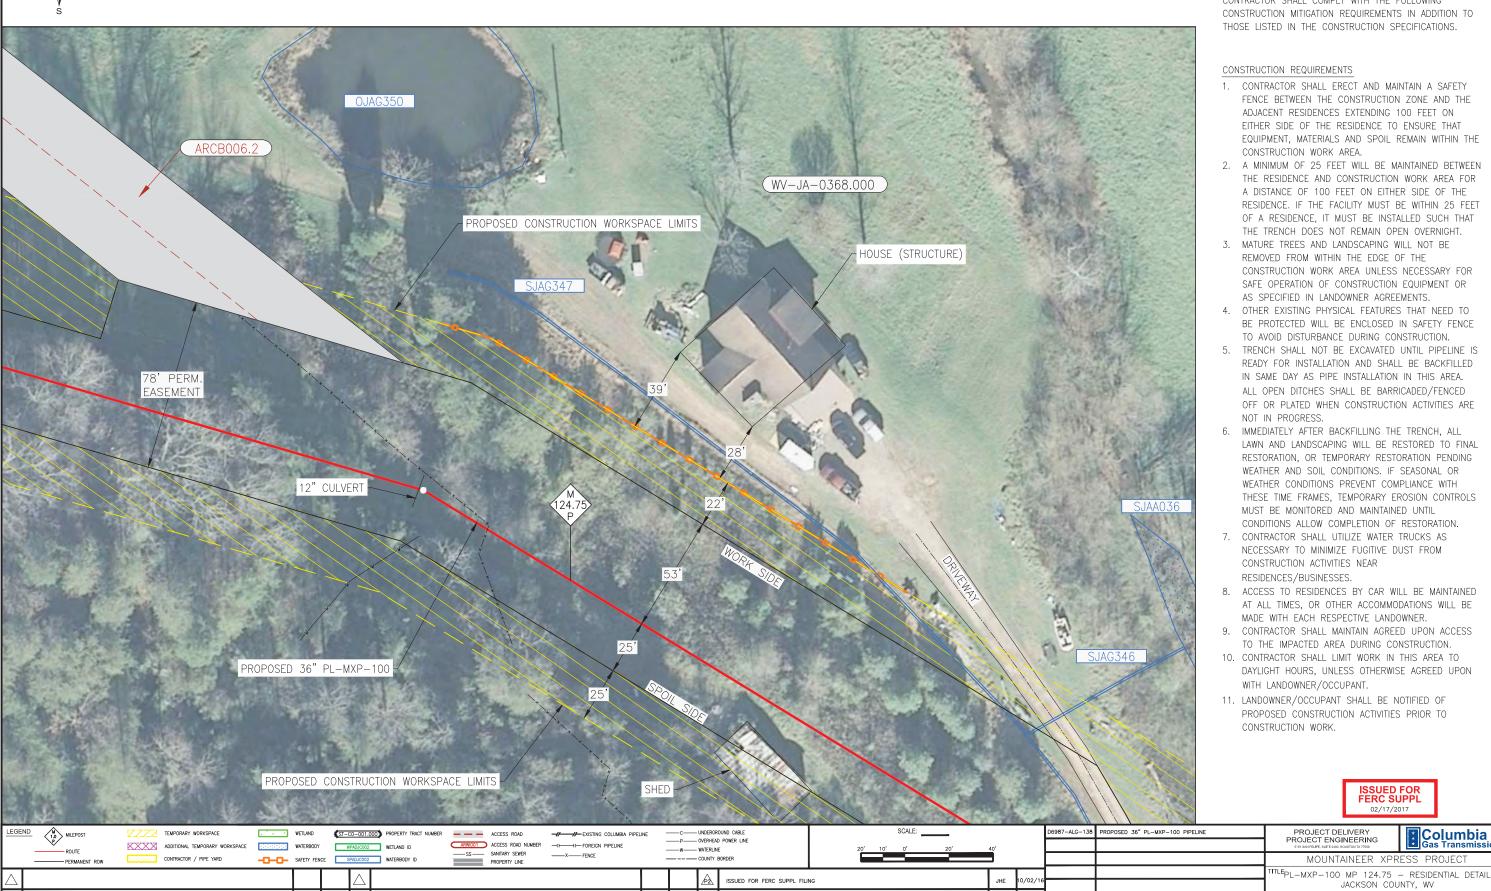

ISSUED FOR FERC FILING

REVISIONS

ISSUED FOR FERC SUPPL FILING

REVISIONS

REVISIONS

DESCRIPTION

THIS DRAWING DOCUMENTS MITIGATION MEASURES THAT WILL BE IMPLEMENTED FOR ALL RESIDENCES WITHIN 50 FEET OF THE PROPOSED CONSTRUCTION WORK AREA. CONTRACTOR SHALL COMPLY WITH THE FOLLOWING CONSTRUCTION MITIGATION REQUIREMENTS IN ADDITION TO

- FENCE BETWEEN THE CONSTRUCTION ZONE AND THE ADJACENT RESIDENCES EXTENDING 100 FEET ON EITHER SIDE OF THE RESIDENCE TO ENSURE THAT EQUIPMENT, MATERIALS AND SPOIL REMAIN WITHIN THE
- THE RESIDENCE AND CONSTRUCTION WORK AREA FOR A DISTANCE OF 100 FEET ON EITHER SIDE OF THE RESIDENCE. IF THE FACILITY MUST BE WITHIN 25 FEET OF A RESIDENCE, IT MUST BE INSTALLED SUCH THAT THE TRENCH DOES NOT REMAIN OPEN OVERNIGHT.
- CONSTRUCTION WORK AREA UNLESS NECESSARY FOR SAFE OPERATION OF CONSTRUCTION EQUIPMENT OR
- BE PROTECTED WILL BE ENCLOSED IN SAFETY FENCE
- READY FOR INSTALLATION AND SHALL BE BACKFILLED IN SAME DAY AS PIPE INSTALLATION IN THIS AREA. ALL OPEN DITCHES SHALL BE BARRICADED/FENCED OFF OR PLATED WHEN CONSTRUCTION ACTIVITIES ARE
- LAWN AND LANDSCAPING WILL BE RESTORED TO FINAL RESTORATION, OR TEMPORARY RESTORATION PENDING WEATHER AND SOIL CONDITIONS. IF SEASONAL OR WEATHER CONDITIONS PREVENT COMPLIANCE WITH THESE TIME FRAMES, TEMPORARY EROSION CONTROLS
- AT ALL TIMES, OR OTHER ACCOMMODATIONS WILL BE
- 9. CONTRACTOR SHALL MAINTAIN AGREED UPON ACCESS
- DAYLIGHT HOURS, UNLESS OTHERWISE AGREED UPON



ADDITIONAL TEMPORARY WORKSPACE

REVISIONS

CONTRACTOR / PIPE YARD

TRACT WV-JA-0623.000

JACKSON COUNTY, WEST VIRGINIA



ARWIGO1 ACCESS ROAD NUMBER —I — FORFICE PIPELINE

REVISIONS

——X—— FENCE

ISSUED FOR FERC SUPPL FILING

ISSUED FOR FERC SUPPL FILING

REVISIONS

WPADJC002 WETLAND ID

SAFETY FENCE SPADJC002 WATERBODY ID

DESCRIPTION

THIS DRAWING DOCUMENTS MITIGATION MEASURES THAT WILL BE IMPLEMENTED FOR ALL RESIDENCES WITHIN 50 FEET OF THE PROPOSED CONSTRUCTION WORK AREA. CONTRACTOR SHALL COMPLY WITH THE FOLLOWING CONSTRUCTION MITIGATION REQUIREMENTS IN ADDITION TO THOSE LISTED IN THE CONSTRUCTION SPECIFICATIONS.

CONSTRUCTION REQUIREMENTS

- 1. CONTRACTOR SHALL ERECT AND MAINTAIN A SAFETY FENCE BETWEEN THE CONSTRUCTION ZONE AND THE ADJACENT RESIDENCES EXTENDING 100 FEET ON EITHER SIDE OF THE RESIDENCE TO ENSURE THAT EQUIPMENT, MATERIALS AND SPOIL REMAIN WITHIN THE CONSTRUCTION WORK AREA.
- 2. A MINIMUM OF 25 FEET WILL BE MAINTAINED BETWEEN THE RESIDENCE AND CONSTRUCTION WORK AREA FOR A DISTANCE OF 100 FEET ON EITHER SIDE OF THE RESIDENCE. IF THE FACILITY MUST BE WITHIN 25 FEET OF A RESIDENCE, IT MUST BE INSTALLED SUCH THAT THE TRENCH DOES NOT REMAIN OPEN OVERNIGHT.
- MATURE TREES AND LANDSCAPING WILL NOT BE REMOVED FROM WITHIN THE EDGE OF THE CONSTRUCTION WORK AREA UNLESS NECESSARY FOR SAFE OPERATION OF CONSTRUCTION EQUIPMENT OR AS SPECIFIED IN LANDOWNER AGREEMENTS.
- 4. OTHER EXISTING PHYSICAL FEATURES THAT NEED TO BE PROTECTED WILL BE ENCLOSED IN SAFETY FENCE TO AVOID DISTURBANCE DURING CONSTRUCTION.
- 5. TRENCH SHALL NOT BE EXCAVATED UNTIL PIPELINE IS READY FOR INSTALLATION AND SHALL BE BACKFILLED IN SAME DAY AS PIPE INSTALLATION IN THIS AREA. ALL OPEN DITCHES SHALL BE BARRICADED/FENCED OFF OR PLATED WHEN CONSTRUCTION ACTIVITIES ARE NOT IN PROGRESS.
- 6. IMMEDIATELY AFTER BACKFILLING THE TRENCH, ALL LAWN AND LANDSCAPING WILL BE RESTORED TO FINAL RESTORATION, OR TEMPORARY RESTORATION PENDING WEATHER AND SOIL CONDITIONS. IF SEASONAL OR WEATHER CONDITIONS PREVENT COMPLIANCE WITH THESE TIME FRAMES, TEMPORARY EROSION CONTROLS MUST BE MONITORED AND MAINTAINED UNTIL CONDITIONS ALLOW COMPLETION OF RESTORATION.
- 7. CONTRACTOR SHALL UTILIZE WATER TRUCKS AS NECESSARY TO MINIMIZE FUGITIVE DUST FROM CONSTRUCTION ACTIVITIES NEAR RESIDENCES/BUSINESSES.
- 8. ACCESS TO RESIDENCES BY CAR WILL BE MAINTAINED AT ALL TIMES, OR OTHER ACCOMMODATIONS WILL BE MADE WITH EACH RESPECTIVE LANDOWNER.
- 9. CONTRACTOR SHALL MAINTAIN AGREED UPON ACCESS TO THE IMPACTED AREA DURING CONSTRUCTION.
- 10. CONTRACTOR SHALL LIMIT WORK IN THIS AREA TO DAYLIGHT HOURS, UNLESS OTHERWISE AGREED UPON WITH LANDOWNER/OCCUPANT.
- 11. LANDOWNER/OCCUPANT SHALL BE NOTIFIED OF PROPOSED CONSTRUCTION ACTIVITIES PRIOR TO CONSTRUCTION WORK.

PROJECT DELIVERY PROJECT ENGINEERING

REFERENCE

MOUNTAINEER XPRESS PROJECT


JACKSON COUNTY, WV

TLE PL-MXP-100 MP 129.8 - RESIDENTIAL DETAIL



TRACT WV-PU-0062.001

PUTNAM COUNTY, WEST VIRGINIA

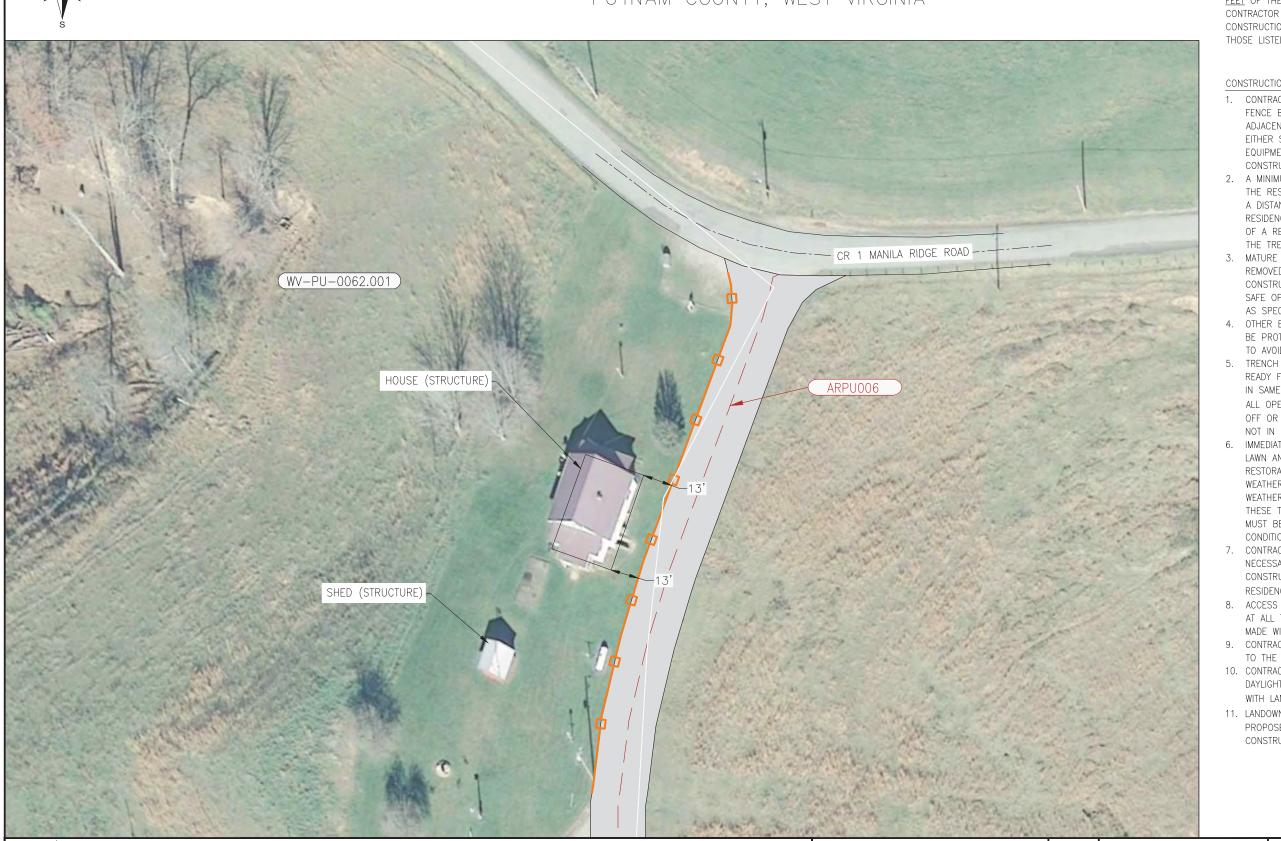

DESCRIPTION

THIS DRAWING DOCUMENTS MITIGATION MEASURES THAT WILL BE IMPLEMENTED FOR ALL RESIDENCES WITHIN 50 FEET OF THE PROPOSED CONSTRUCTION WORK AREA. CONTRACTOR SHALL COMPLY WITH THE FOLLOWING CONSTRUCTION MITIGATION REQUIREMENTS IN ADDITION TO THOSE LISTED IN THE CONSTRUCTION SPECIFICATIONS.

CONSTRUCTION REQUIREMENTS

- 1. CONTRACTOR SHALL ERECT AND MAINTAIN A SAFETY FENCE BETWEEN THE CONSTRUCTION ZONE AND THE ADJACENT RESIDENCES EXTENDING 100 FEET ON EITHER SIDE OF THE RESIDENCE TO ENSURE THAT EQUIPMENT, MATERIALS AND SPOIL REMAIN WITHIN THE CONSTRUCTION WORK AREA.
- 2. A MINIMUM OF 25 FEET WILL BE MAINTAINED BETWEEN THE RESIDENCE AND CONSTRUCTION WORK AREA FOR A DISTANCE OF 100 FEET ON EITHER SIDE OF THE RESIDENCE. IF THE FACILITY MUST BE WITHIN 25 FEET OF A RESIDENCE, IT MUST BE INSTALLED SUCH THAT THE TRENCH DOES NOT REMAIN OPEN OVERNIGHT.
- 3. MATURE TREES AND LANDSCAPING WILL NOT BE REMOVED FROM WITHIN THE EDGE OF THE CONSTRUCTION WORK AREA UNLESS NECESSARY FOR SAFE OPERATION OF CONSTRUCTION EQUIPMENT OR AS SPECIFIED IN LANDOWNER AGREEMENTS.
- 4. OTHER EXISTING PHYSICAL FEATURES THAT NEED TO BE PROTECTED WILL BE ENCLOSED IN SAFETY FENCE TO AVOID DISTURBANCE DURING CONSTRUCTION.
- 5. TRENCH SHALL NOT BE EXCAVATED UNTIL PIPELINE IS READY FOR INSTALLATION AND SHALL BE BACKFILLED IN SAME DAY AS PIPE INSTALLATION IN THIS AREA. ALL OPEN DITCHES SHALL BE BARRICADED/FENCED OFF OR PLATED WHEN CONSTRUCTION ACTIVITIES ARE NOT IN PROGRESS.
- 6. IMMEDIATELY AFTER BACKFILLING THE TRENCH, ALL LAWN AND LANDSCAPING WILL BE RESTORED TO FINAL RESTORATION, OR TEMPORARY RESTORATION PENDING WEATHER AND SOIL CONDITIONS. IF SEASONAL OR WEATHER CONDITIONS PREVENT COMPLIANCE WITH THESE TIME FRAMES, TEMPORARY EROSION CONTROLS MUST BE MONITORED AND MAINTAINED UNTIL CONDITIONS ALLOW COMPLETION OF RESTORATION.
- 7. CONTRACTOR SHALL UTILIZE WATER TRUCKS AS NECESSARY TO MINIMIZE FUGITIVE DUST FROM CONSTRUCTION ACTIVITIES NEAR RESIDENCES/BUSINESSES.
- 8. ACCESS TO RESIDENCES BY CAR WILL BE MAINTAINED AT ALL TIMES, OR OTHER ACCOMMODATIONS WILL BE MADE WITH EACH RESPECTIVE LANDOWNER.
- 9. CONTRACTOR SHALL MAINTAIN AGREED UPON ACCESS TO THE IMPACTED AREA DURING CONSTRUCTION.
- 10. CONTRACTOR SHALL LIMIT WORK IN THIS AREA TO DAYLIGHT HOURS, UNLESS OTHERWISE AGREED UPON WITH LANDOWNER/OCCUPANT.
- 11. LANDOWNER/OCCUPANT SHALL BE NOTIFIED OF PROPOSED CONSTRUCTION ACTIVITIES PRIOR TO CONSTRUCTION WORK.

ISSUED FOR FERC SUPPL





REVISIONS











REVISIONS



ISSUED FOR FERC SUPPL FILING

ISSUED FOR FERC SUPPL FILING

REVISIONS

REFERENCE

MOUNTAINEER XPRESS PROJECT ^{FLE}PL-MXP-100 MP 134.9 - RESIDENTIAL DETAIL

PROJECT DELIVERY PROJECT ENGINEERING

PUTNAM COUNTY, WV



TRACT WV-PU-0175.000

PUTNAM COUNTY, WEST VIRGINIA



DESCRIPTION

THIS DRAWING DOCUMENTS MITIGATION MEASURES THAT WILL BE IMPLEMENTED FOR ALL RESIDENCES WITHIN 50 FEET OF THE PROPOSED CONSTRUCTION WORK AREA. CONTRACTOR SHALL COMPLY WITH THE FOLLOWING CONSTRUCTION MITIGATION REQUIREMENTS IN ADDITION TO THOSE LISTED IN THE CONSTRUCTION SPECIFICATIONS.

CONSTRUCTION REQUIREMENTS

- 1. CONTRACTOR SHALL ERECT AND MAINTAIN A SAFETY FENCE BETWEEN THE CONSTRUCTION ZONE AND THE ADJACENT RESIDENCES EXTENDING 100 FEET ON EITHER SIDE OF THE RESIDENCE TO ENSURE THAT EQUIPMENT, MATERIALS AND SPOIL REMAIN WITHIN THE CONSTRUCTION WORK AREA.
- 2. A MINIMUM OF 25 FEET WILL BE MAINTAINED BETWEEN THE RESIDENCE AND CONSTRUCTION WORK AREA FOR A DISTANCE OF 100 FEET ON EITHER SIDE OF THE RESIDENCE. IF THE FACILITY MUST BE WITHIN 25 FEET OF A RESIDENCE, IT MUST BE INSTALLED SUCH THAT THE TRENCH DOES NOT REMAIN OPEN OVERNIGHT.
- 3. MATURE TREES AND LANDSCAPING WILL NOT BE REMOVED FROM WITHIN THE EDGE OF THE CONSTRUCTION WORK AREA UNLESS NECESSARY FOR SAFE OPERATION OF CONSTRUCTION EQUIPMENT OR AS SPECIFIED IN LANDOWNER AGREEMENTS.
- 4. OTHER EXISTING PHYSICAL FEATURES THAT NEED TO BE PROTECTED WILL BE ENCLOSED IN SAFETY FENCE TO AVOID DISTURBANCE DURING CONSTRUCTION.
- 5. TRENCH SHALL NOT BE EXCAVATED UNTIL PIPELINE IS READY FOR INSTALLATION AND SHALL BE BACKFILLED IN SAME DAY AS PIPE INSTALLATION IN THIS AREA. ALL OPEN DITCHES SHALL BE BARRICADED/FENCED OFF OR PLATED WHEN CONSTRUCTION ACTIVITIES ARE NOT IN PROGRESS.
- 6. IMMEDIATELY AFTER BACKFILLING THE TRENCH, ALL LAWN AND LANDSCAPING WILL BE RESTORED TO FINAL RESTORATION, OR TEMPORARY RESTORATION PENDING WEATHER AND SOIL CONDITIONS. IF SEASONAL OR WEATHER CONDITIONS PREVENT COMPLIANCE WITH THESE TIME FRAMES, TEMPORARY EROSION CONTROLS MUST BE MONITORED AND MAINTAINED UNTIL CONDITIONS ALLOW COMPLETION OF RESTORATION.
- 7. CONTRACTOR SHALL UTILIZE WATER TRUCKS AS NECESSARY TO MINIMIZE FUGITIVE DUST FROM CONSTRUCTION ACTIVITIES NEAR RESIDENCES/BUSINESSES.
- 8. ACCESS TO RESIDENCES BY CAR WILL BE MAINTAINED AT ALL TIMES, OR OTHER ACCOMMODATIONS WILL BE MADE WITH EACH RESPECTIVE LANDOWNER.
- CONTRACTOR SHALL MAINTAIN AGREED UPON ACCESS TO THE IMPACTED AREA DURING CONSTRUCTION.
- 10. CONTRACTOR SHALL LIMIT WORK IN THIS AREA TO DAYLIGHT HOURS, UNLESS OTHERWISE AGREED UPON WITH LANDOWNER/OCCUPANT.
- 11. LANDOWNER/OCCUPANT SHALL BE NOTIFIED OF PROPOSED CONSTRUCTION ACTIVITIES PRIOR TO CONSTRUCTION WORK.

ADDITIONAL TEMPORARY WORKSPACE CONTRACTOR / PIPE YARD

WATERBODY

SAFETY FENCE SPADJC002 WATERBODY ID

WPADJC002 WETLAND ID

- ACCESS ROAD

ARWIOO1 ACCESS ROAD NUMBER —I ——I — FOREIGN PIPELINE SANITARY SEWER PROPERTY LINE

____X____FENCE

- UNDERGROUND CARLE

ISSUED FOR FERC SUPPL FILING

MOUNTAINEER XPRESS PROJECT

PROPOSED 36" PL-MXP-100 PIPELINE

^{FLE}PL-MXP-100 MP 138.5 - RESIDENTIAL DETAIL PUTNAM COUNTY, WV

PROJECT DELIVERY PROJECT ENGINEERING

Columbia

ISSUED FOR FERC SUPPL FILING REFERENCE REVISIONS REVISIONS REVISIONS



TRACT WV-PU-0239.000

PUTNAM COUNTY, WEST VIRGINIA



REVISIONS

REVISIONS

DESCRIPTION

REFERENCE

THIS DRAWING DOCUMENTS MITIGATION MEASURES THAT WILL BE IMPLEMENTED FOR ALL RESIDENCES WITHIN 50 FEET OF THE PROPOSED CONSTRUCTION WORK AREA. CONTRACTOR SHALL COMPLY WITH THE FOLLOWING CONSTRUCTION MITIGATION REQUIREMENTS IN ADDITION THOSE LISTED IN THE CONSTRUCTION SPECIFICATIONS.



TRACT WV-CB-0065.000

CABELL COUNTY, WEST VIRGINIA



ISSUED FOR FERC SUPPL FILING ISSUED FOR FERC FILING

REVISIONS

ISSUED FOR FERC SUPPL FILING

REVISIONS

REVISIONS

DESCRIPTION

THIS DRAWING DOCUMENTS MITIGATION MEASURES THAT WILL BE IMPLEMENTED FOR ALL RESIDENCES WITHIN $\underline{50}$ FEET OF THE PROPOSED CONSTRUCTION WORK AREA. CONTRACTOR SHALL COMPLY WITH THE FOLLOWING CONSTRUCTION MITIGATION REQUIREMENTS IN ADDITION TO

- 1. CONTRACTOR SHALL ERECT AND MAINTAIN A SAFETY FENCE BETWEEN THE CONSTRUCTION ZONE AND THE ADJACENT RESIDENCES EXTENDING 100 FEET ON EITHER SIDE OF THE RESIDENCE TO ENSURE THAT EQUIPMENT, MATERIALS AND SPOIL REMAIN WITHIN THE
- 2. A MINIMUM OF 25 FEET WILL BE MAINTAINED BETWEEN THE RESIDENCE AND CONSTRUCTION WORK AREA FOR A DISTANCE OF 100 FEET ON EITHER SIDE OF THE RESIDENCE. IF THE FACILITY MUST BE WITHIN 25 FEET OF A RESIDENCE, IT MUST BE INSTALLED SUCH THAT THE TRENCH DOES NOT REMAIN OPEN OVERNIGHT.
- 3. MATURE TREES AND LANDSCAPING WILL NOT BE REMOVED FROM WITHIN THE EDGE OF THE CONSTRUCTION WORK AREA UNLESS NECESSARY FOR SAFE OPERATION OF CONSTRUCTION EQUIPMENT OR AS SPECIFIED IN LANDOWNER AGREEMENTS.
- 4. OTHER EXISTING PHYSICAL FEATURES THAT NEED TO BE PROTECTED WILL BE ENCLOSED IN SAFETY FENCE TO AVOID DISTURBANCE DURING CONSTRUCTION.
- 5. TRENCH SHALL NOT BE EXCAVATED UNTIL PIPELINE IS READY FOR INSTALLATION AND SHALL BE BACKFILLED IN SAME DAY AS PIPE INSTALLATION IN THIS AREA. ALL OPEN DITCHES SHALL BE BARRICADED/FENCED OFF OR PLATED WHEN CONSTRUCTION ACTIVITIES ARE
- 6. IMMEDIATELY AFTER BACKFILLING THE TRENCH, ALL LAWN AND LANDSCAPING WILL BE RESTORED TO FINAL RESTORATION, OR TEMPORARY RESTORATION PENDING WEATHER AND SOIL CONDITIONS. IF SEASONAL OR WEATHER CONDITIONS PREVENT COMPLIANCE WITH THESE TIME FRAMES, TEMPORARY EROSION CONTROLS MUST BE MONITORED AND MAINTAINED UNTIL
- 7. CONTRACTOR SHALL UTILIZE WATER TRUCKS AS NECESSARY TO MINIMIZE FUGITIVE DUST FROM
- 8. ACCESS TO RESIDENCES BY CAR WILL BE MAINTAINED AT ALL TIMES, OR OTHER ACCOMMODATIONS WILL BE MADE WITH EACH RESPECTIVE LANDOWNER.
- CONTRACTOR SHALL MAINTAIN AGREED UPON ACCESS TO THE IMPACTED AREA DURING CONSTRUCTION.
- DAYLIGHT HOURS, UNLESS OTHERWISE AGREED UPON
- PROPOSED CONSTRUCTION ACTIVITIES PRIOR TO


REFERENCE

^{ILE}PL—MXP—100 MP 158.20 — RESIDENTIAL DETAIL CABELL COUNTY, WV



TRACT WV-CB-0194.000

CABELL COUNTY, WEST VIRGINIA

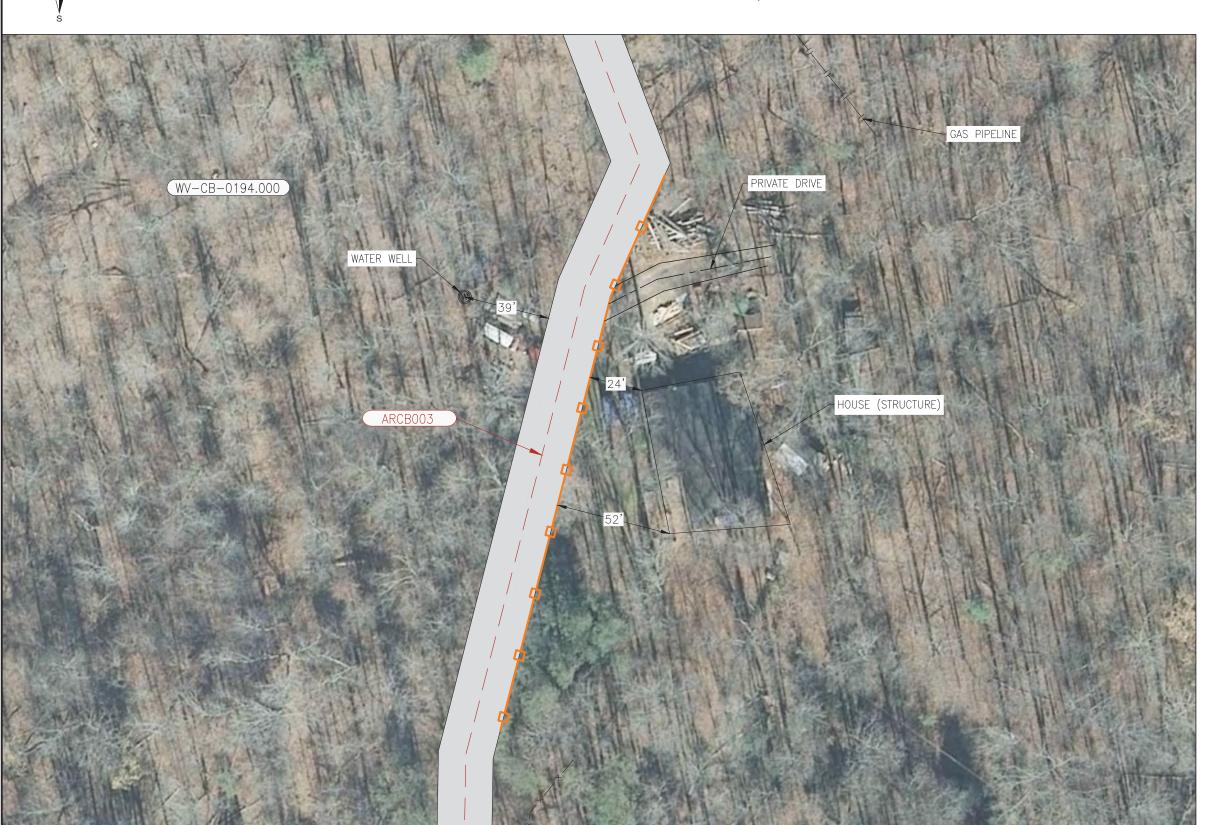

DESCRIPTION

THIS DRAWING DOCUMENTS MITIGATION MEASURES THAT WILL BE IMPLEMENTED FOR ALL RESIDENCES WITHIN $\underline{50}$ FEET OF THE PROPOSED CONSTRUCTION WORK AREA. CONTRACTOR SHALL COMPLY WITH THE FOLLOWING CONSTRUCTION MITIGATION REQUIREMENTS IN ADDITION TO THOSE LISTED IN THE CONSTRUCTION SPECIFICATIONS.


CONSTRUCTION REQUIREMENTS

- 1. CONTRACTOR SHALL ERECT AND MAINTAIN A SAFETY FENCE BETWEEN THE CONSTRUCTION ZONE AND THE ADJACENT RESIDENCES EXTENDING 100 FEET ON EITHER SIDE OF THE RESIDENCE TO ENSURE THAT EQUIPMENT, MATERIALS AND SPOIL REMAIN WITHIN THE CONSTRUCTION WORK AREA.
- 2. A MINIMUM OF 25 FEET WILL BE MAINTAINED BETWEEN THE RESIDENCE AND CONSTRUCTION WORK AREA FOR A DISTANCE OF 100 FEET ON EITHER SIDE OF THE RESIDENCE. IF THE FACILITY MUST BE WITHIN 25 FEET OF A RESIDENCE, IT MUST BE INSTALLED SUCH THAT THE TRENCH DOES NOT REMAIN OPEN OVERNIGHT.
- 3. MATURE TREES AND LANDSCAPING WILL NOT BE REMOVED FROM WITHIN THE EDGE OF THE CONSTRUCTION WORK AREA UNLESS NECESSARY FOR SAFE OPERATION OF CONSTRUCTION EQUIPMENT OR AS SPECIFIED IN LANDOWNER AGREEMENTS.
- 4. OTHER EXISTING PHYSICAL FEATURES THAT NEED TO BE PROTECTED WILL BE ENCLOSED IN SAFETY FENCE TO AVOID DISTURBANCE DURING CONSTRUCTION.
- 5. TRENCH SHALL NOT BE EXCAVATED UNTIL PIPELINE IS READY FOR INSTALLATION AND SHALL BE BACKFILLED IN SAME DAY AS PIPE INSTALLATION IN THIS AREA. ALL OPEN DITCHES SHALL BE BARRICADED/FENCED OFF OR PLATED WHEN CONSTRUCTION ACTIVITIES ARE NOT IN PROGRESS.
- 6. IMMEDIATELY AFTER BACKFILLING THE TRENCH, ALL LAWN AND LANDSCAPING WILL BE RESTORED TO FINAL RESTORATION, OR TEMPORARY RESTORATION PENDING WEATHER AND SOIL CONDITIONS. IF SEASONAL OR WEATHER CONDITIONS PREVENT COMPLIANCE WITH THESE TIME FRAMES, TEMPORARY EROSION CONTROLS MUST BE MONITORED AND MAINTAINED UNTIL CONDITIONS ALLOW COMPLETION OF RESTORATION.
- 7. CONTRACTOR SHALL UTILIZE WATER TRUCKS AS NECESSARY TO MINIMIZE FUGITIVE DUST FROM CONSTRUCTION ACTIVITIES NEAR RESIDENCES/BUSINESSES.
- 8. ACCESS TO RESIDENCES BY CAR WILL BE MAINTAINED AT ALL TIMES, OR OTHER ACCOMMODATIONS WILL BE MADE WITH EACH RESPECTIVE LANDOWNER.
- 9. CONTRACTOR SHALL MAINTAIN AGREED UPON ACCESS TO THE IMPACTED AREA DURING CONSTRUCTION.
- 10. CONTRACTOR SHALL LIMIT WORK IN THIS AREA TO DAYLIGHT HOURS, UNLESS OTHERWISE AGREED UPON WITH LANDOWNER/OCCUPANT.
- 11. LANDOWNER/OCCUPANT SHALL BE NOTIFIED OF PROPOSED CONSTRUCTION ACTIVITIES PRIOR TO CONSTRUCTION WORK.

MOUNTAINEER XPRESS PROJECT

MILEPOST

REVISIONS

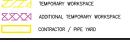







REVISIONS





ISSUED FOR FERC SUPPL FILING

ISSUED FOR FERC SUPPL FILING

REVISIONS

REFERENCE

ITLE PL-MXP-100 MP 160.6 - RESIDENTIAL DETAIL CABELL COUNTY, WV

PROJECT DELIVERY PROJECT ENGINEERING

D6987-RSD-4



1.0 MILEPOST

ADDITIONAL TEMPORARY WORKSPACE

REVISIONS

CONTRACTOR / PIPE YARD

TRACT WV-CB-0109.000

CABELL COUNTY, WEST VIRGINIA



-//- EXISTING COLUMBIA PIPELINE

ISSUED FOR FERC SUPPL FILING ISSUED FOR FERC SUPPL FILING

REVISIONS

→ → FOREIGN PIPELINE

----X----FENCE

ST-CO-001.000) PROPERTY TRACT NUMBER

WPADJC002 WETLAND ID

SAFETY FENCE SPADJC002 WATERBODY ID

WATERBODY

- ACCESS ROAD

ARWIOO1 ACCESS ROAD NUMBER

- SANITARY SEWER PROPERTY LINE

REVISIONS

DESCRIPTION

THIS DRAWING DOCUMENTS MITIGATION MEASURES THAT WILL BE IMPLEMENTED FOR ALL RESIDENCES WITHIN 50 FEET OF THE PROPOSED CONSTRUCTION WORK AREA. CONTRACTOR SHALL COMPLY WITH THE FOLLOWING CONSTRUCTION MITIGATION REQUIREMENTS IN ADDITION TO THOSE LISTED IN THE CONSTRUCTION SPECIFICATIONS.

CONSTRUCTION REQUIREMENTS

- 1. CONTRACTOR SHALL ERECT AND MAINTAIN A SAFETY FENCE BETWEEN THE CONSTRUCTION ZONE AND THE ADJACENT RESIDENCES EXTENDING 100 FEET ON EITHER SIDE OF THE RESIDENCE TO ENSURE THAT EQUIPMENT, MATERIALS AND SPOIL REMAIN WITHIN THE CONSTRUCTION WORK AREA.
- 2. A MINIMUM OF 25 FEET WILL BE MAINTAINED BETWEEN THE RESIDENCE AND CONSTRUCTION WORK AREA FOR A DISTANCE OF 100 FEET ON EITHER SIDE OF THE RESIDENCE. IF THE FACILITY MUST BE WITHIN 25 FEET OF A RESIDENCE, IT MUST BE INSTALLED SUCH THAT THE TRENCH DOES NOT REMAIN OPEN OVERNIGHT.
- 3. MATURE TREES AND LANDSCAPING WILL NOT BE REMOVED FROM WITHIN THE EDGE OF THE CONSTRUCTION WORK AREA UNLESS NECESSARY FOR SAFE OPERATION OF CONSTRUCTION EQUIPMENT OR AS SPECIFIED IN LANDOWNER AGREEMENTS.
- 4. OTHER EXISTING PHYSICAL FEATURES THAT NEED TO BE PROTECTED WILL BE ENCLOSED IN SAFETY FENCE TO AVOID DISTURBANCE DURING CONSTRUCTION.
- 5. TRENCH SHALL NOT BE EXCAVATED UNTIL PIPELINE IS READY FOR INSTALLATION AND SHALL BE BACKFILLED IN SAME DAY AS PIPE INSTALLATION IN THIS AREA. ALL OPEN DITCHES SHALL BE BARRICADED/FENCED OFF OR PLATED WHEN CONSTRUCTION ACTIVITIES ARE NOT IN PROGRESS.
- 6. IMMEDIATELY AFTER BACKFILLING THE TRENCH, ALL LAWN AND LANDSCAPING WILL BE RESTORED TO FINAL RESTORATION, OR TEMPORARY RESTORATION PENDING WEATHER AND SOIL CONDITIONS. IF SEASONAL OR WEATHER CONDITIONS PREVENT COMPLIANCE WITH THESE TIME FRAMES, TEMPORARY EROSION CONTROLS MUST BE MONITORED AND MAINTAINED UNTIL CONDITIONS ALLOW COMPLETION OF RESTORATION.
- 7. CONTRACTOR SHALL UTILIZE WATER TRUCKS AS NECESSARY TO MINIMIZE FUGITIVE DUST FROM CONSTRUCTION ACTIVITIES NEAR RESIDENCES/BUSINESSES.
- 8. ACCESS TO RESIDENCES BY CAR WILL BE MAINTAINED AT ALL TIMES, OR OTHER ACCOMMODATIONS WILL BE MADE WITH EACH RESPECTIVE LANDOWNER.
- 9. CONTRACTOR SHALL MAINTAIN AGREED UPON ACCESS TO THE IMPACTED AREA DURING CONSTRUCTION.
- 10. CONTRACTOR SHALL LIMIT WORK IN THIS AREA TO DAYLIGHT HOURS, UNLESS OTHERWISE AGREED UPON WITH LANDOWNER/OCCUPANT.
- 11. LANDOWNER/OCCUPANT SHALL BE NOTIFIED OF PROPOSED CONSTRUCTION ACTIVITIES PRIOR TO CONSTRUCTION WORK.

PROJECT DELIVERY PROJECT ENGINEERING Columbia MOUNTAINEER XPRESS PROJECT


ITLE PL-MXP-100 MP 160.6 - RESIDENTIAL DETAIL CABELL COUNTY, WV

06987-RSD-4 REFERENCE



TRACT WV-CB-0208.000

CABELL COUNTY, WEST VIRGINIA

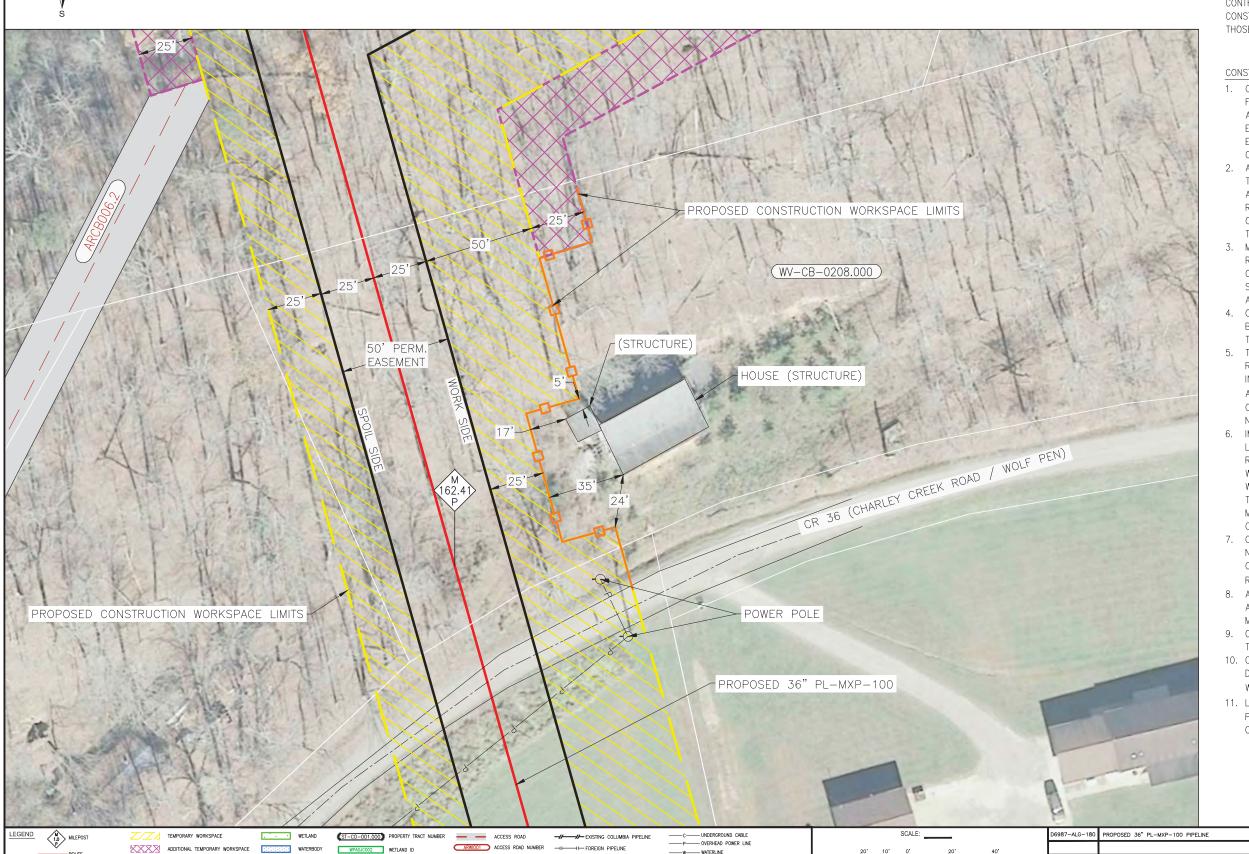

DESCRIPTION

THIS DRAWING DOCUMENTS MITIGATION MEASURES THAT WILL BE IMPLEMENTED FOR ALL RESIDENCES WITHIN 50 FEET OF THE PROPOSED CONSTRUCTION WORK AREA. CONTRACTOR SHALL COMPLY WITH THE FOLLOWING CONSTRUCTION MITIGATION REQUIREMENTS IN ADDITION TO THOSE LISTED IN THE CONSTRUCTION SPECIFICATIONS.

CONSTRUCTION REQUIREMENTS

- 1. CONTRACTOR SHALL ERECT AND MAINTAIN A SAFETY FENCE BETWEEN THE CONSTRUCTION ZONE AND THE ADJACENT RESIDENCES EXTENDING 100 FEET ON EITHER SIDE OF THE RESIDENCE TO ENSURE THAT EQUIPMENT, MATERIALS AND SPOIL REMAIN WITHIN THE CONSTRUCTION WORK AREA.
- 2. A MINIMUM OF 25 FEET WILL BE MAINTAINED BETWEEN THE RESIDENCE AND CONSTRUCTION WORK AREA FOR A DISTANCE OF 100 FEET ON EITHER SIDE OF THE RESIDENCE. IF THE FACILITY MUST BE WITHIN 25 FEET OF A RESIDENCE, IT MUST BE INSTALLED SUCH THAT THE TRENCH DOES NOT REMAIN OPEN OVERNIGHT.
- MATURE TREES AND LANDSCAPING WILL NOT BE REMOVED FROM WITHIN THE EDGE OF THE CONSTRUCTION WORK AREA UNLESS NECESSARY FOR SAFE OPERATION OF CONSTRUCTION EQUIPMENT OR AS SPECIFIED IN LANDOWNER AGREEMENTS.
- 4. OTHER EXISTING PHYSICAL FEATURES THAT NEED TO BE PROTECTED WILL BE ENCLOSED IN SAFETY FENCE TO AVOID DISTURBANCE DURING CONSTRUCTION.
- TRENCH SHALL NOT BE EXCAVATED UNTIL PIPELINE IS READY FOR INSTALLATION AND SHALL BE BACKFILLED IN SAME DAY AS PIPE INSTALLATION IN THIS AREA. ALL OPEN DITCHES SHALL BE BARRICADED/FENCED OFF OR PLATED WHEN CONSTRUCTION ACTIVITIES ARE NOT IN PROGRESS.
- 6. IMMEDIATELY AFTER BACKFILLING THE TRENCH, ALL LAWN AND LANDSCAPING WILL BE RESTORED TO FINAL RESTORATION, OR TEMPORARY RESTORATION PENDING WEATHER AND SOIL CONDITIONS. IF SEASONAL OR WEATHER CONDITIONS PREVENT COMPLIANCE WITH THESE TIME FRAMES, TEMPORARY EROSION CONTROLS MUST BE MONITORED AND MAINTAINED UNTIL CONDITIONS ALLOW COMPLETION OF RESTORATION
- 7. CONTRACTOR SHALL UTILIZE WATER TRUCKS AS NECESSARY TO MINIMIZE FUGITIVE DUST FROM CONSTRUCTION ACTIVITIES NEAR RESIDENCES/BUSINESSES.
- 8. ACCESS TO RESIDENCES BY CAR WILL BE MAINTAINED AT ALL TIMES, OR OTHER ACCOMMODATIONS WILL BE MADE WITH EACH RESPECTIVE LANDOWNER.
- 9. CONTRACTOR SHALL MAINTAIN AGREED UPON ACCESS TO THE IMPACTED AREA DURING CONSTRUCTION.
- 10. CONTRACTOR SHALL LIMIT WORK IN THIS AREA TO DAYLIGHT HOURS, UNLESS OTHERWISE AGREED UPON WITH LANDOWNER/OCCUPANT.
- 11. LANDOWNER/OCCUPANT SHALL BE NOTIFIED OF PROPOSED CONSTRUCTION ACTIVITIES PRIOR TO CONSTRUCTION WORK.

ISSUED FOR FERC SUPPL

PROJECT DELIVERY PROJECT ENGINEERING Columbia Gas Transmissi MOUNTAINEER XPRESS PROJECT

^{ITLE}PL-MXP-100 MP 162.41 - RESIDENTIAL DETAIL CABELL COUNTY, WV

REVISIONS

SAFETY FENCE SPADJC002 WATERBODY ID

CONTRACTOR / PIPE YARD

ISSUED FOR FERC SUPPL FILING REVISIONS

——X—— FENCE

SS — SANITARY SEWER
PROPERTY LINE

ISSUED FOR FERC SUPPL FILING ISSUED FOR FERC FILING

REVISIONS

REFERENCE

06987-RSD-47

TRACT WV-MA-0181.001

MARSHALL COUNTY, WEST VIRGINIA



DESCRIPTION

THIS DRAWING DOCUMENTS MITIGATION MEASURES THAT WILL BE IMPLEMENTED FOR ALL RESIDENCES WITHIN 50 FEET OF THE PROPOSED CONSTRUCTION WORK AREA. CONTRACTOR SHALL COMPLY WITH THE FOLLOWING CONSTRUCTION MITIGATION REQUIREMENTS IN ADDITION TO THOSE LISTED IN THE CONSTRUCTION SPECIFICATIONS.

CONSTRUCTION REQUIREMENTS

- 1. CONTRACTOR SHALL ERECT AND MAINTAIN A SAFETY FENCE BETWEEN THE CONSTRUCTION ZONE AND THE ADJACENT RESIDENCES EXTENDING 100 FEET ON EITHER SIDE OF THE RESIDENCE TO ENSURE THAT EQUIPMENT, MATERIALS AND SPOIL REMAIN WITHIN THE CONSTRUCTION WORK AREA.
- 2. A MINIMUM OF 25 FEET WILL BE MAINTAINED BETWEEN THE RESIDENCE AND CONSTRUCTION WORK AREA FOR A DISTANCE OF 100 FEET ON EITHER SIDE OF THE RESIDENCE. IF THE FACILITY MUST BE WITHIN 25 FEET OF A RESIDENCE, IT MUST BE INSTALLED SUCH THAT THE TRENCH DOES NOT REMAIN OPEN OVERNIGHT.
- 3. MATURE TREES AND LANDSCAPING WILL NOT BE REMOVED FROM WITHIN THE EDGE OF THE CONSTRUCTION WORK AREA UNLESS NECESSARY FOR SAFE OPERATION OF CONSTRUCTION EQUIPMENT OR AS SPECIFIED IN LANDOWNER AGREEMENTS.
- 4. OTHER EXISTING PHYSICAL FEATURES THAT NEED TO BE PROTECTED WILL BE ENCLOSED IN SAFETY FENCE TO AVOID DISTURBANCE DURING CONSTRUCTION.
- 5. TRENCH SHALL NOT BE EXCAVATED UNTIL PIPELINE IS READY FOR INSTALLATION AND SHALL BE BACKFILLED IN SAME DAY AS PIPE INSTALLATION IN THIS AREA. ALL OPEN DITCHES SHALL BE BARRICADED/FENCED OFF OR PLATED WHEN CONSTRUCTION ACTIVITIES ARE NOT IN PROGRESS.
- 6. IMMEDIATELY AFTER BACKFILLING THE TRENCH, ALL LAWN AND LANDSCAPING WILL BE RESTORED TO FINAL RESTORATION, OR TEMPORARY RESTORATION PENDING WEATHER AND SOIL CONDITIONS. IF SEASONAL OR WEATHER CONDITIONS PREVENT COMPLIANCE WITH THESE TIME FRAMES, TEMPORARY EROSION CONTROLS MUST BE MONITORED AND MAINTAINED UNTIL CONDITIONS ALLOW COMPLETION OF RESTORATION.
- 7. CONTRACTOR SHALL UTILIZE WATER TRUCKS AS NECESSARY TO MINIMIZE FUGITIVE DUST FROM CONSTRUCTION ACTIVITIES NEAR RESIDENCES/BUSINESSES.
- 8. ACCESS TO RESIDENCES BY CAR WILL BE MAINTAINED AT ALL TIMES, OR OTHER ACCOMMODATIONS WILL BE MADE WITH EACH RESPECTIVE LANDOWNER.
- 9. CONTRACTOR SHALL MAINTAIN AGREED UPON ACCESS TO THE IMPACTED AREA DURING CONSTRUCTION.
- 10. CONTRACTOR SHALL LIMIT WORK IN THIS AREA TO DAYLIGHT HOURS, UNLESS OTHERWISE AGREED UPON WITH LANDOWNER/OCCUPANT.
- 11. LANDOWNER/OCCUPANT SHALL BE NOTIFIED OF PROPOSED CONSTRUCTION ACTIVITIES PRIOR TO CONSTRUCTION WORK.

ISSUED FOR FERC SUPPL 02/17/2017

`	MILEPOST P **ROUTE TEMPORARY WORKSPACE *** WETLAND **ADDITIONAL TEMPORARY WORKSPACE *** WETLAND **WATERBO		TAND ID ARWI001 ACCESS ROAD NUMBER —I FOREIGN PIPELINE	——Р-		ERGROUND CABLE CHEAD POWER LINE RLINE	SCALE:	40			PROJECT DELIVERY PROJECT ENGINEERING 5151 SAN FELIPE, SUITE 2400, HOUSTON TX 77056	Columb Gas Transm	ia ission
	PERMANENT ROW CONTRACTOR / PIPE YARD SAFETY F	FENCE SPADJC002 WATE	ERBODY ID SS — SANITARY SEWER — X — FENCE PROPERTY LINE	<u> </u>	— COUN	NTY BORDER		-	-		MOUNTAINEER TITLE PL-MXP-100 MP 7.	XPRESS PROJECT	
						7						COUNTY, WV	
\triangle					Pì	ISSUED FOR FERC SUPPL FIL	NG	JHE 02/17/1	7		PROJECT	DRAWING NUMBER SHEET	ISSUE
No.	REVISIONS APPROVE BY	DATE No.	REVISIONS APPROBY	ROVED DAT	E No).	REVISIONS	APPROVED DATE	DWG. NO.	REFERENCE	NOMBER 20432 WORK ORDER NUMBER 46130	D6987-RSD-49 1 OF	1 P1



TRACT WV-WZ-0270.000



ISSUED FOR FERC SUPPL FILING

DATE No.

REVISIONS

REVISIONS

APPROVED DATE No.

DESCRIPTION

THIS DRAWING DOCUMENTS MITIGATION MEASURES THAT WILL BE IMPLEMENTED FOR ALL RESIDENCES WITHIN 50 FEET OF THE PROPOSED CONSTRUCTION WORK AREA. CONTRACTOR SHALL COMPLY WITH THE FOLLOWING CONSTRUCTION MITIGATION REQUIREMENTS IN ADDITION TO

- 1. CONTRACTOR SHALL ERECT AND MAINTAIN A SAFETY FENCE BETWEEN THE CONSTRUCTION ZONE AND THE ADJACENT RESIDENCES EXTENDING 100 FEET ON EITHER SIDE OF THE RESIDENCE TO ENSURE THAT EQUIPMENT, MATERIALS AND SPOIL REMAIN WITHIN THE
- 2. A MINIMUM OF 25 FEET WILL BE MAINTAINED BETWEEN THE RESIDENCE AND CONSTRUCTION WORK AREA FOR A DISTANCE OF 100 FEET ON EITHER SIDE OF THE RESIDENCE. IF THE FACILITY MUST BE WITHIN 25 FEET OF A RESIDENCE, IT MUST BE INSTALLED SUCH THAT THE TRENCH DOES NOT REMAIN OPEN OVERNIGHT.
- REMOVED FROM WITHIN THE EDGE OF THE CONSTRUCTION WORK AREA UNLESS NECESSARY FOR SAFE OPERATION OF CONSTRUCTION EQUIPMENT OR
- 4. OTHER EXISTING PHYSICAL FEATURES THAT NEED TO BE PROTECTED WILL BE ENCLOSED IN SAFETY FENCE TO AVOID DISTURBANCE DURING CONSTRUCTION.
- 5. TRENCH SHALL NOT BE EXCAVATED UNTIL PIPELINE IS READY FOR INSTALLATION AND SHALL BE BACKFILLED IN SAME DAY AS PIPE INSTALLATION IN THIS AREA. ALL OPEN DITCHES SHALL BE BARRICADED/FENCED OFF OR PLATED WHEN CONSTRUCTION ACTIVITIES ARE
- LAWN AND LANDSCAPING WILL BE RESTORED TO FINAL RESTORATION, OR TEMPORARY RESTORATION PENDING WEATHER AND SOIL CONDITIONS. IF SEASONAL OR WEATHER CONDITIONS PREVENT COMPLIANCE WITH THESE TIME FRAMES, TEMPORARY EROSION CONTROLS MUST BE MONITORED AND MAINTAINED UNTIL CONDITIONS ALLOW COMPLETION OF RESTORATION.
- NECESSARY TO MINIMIZE FUGITIVE DUST FROM
- AT ALL TIMES, OR OTHER ACCOMMODATIONS WILL BE MADE WITH EACH RESPECTIVE LANDOWNER.
- TO THE IMPACTED AREA DURING CONSTRUCTION.
- DAYLIGHT HOURS, UNLESS OTHERWISE AGREED UPON
- PROPOSED CONSTRUCTION ACTIVITIES PRIOR TO

REFERENCE

DATE

DWG. NO.

ISSUED FOR FERC SUPPL

^{TLE} PL-MXP-100 MP 21.2 - RESIDENTIAL DETAIL WETZEL COUNTY, WV

D6987-RSD-50




TRACT WV-WZ-0329.000

DESCRIPTION

D6987-RSD-5

REFERENCE


DATE

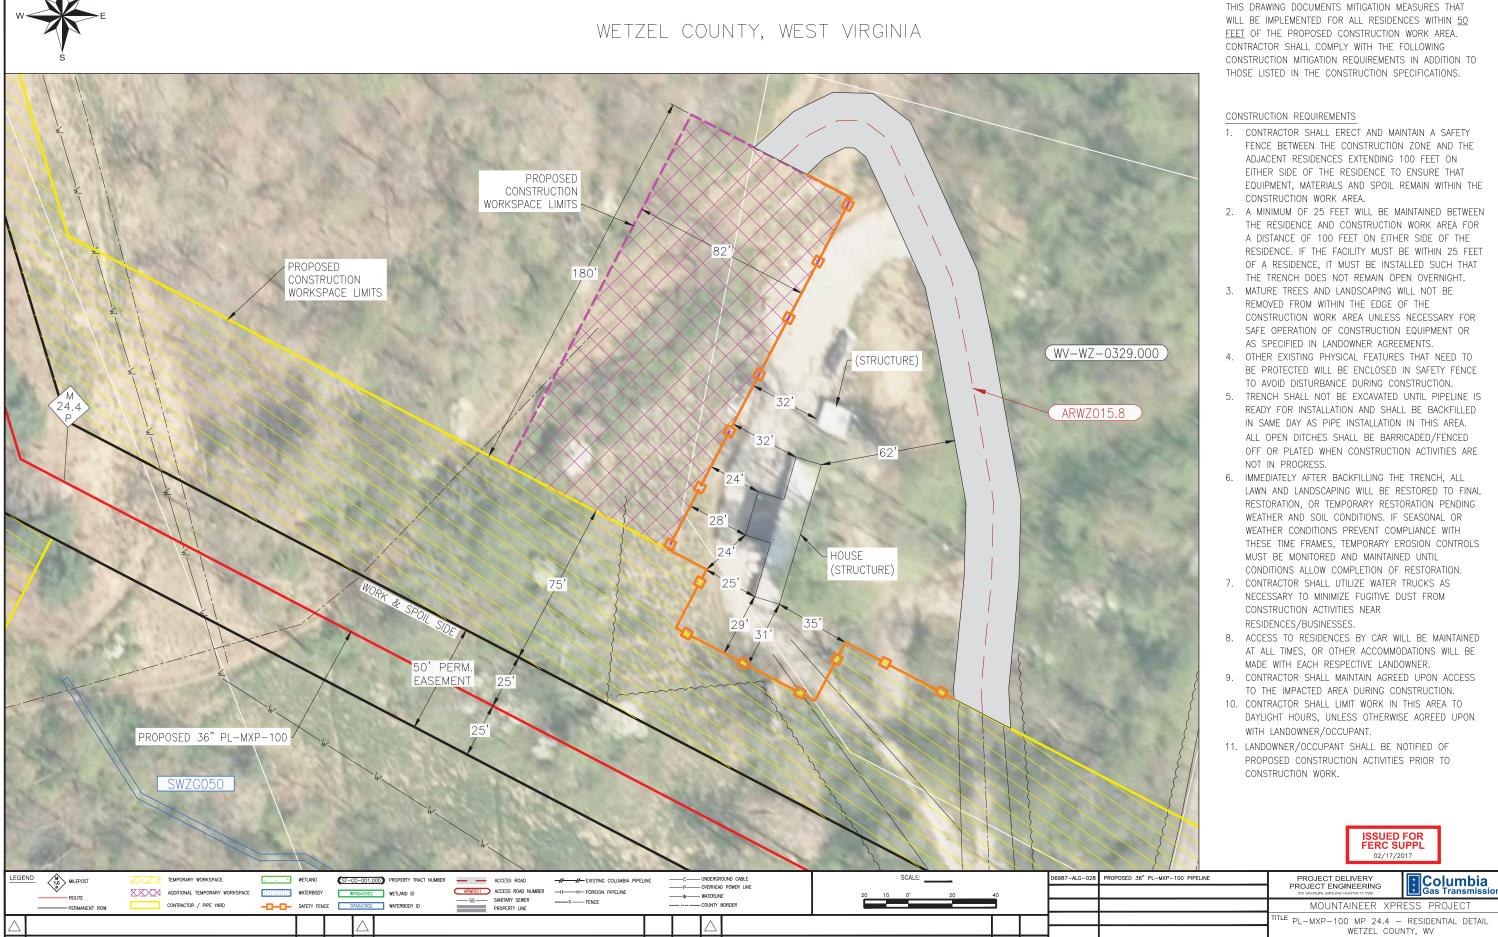

ISSUED FOR FERC SUPPL FILING

REVISIONS

REVISIONS

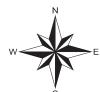

TRACT WV-TY-0049.000

TYLER COUNTY, WEST VIRGINIA



DESCRIPTION

THIS DRAWING DOCUMENTS MITIGATION MEASURES THAT WILL BE IMPLEMENTED FOR ALL RESIDENCES WITHIN 50 FEET OF THE PROPOSED CONSTRUCTION WORK AREA. CONTRACTOR SHALL COMPLY WITH THE FOLLOWING CONSTRUCTION MITIGATION REQUIREMENTS IN ADDITION TO THOSE LISTED IN THE CONSTRUCTION SPECIFICATIONS.

CONSTRUCTION REQUIREMENTS

- 1. CONTRACTOR SHALL ERECT AND MAINTAIN A SAFETY FENCE BETWEEN THE CONSTRUCTION ZONE AND THE ADJACENT RESIDENCES EXTENDING 100 FEET ON EITHER SIDE OF THE RESIDENCE TO ENSURE THAT EQUIPMENT, MATERIALS AND SPOIL REMAIN WITHIN THE CONSTRUCTION WORK AREA.
- 2. A MINIMUM OF 25 FEET WILL BE MAINTAINED BETWEEN THE RESIDENCE AND CONSTRUCTION WORK AREA FOR A DISTANCE OF 100 FEET ON EITHER SIDE OF THE RESIDENCE. IF THE FACILITY MUST BE WITHIN 25 FEET OF A RESIDENCE, IT MUST BE INSTALLED SUCH THAT THE TRENCH DOES NOT REMAIN OPEN OVERNIGHT.
- 3. MATURE TREES AND LANDSCAPING WILL NOT BE REMOVED FROM WITHIN THE EDGE OF THE CONSTRUCTION WORK AREA UNLESS NECESSARY FOR SAFE OPERATION OF CONSTRUCTION EQUIPMENT OR AS SPECIFIED IN LANDOWNER AGREEMENTS.
- 4. OTHER EXISTING PHYSICAL FEATURES THAT NEED TO BE PROTECTED WILL BE ENCLOSED IN SAFETY FENCE TO AVOID DISTURBANCE DURING CONSTRUCTION.
- 5. TRENCH SHALL NOT BE EXCAVATED UNTIL PIPELINE IS READY FOR INSTALLATION AND SHALL BE BACKFILLED IN SAME DAY AS PIPE INSTALLATION IN THIS AREA. ALL OPEN DITCHES SHALL BE BARRICADED/FENCED OFF OR PLATED WHEN CONSTRUCTION ACTIVITIES ARE NOT IN PROGRESS.
- 6. IMMEDIATELY AFTER BACKFILLING THE TRENCH, ALL LAWN AND LANDSCAPING WILL BE RESTORED TO FINAL RESTORATION, OR TEMPORARY RESTORATION PENDING WEATHER AND SOIL CONDITIONS. IF SEASONAL OR WEATHER CONDITIONS PREVENT COMPLIANCE WITH THESE TIME FRAMES, TEMPORARY EROSION CONTROLS MUST BE MONITORED AND MAINTAINED UNTIL CONDITIONS ALLOW COMPLETION OF RESTORATION.
- 7. CONTRACTOR SHALL UTILIZE WATER TRUCKS AS NECESSARY TO MINIMIZE FUGITIVE DUST FROM CONSTRUCTION ACTIVITIES NEAR RESIDENCES/BUSINESSES.
- 8. ACCESS TO RESIDENCES BY CAR WILL BE MAINTAINED AT ALL TIMES, OR OTHER ACCOMMODATIONS WILL BE MADE WITH EACH RESPECTIVE LANDOWNER.
- 9. CONTRACTOR SHALL MAINTAIN AGREED UPON ACCESS TO THE IMPACTED AREA DURING CONSTRUCTION.
- 10. CONTRACTOR SHALL LIMIT WORK IN THIS AREA TO DAYLIGHT HOURS, UNLESS OTHERWISE AGREED UPON WITH LANDOWNER/OCCUPANT.
- 11. LANDOWNER/OCCUPANT SHALL BE NOTIFIED OF PROPOSED CONSTRUCTION ACTIVITIES PRIOR TO CONSTRUCTION WORK.

LEGEND 1.0 MILEPOST

REVISIONS

ADDITIONAL TEMPORARY WORKSPACE CONTRACTOR / PIPE YARD

WATERBODY

ST-CO-001.000) PROPERTY TRACT NUMBER WPADJC002 WETLAND ID SAFETY FENCE SPADJC002 WATERBODY ID

- ACCESS ROAD ARWIOO1 ACCESS ROAD NUMBER - SANITARY SEWER PROPERTY LINE

REVISIONS

-//- EXISTING COLUMBIA PIPELINE ----X----FENCE

_____ UNDERGROUND CABLE

--- COUNTY BORDER

REVISIONS

ISSUED FOR FERC SUPPL FILING

6987-ALG-04

DATE

REFERENCE

ROPOSED 36" PL-MXP-100 PIPELINE

MOUNTAINEER XPRESS PROJECT ^{ITLE} PL-MXP-100 MP 35.1 - RESIDENTIAL DETAIL TYLER COUNTY, WV

PROJECT DELIVERY PROJECT ENGINEERING

)6987-RSD-5



TRACT WV-D0-0009.000

DODDRIDGE COUNTY, WEST VIRGINIA



ISSUED FOR FERC SUPPL FILING

REVISIONS

REVISIONS

DESCRIPTION

THIS DRAWING DOCUMENTS MITIGATION MEASURES THAT WILL BE IMPLEMENTED FOR ALL RESIDENCES WITHIN 50 FEET OF THE PROPOSED CONSTRUCTION WORK AREA. CONTRACTOR SHALL COMPLY WITH THE FOLLOWING CONSTRUCTION MITIGATION REQUIREMENTS IN ADDITION TO

- 1. CONTRACTOR SHALL ERECT AND MAINTAIN A SAFETY FENCE BETWEEN THE CONSTRUCTION ZONE AND THE ADJACENT RESIDENCES EXTENDING 100 FEET ON EITHER SIDE OF THE RESIDENCE TO ENSURE THAT EQUIPMENT, MATERIALS AND SPOIL REMAIN WITHIN THE
- 2. A MINIMUM OF 25 FEET WILL BE MAINTAINED BETWEEN THE RESIDENCE AND CONSTRUCTION WORK AREA FOR A DISTANCE OF 100 FEET ON EITHER SIDE OF THE RESIDENCE. IF THE FACILITY MUST BE WITHIN 25 FEET OF A RESIDENCE, IT MUST BE INSTALLED SUCH THAT THE TRENCH DOES NOT REMAIN OPEN OVERNIGHT.
- 3. MATURE TREES AND LANDSCAPING WILL NOT BE REMOVED FROM WITHIN THE EDGE OF THE CONSTRUCTION WORK AREA UNLESS NECESSARY FOR SAFE OPERATION OF CONSTRUCTION EQUIPMENT OR AS SPECIFIED IN LANDOWNER AGREEMENTS.
- 4. OTHER EXISTING PHYSICAL FEATURES THAT NEED TO BE PROTECTED WILL BE ENCLOSED IN SAFETY FENCE TO AVOID DISTURBANCE DURING CONSTRUCTION.
- 5. TRENCH SHALL NOT BE EXCAVATED UNTIL PIPELINE IS READY FOR INSTALLATION AND SHALL BE BACKFILLED IN SAME DAY AS PIPE INSTALLATION IN THIS AREA. ALL OPEN DITCHES SHALL BE BARRICADED/FENCED OFF OR PLATED WHEN CONSTRUCTION ACTIVITIES ARE
- 6. IMMEDIATELY AFTER BACKFILLING THE TRENCH, ALL LAWN AND LANDSCAPING WILL BE RESTORED TO FINAL RESTORATION, OR TEMPORARY RESTORATION PENDING WEATHER AND SOIL CONDITIONS. IF SEASONAL OR WEATHER CONDITIONS PREVENT COMPLIANCE WITH THESE TIME FRAMES, TEMPORARY EROSION CONTROLS MUST BE MONITORED AND MAINTAINED UNTIL
- NECESSARY TO MINIMIZE FUGITIVE DUST FROM
- AT ALL TIMES, OR OTHER ACCOMMODATIONS WILL BE MADE WITH EACH RESPECTIVE LANDOWNER.
- 9. CONTRACTOR SHALL MAINTAIN AGREED UPON ACCESS TO THE IMPACTED AREA DURING CONSTRUCTION.
- DAYLIGHT HOURS, UNLESS OTHERWISE AGREED UPON
- PROPOSED CONSTRUCTION ACTIVITIES PRIOR TO

REFERENCE

DATE


ISSUED FOR FERC SUPPL

06987-RSD-5



TRACT WV-D0-0158.000

DODDRIDGE COUNTY, WEST VIRGINIA

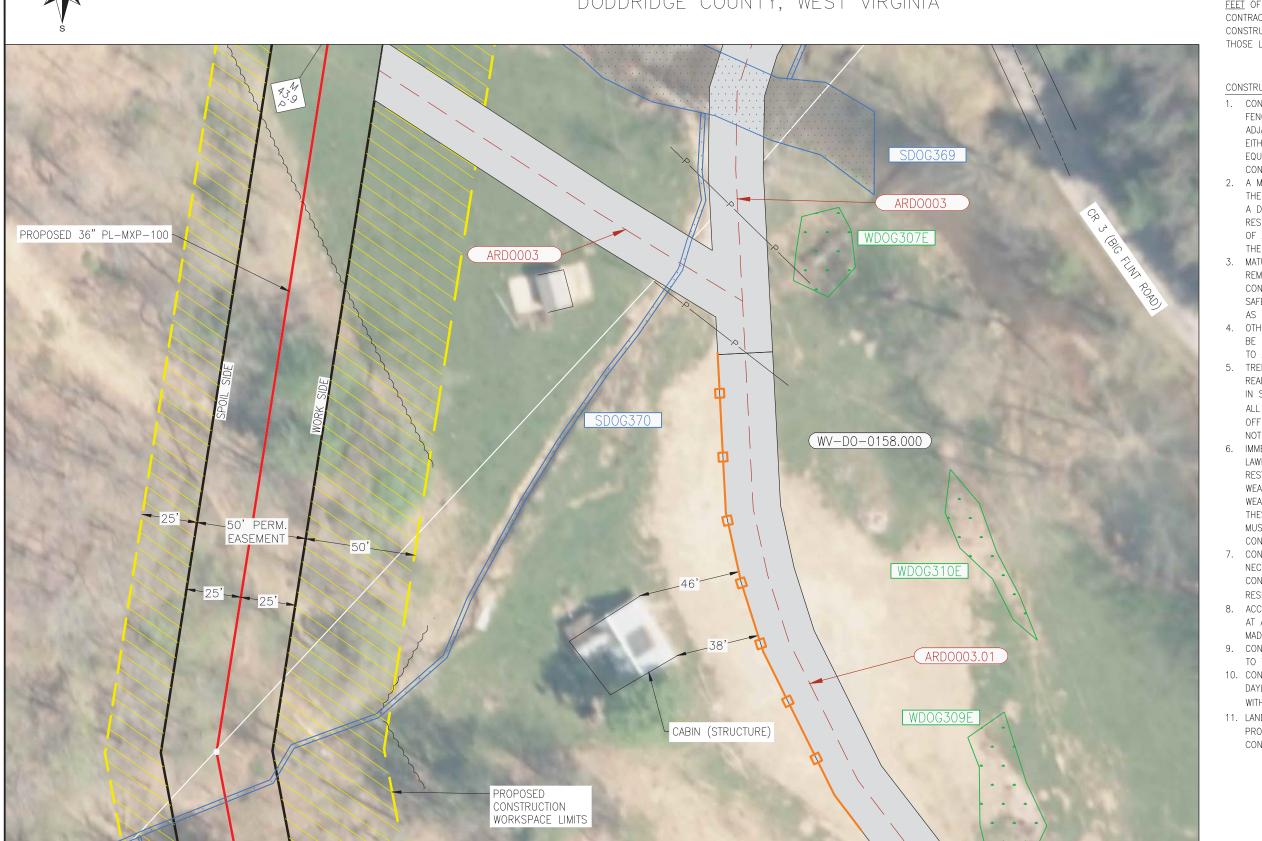

DESCRIPTION

THIS DRAWING DOCUMENTS MITIGATION MEASURES THAT WILL BE IMPLEMENTED FOR ALL RESIDENCES WITHIN 50 FEET OF THE PROPOSED CONSTRUCTION WORK AREA. CONTRACTOR SHALL COMPLY WITH THE FOLLOWING CONSTRUCTION MITIGATION REQUIREMENTS IN ADDITION TO THOSE LISTED IN THE CONSTRUCTION SPECIFICATIONS.

CONSTRUCTION REQUIREMENTS

- 1. CONTRACTOR SHALL ERECT AND MAINTAIN A SAFETY FENCE BETWEEN THE CONSTRUCTION ZONE AND THE ADJACENT RESIDENCES EXTENDING 100 FEET ON EITHER SIDE OF THE RESIDENCE TO ENSURE THAT EQUIPMENT, MATERIALS AND SPOIL REMAIN WITHIN THE CONSTRUCTION WORK AREA.
- 2. A MINIMUM OF 25 FEET WILL BE MAINTAINED BETWEEN THE RESIDENCE AND CONSTRUCTION WORK AREA FOR A DISTANCE OF 100 FEET ON EITHER SIDE OF THE RESIDENCE. IF THE FACILITY MUST BE WITHIN 25 FEET OF A RESIDENCE, IT MUST BE INSTALLED SUCH THAT THE TRENCH DOES NOT REMAIN OPEN OVERNIGHT.
- 3. MATURE TREES AND LANDSCAPING WILL NOT BE REMOVED FROM WITHIN THE EDGE OF THE CONSTRUCTION WORK AREA UNLESS NECESSARY FOR SAFE OPERATION OF CONSTRUCTION EQUIPMENT OR AS SPECIFIED IN LANDOWNER AGREEMENTS.
- 4. OTHER EXISTING PHYSICAL FEATURES THAT NEED TO BE PROTECTED WILL BE ENCLOSED IN SAFETY FENCE TO AVOID DISTURBANCE DURING CONSTRUCTION.
- 5. TRENCH SHALL NOT BE EXCAVATED UNTIL PIPELINE IS READY FOR INSTALLATION AND SHALL BE BACKFILLED IN SAME DAY AS PIPE INSTALLATION IN THIS AREA. ALL OPEN DITCHES SHALL BE BARRICADED/FENCED OFF OR PLATED WHEN CONSTRUCTION ACTIVITIES ARE NOT IN PROGRESS.
- 6. IMMEDIATELY AFTER BACKFILLING THE TRENCH, ALL LAWN AND LANDSCAPING WILL BE RESTORED TO FINAL RESTORATION, OR TEMPORARY RESTORATION PENDING WEATHER AND SOIL CONDITIONS. IF SEASONAL OR WEATHER CONDITIONS PREVENT COMPLIANCE WITH THESE TIME FRAMES, TEMPORARY EROSION CONTROLS MUST BE MONITORED AND MAINTAINED UNTIL CONDITIONS ALLOW COMPLETION OF RESTORATION.
- 7. CONTRACTOR SHALL UTILIZE WATER TRUCKS AS NECESSARY TO MINIMIZE FUGITIVE DUST FROM CONSTRUCTION ACTIVITIES NEAR RESIDENCES/BUSINESSES.
- 8. ACCESS TO RESIDENCES BY CAR WILL BE MAINTAINED AT ALL TIMES, OR OTHER ACCOMMODATIONS WILL BE MADE WITH EACH RESPECTIVE LANDOWNER.
- 9. CONTRACTOR SHALL MAINTAIN AGREED UPON ACCESS TO THE IMPACTED AREA DURING CONSTRUCTION.
- 10. CONTRACTOR SHALL LIMIT WORK IN THIS AREA TO DAYLIGHT HOURS, UNLESS OTHERWISE AGREED UPON WITH LANDOWNER/OCCUPANT.
- 11. LANDOWNER/OCCUPANT SHALL BE NOTIFIED OF PROPOSED CONSTRUCTION ACTIVITIES PRIOR TO CONSTRUCTION WORK.

ISSUED FOR FERC SUPPL 02/17/2017

1.0 MILEPOST P ROUTE	ADDITIONAL TEMPORARY WORKSPACE		*	WETLAND ID	ARWIOO1 ACCESS ROAD NUMBER		_	-P 0' -W W	WERHEAD P	POWER LINE	20'	10' 0'	20' 40	o'	Ľ	DOSOF ALO GOT	THOUGHD 30 TE-MAI - 100 TH ELINE	PROJECT ENGINEERING 5151 SWI FELIPE, SUITE 2000, HOUSTON TX 77006	Gas Transmission
PERMANENT ROW	CONTRACTOR / PIPE YARD	SAFETY FENCE	SPADJC002	WATERBODY ID	SS SANITARY SEWER PROPERTY LINE	——X—— FENCE					=	And the second s		1				MOUNTAINEER XF	PRESS PROJECT
\triangle			\triangle						\triangle									TITLE PL-MXP-100 MP 43.9 DODDRIDGE (
\triangle									A	ISSUED FOR FERC SUPPL FILE	ING			JHE C	02/17/17			DRAWN BY: SAJ DATE: 12/21/16 DF	RAWING NUMBER SHEET ISSUE
No.	REVISIONS	APPROVED BY	DATE No.		REVISIONS	AF	PPROVED BY	DATE	No.		REVISION	IS	A	APPROVED BY	DATE	DWG. NO.	REFERENCE	MANUSER 20432 D6 WORK ORDER 46130	987-RSD-54 1 OF 1 P1
•																			



TRACT WV-D0-0157.000

DODDRIDGE COUNTY, WEST VIRGINIA



ISSUED FOR FERC SUPPL FILING

REVISIONS

REVISIONS

DESCRIPTION

THIS DRAWING DOCUMENTS MITIGATION MEASURES THAT WILL BE IMPLEMENTED FOR ALL RESIDENCES WITHIN 50 FEET OF THE PROPOSED CONSTRUCTION WORK AREA. CONTRACTOR SHALL COMPLY WITH THE FOLLOWING CONSTRUCTION MITIGATION REQUIREMENTS IN ADDITION TO

- 1. CONTRACTOR SHALL ERECT AND MAINTAIN A SAFETY FENCE BETWEEN THE CONSTRUCTION ZONE AND THE ADJACENT RESIDENCES EXTENDING 100 FEET ON EITHER SIDE OF THE RESIDENCE TO ENSURE THAT EQUIPMENT, MATERIALS AND SPOIL REMAIN WITHIN THE
- 2. A MINIMUM OF 25 FEET WILL BE MAINTAINED BETWEEN THE RESIDENCE AND CONSTRUCTION WORK AREA FOR A DISTANCE OF 100 FEET ON EITHER SIDE OF THE RESIDENCE. IF THE FACILITY MUST BE WITHIN 25 FEET OF A RESIDENCE, IT MUST BE INSTALLED SUCH THAT THE TRENCH DOES NOT REMAIN OPEN OVERNIGHT.
- REMOVED FROM WITHIN THE EDGE OF THE CONSTRUCTION WORK AREA UNLESS NECESSARY FOR SAFE OPERATION OF CONSTRUCTION EQUIPMENT OR AS SPECIFIED IN LANDOWNER AGREEMENTS.
- 4. OTHER EXISTING PHYSICAL FEATURES THAT NEED TO BE PROTECTED WILL BE ENCLOSED IN SAFETY FENCE TO AVOID DISTURBANCE DURING CONSTRUCTION.
- 5. TRENCH SHALL NOT BE EXCAVATED UNTIL PIPELINE IS READY FOR INSTALLATION AND SHALL BE BACKFILLED IN SAME DAY AS PIPE INSTALLATION IN THIS AREA. ALL OPEN DITCHES SHALL BE BARRICADED/FENCED OFF OR PLATED WHEN CONSTRUCTION ACTIVITIES ARE
- 6. IMMEDIATELY AFTER BACKFILLING THE TRENCH, ALL LAWN AND LANDSCAPING WILL BE RESTORED TO FINAL RESTORATION, OR TEMPORARY RESTORATION PENDING WEATHER AND SOIL CONDITIONS. IF SEASONAL OR WEATHER CONDITIONS PREVENT COMPLIANCE WITH THESE TIME FRAMES, TEMPORARY EROSION CONTROLS MUST BE MONITORED AND MAINTAINED UNTIL
- 7. CONTRACTOR SHALL UTILIZE WATER TRUCKS AS NECESSARY TO MINIMIZE FUGITIVE DUST FROM
- AT ALL TIMES, OR OTHER ACCOMMODATIONS WILL BE MADE WITH EACH RESPECTIVE LANDOWNER.
- 9. CONTRACTOR SHALL MAINTAIN AGREED UPON ACCESS TO THE IMPACTED AREA DURING CONSTRUCTION.
- DAYLIGHT HOURS, UNLESS OTHERWISE AGREED UPON
- PROPOSED CONSTRUCTION ACTIVITIES PRIOR TO

REFERENCE

DATE




^{ITLE} PL-MXP-100 MP 43.8 - RESIDENTIAL DETAIL DODDRIDGE COUNTY, WV

06987-RSD-5



TRACT WV-D0-0196.000

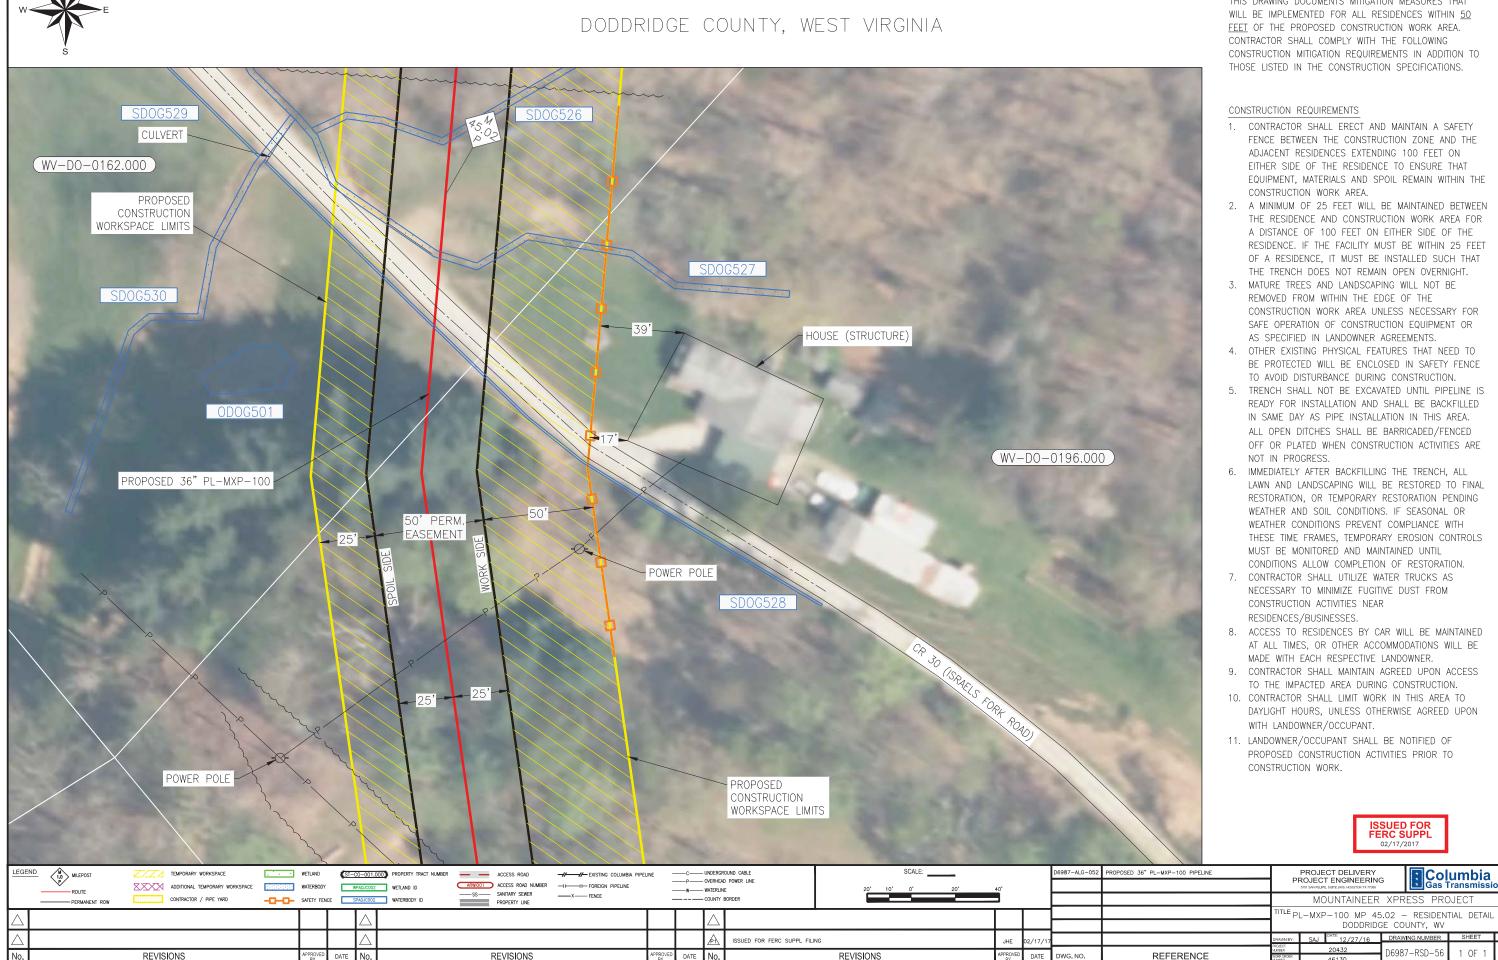

REVISIONS

DATE

REVISIONS

DESCRIPTION

THIS DRAWING DOCUMENTS MITIGATION MEASURES THAT



TRACT WV-RI-0349.000

RITCHIE COUNTY, WEST VIRGINIA

ISSUED FOR FERC SUPPL FILING

REVISIONS



- SANITARY SEWER PROPERTY LINE

REVISIONS

CONTRACTOR / PIPE YARD

REVISIONS

SAFETY FENCE SPADJC002 WATERBODY ID

----X----FENCE

DESCRIPTION

THIS DRAWING DOCUMENTS MITIGATION MEASURES THAT WILL BE IMPLEMENTED FOR ALL RESIDENCES WITHIN 50 FEET OF THE PROPOSED CONSTRUCTION WORK AREA. CONTRACTOR SHALL COMPLY WITH THE FOLLOWING CONSTRUCTION MITIGATION REQUIREMENTS IN ADDITION TO THOSE LISTED IN THE CONSTRUCTION SPECIFICATIONS.

CONSTRUCTION REQUIREMENTS

- 1. CONTRACTOR SHALL ERECT AND MAINTAIN A SAFETY FENCE BETWEEN THE CONSTRUCTION ZONE AND THE ADJACENT RESIDENCES EXTENDING 100 FEET ON EITHER SIDE OF THE RESIDENCE TO ENSURE THAT EQUIPMENT, MATERIALS AND SPOIL REMAIN WITHIN THE CONSTRUCTION WORK AREA.
- 2. A MINIMUM OF 25 FEET WILL BE MAINTAINED BETWEEN THE RESIDENCE AND CONSTRUCTION WORK AREA FOR A DISTANCE OF 100 FEET ON EITHER SIDE OF THE RESIDENCE. IF THE FACILITY MUST BE WITHIN 25 FEET OF A RESIDENCE, IT MUST BE INSTALLED SUCH THAT THE TRENCH DOES NOT REMAIN OPEN OVERNIGHT.
- 3. MATURE TREES AND LANDSCAPING WILL NOT BE REMOVED FROM WITHIN THE EDGE OF THE CONSTRUCTION WORK AREA UNLESS NECESSARY FOR SAFE OPERATION OF CONSTRUCTION EQUIPMENT OR AS SPECIFIED IN LANDOWNER AGREEMENTS.
- 4. OTHER EXISTING PHYSICAL FEATURES THAT NEED TO BE PROTECTED WILL BE ENCLOSED IN SAFETY FENCE TO AVOID DISTURBANCE DURING CONSTRUCTION.
- 5. TRENCH SHALL NOT BE EXCAVATED UNTIL PIPELINE IS READY FOR INSTALLATION AND SHALL BE BACKFILLED IN SAME DAY AS PIPE INSTALLATION IN THIS AREA. ALL OPEN DITCHES SHALL BE BARRICADED/FENCED OFF OR PLATED WHEN CONSTRUCTION ACTIVITIES ARE NOT IN PROGRESS.
- 6. IMMEDIATELY AFTER BACKFILLING THE TRENCH, ALL LAWN AND LANDSCAPING WILL BE RESTORED TO FINAL RESTORATION, OR TEMPORARY RESTORATION PENDING WEATHER AND SOIL CONDITIONS. IF SEASONAL OR WEATHER CONDITIONS PREVENT COMPLIANCE WITH THESE TIME FRAMES, TEMPORARY EROSION CONTROLS MUST BE MONITORED AND MAINTAINED UNTIL CONDITIONS ALLOW COMPLETION OF RESTORATION.
- 7. CONTRACTOR SHALL UTILIZE WATER TRUCKS AS NECESSARY TO MINIMIZE FUGITIVE DUST FROM CONSTRUCTION ACTIVITIES NEAR
- 8. ACCESS TO RESIDENCES BY CAR WILL BE MAINTAINED AT ALL TIMES, OR OTHER ACCOMMODATIONS WILL BE MADE WITH EACH RESPECTIVE LANDOWNER.
- 9. CONTRACTOR SHALL MAINTAIN AGREED UPON ACCESS TO THE IMPACTED AREA DURING CONSTRUCTION.
- 10. CONTRACTOR SHALL LIMIT WORK IN THIS AREA TO DAYLIGHT HOURS, UNLESS OTHERWISE AGREED UPON WITH LANDOWNER/OCCUPANT.
- 11. LANDOWNER/OCCUPANT SHALL BE NOTIFIED OF PROPOSED CONSTRUCTION ACTIVITIES PRIOR TO CONSTRUCTION WORK.

REFERENCE

ISSUED FOR FERC SUPPL

MOUNTAINEER XPRESS PROJECT ^{ITLE} PL-MXP-100 MP 77.7 - RESIDENTIAL DETAIL RITCHIE COUNTY, WV

06987-RSD-5

Co<u>l</u>umbia



MILEPOST

ADDITIONAL TEMPORARY WORKSPACE

REVISIONS

CONTRACTOR / PIPE YARD

TRACT WV-RI-0415.000

RITCHIE COUNTY, WEST VIRGINIA



- ACCESS ROAD

ARWIOD1 ACCESS ROAD NUMBER

- SANITARY SEWER PROPERTY LINE

REVISIONS

-//- EXISTING COLUMBIA PIPELINE

---- COUNTY BORDER

ISSUED FOR FERC SUPPL FILING

REVISIONS

-I---I-- FOREIGN PIPELINE

----X----FENCE

ST-CO-001.000) PROPERTY TRACT NUMBER

WPADJC002 WETLAND ID

SAFETY FENCE SPADJC002 WATERBODY ID

WATERBODY

DESCRIPTION

THIS DRAWING DOCUMENTS MITIGATION MEASURES THAT WILL BE IMPLEMENTED FOR ALL RESIDENCES WITHIN 50 FEET OF THE PROPOSED CONSTRUCTION WORK AREA. CONTRACTOR SHALL COMPLY WITH THE FOLLOWING CONSTRUCTION MITIGATION REQUIREMENTS IN ADDITION TO THOSE LISTED IN THE CONSTRUCTION SPECIFICATIONS.

CONSTRUCTION REQUIREMENTS

- 1. CONTRACTOR SHALL ERECT AND MAINTAIN A SAFETY FENCE BETWEEN THE CONSTRUCTION ZONE AND THE ADJACENT RESIDENCES EXTENDING 100 FEET ON EITHER SIDE OF THE RESIDENCE TO ENSURE THAT EQUIPMENT, MATERIALS AND SPOIL REMAIN WITHIN THE CONSTRUCTION WORK AREA.
- 2. A MINIMUM OF 25 FEET WILL BE MAINTAINED BETWEEN THE RESIDENCE AND CONSTRUCTION WORK AREA FOR A DISTANCE OF 100 FEET ON EITHER SIDE OF THE RESIDENCE. IF THE FACILITY MUST BE WITHIN 25 FEET OF A RESIDENCE, IT MUST BE INSTALLED SUCH THAT THE TRENCH DOES NOT REMAIN OPEN OVERNIGHT.
- 3. MATURE TREES AND LANDSCAPING WILL NOT BE REMOVED FROM WITHIN THE EDGE OF THE CONSTRUCTION WORK AREA UNLESS NECESSARY FOR SAFE OPERATION OF CONSTRUCTION EQUIPMENT OR AS SPECIFIED IN LANDOWNER AGREEMENTS.
- 4. OTHER EXISTING PHYSICAL FEATURES THAT NEED TO BE PROTECTED WILL BE ENCLOSED IN SAFETY FENCE TO AVOID DISTURBANCE DURING CONSTRUCTION.
- 5. TRENCH SHALL NOT BE EXCAVATED UNTIL PIPELINE IS READY FOR INSTALLATION AND SHALL BE BACKFILLED IN SAME DAY AS PIPE INSTALLATION IN THIS AREA. ALL OPEN DITCHES SHALL BE BARRICADED/FENCED OFF OR PLATED WHEN CONSTRUCTION ACTIVITIES ARE NOT IN PROGRESS.
- 6. IMMEDIATELY AFTER BACKFILLING THE TRENCH, ALL LAWN AND LANDSCAPING WILL BE RESTORED TO FINAL RESTORATION, OR TEMPORARY RESTORATION PENDING WEATHER AND SOIL CONDITIONS. IF SEASONAL OR WEATHER CONDITIONS PREVENT COMPLIANCE WITH THESE TIME FRAMES, TEMPORARY EROSION CONTROLS MUST BE MONITORED AND MAINTAINED UNTIL CONDITIONS ALLOW COMPLETION OF RESTORATION.
- 7. CONTRACTOR SHALL UTILIZE WATER TRUCKS AS NECESSARY TO MINIMIZE FUGITIVE DUST FROM CONSTRUCTION ACTIVITIES NEAR RESIDENCES/BUSINESSES.
- 8. ACCESS TO RESIDENCES BY CAR WILL BE MAINTAINED AT ALL TIMES, OR OTHER ACCOMMODATIONS WILL BE MADE WITH EACH RESPECTIVE LANDOWNER.
- 9. CONTRACTOR SHALL MAINTAIN AGREED UPON ACCESS TO THE IMPACTED AREA DURING CONSTRUCTION.
- 10. CONTRACTOR SHALL LIMIT WORK IN THIS AREA TO DAYLIGHT HOURS, UNLESS OTHERWISE AGREED UPON WITH LANDOWNER/OCCUPANT.
- 11. LANDOWNER/OCCUPANT SHALL BE NOTIFIED OF PROPOSED CONSTRUCTION ACTIVITIES PRIOR TO CONSTRUCTION WORK.

PROJECT DELIVERY PROJECT ENGINEERING


06987-ALG-086 PROPOSED 36" PL-MXP-100 PIPELINE

REFERENCE

ISSUED FOR FERC SUPPL

MOUNTAINEER XPRESS PROJECT ^{ITLE} PL-MXP-100 MP 77.7 - RESIDENTIAL DETAIL RITCHIE COUNTY, WV

06987-RSD-5

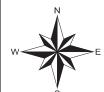

TRACT WV-WI-0142.000

WIRT COUNTY, WEST VIRGINIA



--- COUNTY BORDER

ISSUED FOR FERC SUPPL FILING

REVISIONS

- SANITARY SEWER PROPERTY LINE

REVISIONS

CONTRACTOR / PIPE YARD

REVISIONS

SAFETY FENCE SPADJC002 WATERBODY ID

DESCRIPTION

THIS DRAWING DOCUMENTS MITIGATION MEASURES THAT WILL BE IMPLEMENTED FOR ALL RESIDENCES WITHIN 50 FEET OF THE PROPOSED CONSTRUCTION WORK AREA. CONTRACTOR SHALL COMPLY WITH THE FOLLOWING CONSTRUCTION MITIGATION REQUIREMENTS IN ADDITION TO

- 1. CONTRACTOR SHALL ERECT AND MAINTAIN A SAFETY FENCE BETWEEN THE CONSTRUCTION ZONE AND THE ADJACENT RESIDENCES EXTENDING 100 FEET ON EITHER SIDE OF THE RESIDENCE TO ENSURE THAT EQUIPMENT, MATERIALS AND SPOIL REMAIN WITHIN THE
- 2. A MINIMUM OF 25 FEET WILL BE MAINTAINED BETWEEN THE RESIDENCE AND CONSTRUCTION WORK AREA FOR A DISTANCE OF 100 FEET ON EITHER SIDE OF THE RESIDENCE. IF THE FACILITY MUST BE WITHIN 25 FEET OF A RESIDENCE, IT MUST BE INSTALLED SUCH THAT THE TRENCH DOES NOT REMAIN OPEN OVERNIGHT.
- 3. MATURE TREES AND LANDSCAPING WILL NOT BE REMOVED FROM WITHIN THE EDGE OF THE CONSTRUCTION WORK AREA UNLESS NECESSARY FOR SAFE OPERATION OF CONSTRUCTION EQUIPMENT OR AS SPECIFIED IN LANDOWNER AGREEMENTS.
- 4. OTHER EXISTING PHYSICAL FEATURES THAT NEED TO BE PROTECTED WILL BE ENCLOSED IN SAFETY FENCE TO AVOID DISTURBANCE DURING CONSTRUCTION.
- 5. TRENCH SHALL NOT BE EXCAVATED UNTIL PIPELINE IS READY FOR INSTALLATION AND SHALL BE BACKFILLED IN SAME DAY AS PIPE INSTALLATION IN THIS AREA. ALL OPEN DITCHES SHALL BE BARRICADED/FENCED OFF OR PLATED WHEN CONSTRUCTION ACTIVITIES ARE
- 6. IMMEDIATELY AFTER BACKFILLING THE TRENCH, ALL LAWN AND LANDSCAPING WILL BE RESTORED TO FINAL RESTORATION, OR TEMPORARY RESTORATION PENDING WEATHER AND SOIL CONDITIONS. IF SEASONAL OR WEATHER CONDITIONS PREVENT COMPLIANCE WITH THESE TIME FRAMES, TEMPORARY EROSION CONTROLS MUST BE MONITORED AND MAINTAINED UNTIL CONDITIONS ALLOW COMPLETION OF RESTORATION.
- 7. CONTRACTOR SHALL UTILIZE WATER TRUCKS AS NECESSARY TO MINIMIZE FUGITIVE DUST FROM CONSTRUCTION ACTIVITIES NEAR
- 8. ACCESS TO RESIDENCES BY CAR WILL BE MAINTAINED AT ALL TIMES, OR OTHER ACCOMMODATIONS WILL BE MADE WITH EACH RESPECTIVE LANDOWNER.
- 9. CONTRACTOR SHALL MAINTAIN AGREED UPON ACCESS TO THE IMPACTED AREA DURING CONSTRUCTION.
- 10. CONTRACTOR SHALL LIMIT WORK IN THIS AREA TO DAYLIGHT HOURS, UNLESS OTHERWISE AGREED UPON
- PROPOSED CONSTRUCTION ACTIVITIES PRIOR TO

REFERENCE

DATE

ISSUED FOR FERC SUPPL

MOUNTAINEER XPRESS PROJECT


06987-RSD-5

ITLE PL-MXP-100 MP 91.72 - RESIDENTIAL DETAIL WIRT COUNTY, WV



TRACT WV-R0-0195.000

ROANE COUNTY, WEST VIRGINIA

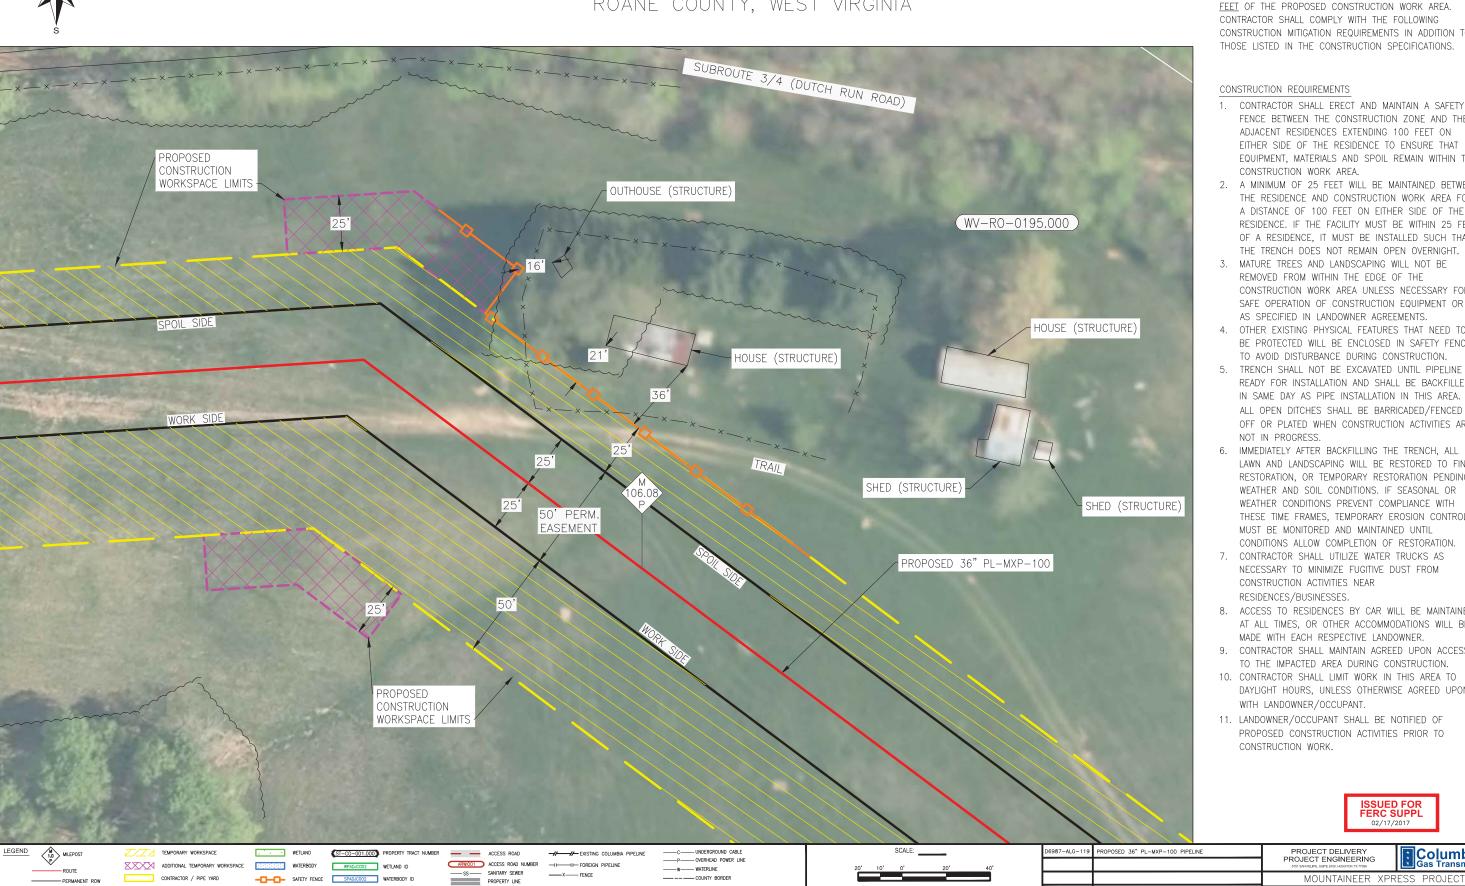

ISSUED FOR FERC SUPPL FILING

REVISIONS

REVISIONS

DESCRIPTION

THIS DRAWING DOCUMENTS MITIGATION MEASURES THAT WILL BE IMPLEMENTED FOR ALL RESIDENCES WITHIN 50 FEET OF THE PROPOSED CONSTRUCTION WORK AREA. CONTRACTOR SHALL COMPLY WITH THE FOLLOWING CONSTRUCTION MITIGATION REQUIREMENTS IN ADDITION TO THOSE LISTED IN THE CONSTRUCTION SPECIFICATIONS.

- 1. CONTRACTOR SHALL ERECT AND MAINTAIN A SAFETY FENCE BETWEEN THE CONSTRUCTION ZONE AND THE ADJACENT RESIDENCES EXTENDING 100 FEET ON EITHER SIDE OF THE RESIDENCE TO ENSURE THAT EQUIPMENT, MATERIALS AND SPOIL REMAIN WITHIN THE
- 2. A MINIMUM OF 25 FEET WILL BE MAINTAINED BETWEEN THE RESIDENCE AND CONSTRUCTION WORK AREA FOR A DISTANCE OF 100 FEET ON EITHER SIDE OF THE RESIDENCE. IF THE FACILITY MUST BE WITHIN 25 FEET OF A RESIDENCE, IT MUST BE INSTALLED SUCH THAT THE TRENCH DOES NOT REMAIN OPEN OVERNIGHT.
- 3. MATURE TREES AND LANDSCAPING WILL NOT BE REMOVED FROM WITHIN THE EDGE OF THE CONSTRUCTION WORK AREA UNLESS NECESSARY FOR SAFE OPERATION OF CONSTRUCTION EQUIPMENT OR AS SPECIFIED IN LANDOWNER AGREEMENTS.
- 4. OTHER EXISTING PHYSICAL FEATURES THAT NEED TO BE PROTECTED WILL BE ENCLOSED IN SAFETY FENCE TO AVOID DISTURBANCE DURING CONSTRUCTION.
- 5. TRENCH SHALL NOT BE EXCAVATED UNTIL PIPELINE IS READY FOR INSTALLATION AND SHALL BE BACKFILLED IN SAME DAY AS PIPE INSTALLATION IN THIS AREA. ALL OPEN DITCHES SHALL BE BARRICADED/FENCED OFF OR PLATED WHEN CONSTRUCTION ACTIVITIES ARE
- 6. IMMEDIATELY AFTER BACKFILLING THE TRENCH, ALL LAWN AND LANDSCAPING WILL BE RESTORED TO FINAL RESTORATION, OR TEMPORARY RESTORATION PENDING WEATHER AND SOIL CONDITIONS. IF SEASONAL OR WEATHER CONDITIONS PREVENT COMPLIANCE WITH THESE TIME FRAMES, TEMPORARY EROSION CONTROLS MUST BE MONITORED AND MAINTAINED UNTIL CONDITIONS ALLOW COMPLETION OF RESTORATION.
- NECESSARY TO MINIMIZE FUGITIVE DUST FROM CONSTRUCTION ACTIVITIES NEAR
- 8. ACCESS TO RESIDENCES BY CAR WILL BE MAINTAINED AT ALL TIMES, OR OTHER ACCOMMODATIONS WILL BE MADE WITH EACH RESPECTIVE LANDOWNER.
- 9. CONTRACTOR SHALL MAINTAIN AGREED UPON ACCESS TO THE IMPACTED AREA DURING CONSTRUCTION.
- 10. CONTRACTOR SHALL LIMIT WORK IN THIS AREA TO DAYLIGHT HOURS, UNLESS OTHERWISE AGREED UPON
- PROPOSED CONSTRUCTION ACTIVITIES PRIOR TO

REFERENCE

DATE

ISSUED FOR FERC SUPPL

T^{le}PL-MXP-100 MP 106.08 - RESIDENTIAL DETAIL ROANE COUNTY, WV

06987-RSD-6



TRACT WV-R0-0200.000

ROANE COUNTY, WEST VIRGINIA



ISSUED FOR FERC SUPPL FILING

REVISIONS

REVISIONS

DESCRIPTION

THIS DRAWING DOCUMENTS MITIGATION MEASURES THAT WILL BE IMPLEMENTED FOR ALL RESIDENCES WITHIN 50 FEET OF THE PROPOSED CONSTRUCTION WORK AREA. CONTRACTOR SHALL COMPLY WITH THE FOLLOWING CONSTRUCTION MITIGATION REQUIREMENTS IN ADDITION TO

- 1. CONTRACTOR SHALL ERECT AND MAINTAIN A SAFETY FENCE BETWEEN THE CONSTRUCTION ZONE AND THE ADJACENT RESIDENCES EXTENDING 100 FEET ON EITHER SIDE OF THE RESIDENCE TO ENSURE THAT EQUIPMENT, MATERIALS AND SPOIL REMAIN WITHIN THE
- 2. A MINIMUM OF 25 FEET WILL BE MAINTAINED BETWEEN THE RESIDENCE AND CONSTRUCTION WORK AREA FOR A DISTANCE OF 100 FEET ON EITHER SIDE OF THE RESIDENCE. IF THE FACILITY MUST BE WITHIN 25 FEET OF A RESIDENCE, IT MUST BE INSTALLED SUCH THAT THE TRENCH DOES NOT REMAIN OPEN OVERNIGHT.
- REMOVED FROM WITHIN THE EDGE OF THE CONSTRUCTION WORK AREA UNLESS NECESSARY FOR SAFE OPERATION OF CONSTRUCTION EQUIPMENT OR AS SPECIFIED IN LANDOWNER AGREEMENTS.
- 4. OTHER EXISTING PHYSICAL FEATURES THAT NEED TO BE PROTECTED WILL BE ENCLOSED IN SAFETY FENCE TO AVOID DISTURBANCE DURING CONSTRUCTION.
- 5. TRENCH SHALL NOT BE EXCAVATED UNTIL PIPELINE IS READY FOR INSTALLATION AND SHALL BE BACKFILLED IN SAME DAY AS PIPE INSTALLATION IN THIS AREA. ALL OPEN DITCHES SHALL BE BARRICADED/FENCED OFF OR PLATED WHEN CONSTRUCTION ACTIVITIES ARE
- 6. IMMEDIATELY AFTER BACKFILLING THE TRENCH, ALL LAWN AND LANDSCAPING WILL BE RESTORED TO FINAL RESTORATION, OR TEMPORARY RESTORATION PENDING WEATHER AND SOIL CONDITIONS. IF SEASONAL OR WEATHER CONDITIONS PREVENT COMPLIANCE WITH THESE TIME FRAMES, TEMPORARY EROSION CONTROLS MUST BE MONITORED AND MAINTAINED UNTIL
- 7. CONTRACTOR SHALL UTILIZE WATER TRUCKS AS NECESSARY TO MINIMIZE FUGITIVE DUST FROM
- 8. ACCESS TO RESIDENCES BY CAR WILL BE MAINTAINED AT ALL TIMES, OR OTHER ACCOMMODATIONS WILL BE MADE WITH EACH RESPECTIVE LANDOWNER.
- 9. CONTRACTOR SHALL MAINTAIN AGREED UPON ACCESS TO THE IMPACTED AREA DURING CONSTRUCTION.
- DAYLIGHT HOURS, UNLESS OTHERWISE AGREED UPON
- PROPOSED CONSTRUCTION ACTIVITIES PRIOR TO

REFERENCE


DATE



TLE PL-MXP-100 MP 107.4 - RESIDENTIAL DETAIL ROANE COUNTY, WV

D6987-RSD-6

Co<u>l</u>umbia

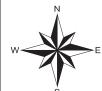

ADDITIONAL TEMPORARY WORKSPACE

WATERBODY

WPADJC002 WETLAND ID

TRACT WV-JA-0059.000




DESCRIPTION

THIS DRAWING DOCUMENTS MITIGATION MEASURES THAT WILL BE IMPLEMENTED FOR ALL RESIDENCES WITHIN 50 FEET OF THE PROPOSED CONSTRUCTION WORK AREA. CONTRACTOR SHALL COMPLY WITH THE FOLLOWING CONSTRUCTION MITIGATION REQUIREMENTS IN ADDITION TO

- 1. CONTRACTOR SHALL ERECT AND MAINTAIN A SAFETY FENCE BETWEEN THE CONSTRUCTION ZONE AND THE ADJACENT RESIDENCES EXTENDING 100 FEET ON EITHER SIDE OF THE RESIDENCE TO ENSURE THAT EQUIPMENT, MATERIALS AND SPOIL REMAIN WITHIN THE
- 2. A MINIMUM OF 25 FEET WILL BE MAINTAINED BETWEEN THE RESIDENCE AND CONSTRUCTION WORK AREA FOR A DISTANCE OF 100 FEET ON EITHER SIDE OF THE RESIDENCE. IF THE FACILITY MUST BE WITHIN 25 FEET OF A RESIDENCE, IT MUST BE INSTALLED SUCH THAT THE TRENCH DOES NOT REMAIN OPEN OVERNIGHT.
- 3. MATURE TREES AND LANDSCAPING WILL NOT BE REMOVED FROM WITHIN THE EDGE OF THE CONSTRUCTION WORK AREA UNLESS NECESSARY FOR SAFE OPERATION OF CONSTRUCTION EQUIPMENT OR AS SPECIFIED IN LANDOWNER AGREEMENTS.
- 4. OTHER EXISTING PHYSICAL FEATURES THAT NEED TO BE PROTECTED WILL BE ENCLOSED IN SAFETY FENCE TO AVOID DISTURBANCE DURING CONSTRUCTION.
- 5. TRENCH SHALL NOT BE EXCAVATED UNTIL PIPELINE IS READY FOR INSTALLATION AND SHALL BE BACKFILLED IN SAME DAY AS PIPE INSTALLATION IN THIS AREA. ALL OPEN DITCHES SHALL BE BARRICADED/FENCED OFF OR PLATED WHEN CONSTRUCTION ACTIVITIES ARE
- 6. IMMEDIATELY AFTER BACKFILLING THE TRENCH, ALL LAWN AND LANDSCAPING WILL BE RESTORED TO FINAL RESTORATION, OR TEMPORARY RESTORATION PENDING WEATHER AND SOIL CONDITIONS. IF SEASONAL OR WEATHER CONDITIONS PREVENT COMPLIANCE WITH THESE TIME FRAMES, TEMPORARY EROSION CONTROLS MUST BE MONITORED AND MAINTAINED UNTIL CONDITIONS ALLOW COMPLETION OF RESTORATION.
- NECESSARY TO MINIMIZE FUGITIVE DUST FROM
- AT ALL TIMES, OR OTHER ACCOMMODATIONS WILL BE MADE WITH EACH RESPECTIVE LANDOWNER.
- 9. CONTRACTOR SHALL MAINTAIN AGREED UPON ACCESS TO THE IMPACTED AREA DURING CONSTRUCTION.
- DAYLIGHT HOURS, UNLESS OTHERWISE AGREED UPON
- PROPOSED CONSTRUCTION ACTIVITIES PRIOR TO

Co<u>l</u>umbia

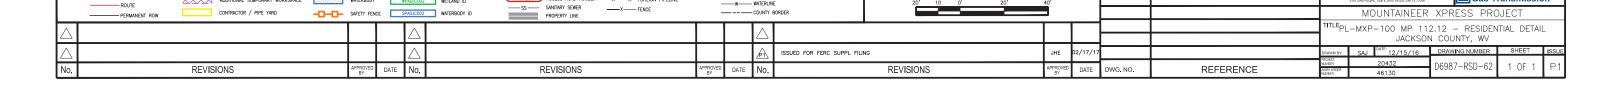

ARWIOO1 ACCESS ROAD NUMBER —I ——I — FOREIGN PIPELINE



1.0 MILEPOST

TRACT WV-PU-0405.000

PUTNAM COUNTY, WEST VIRGINIA



ST-CO-001.000 PROPERTY TRACT NUMBER

ADDITIONAL TEMPORARY WORKSPACE SECRETARY WATERBODY WPADJCOOZ WETLAND ID

- ACCESS ROAD

ARWIOO1 ACCESS ROAD NUMBER —I ——I — FOREIGN PIPELINE

DESCRIPTION

THIS DRAWING DOCUMENTS MITIGATION MEASURES THAT WILL BE IMPLEMENTED FOR ALL RESIDENCES WITHIN 50 FEET OF THE PROPOSED CONSTRUCTION WORK AREA. CONTRACTOR SHALL COMPLY WITH THE FOLLOWING CONSTRUCTION MITIGATION REQUIREMENTS IN ADDITION TO THOSE LISTED IN THE CONSTRUCTION SPECIFICATIONS.

CONSTRUCTION REQUIREMENTS

- 1. CONTRACTOR SHALL ERECT AND MAINTAIN A SAFETY FENCE BETWEEN THE CONSTRUCTION ZONE AND THE ADJACENT RESIDENCES EXTENDING 100 FEET ON EITHER SIDE OF THE RESIDENCE TO ENSURE THAT EQUIPMENT, MATERIALS AND SPOIL REMAIN WITHIN THE CONSTRUCTION WORK AREA.
- 2. A MINIMUM OF 25 FEET WILL BE MAINTAINED BETWEEN THE RESIDENCE AND CONSTRUCTION WORK AREA FOR A DISTANCE OF 100 FEET ON EITHER SIDE OF THE RESIDENCE. IF THE FACILITY MUST BE WITHIN 25 FEET OF A RESIDENCE, IT MUST BE INSTALLED SUCH THAT THE TRENCH DOES NOT REMAIN OPEN OVERNIGHT.
- 3. MATURE TREES AND LANDSCAPING WILL NOT BE REMOVED FROM WITHIN THE EDGE OF THE CONSTRUCTION WORK AREA UNLESS NECESSARY FOR SAFE OPERATION OF CONSTRUCTION EQUIPMENT OR AS SPECIFIED IN LANDOWNER AGREEMENTS.
- 4. OTHER EXISTING PHYSICAL FEATURES THAT NEED TO BE PROTECTED WILL BE ENCLOSED IN SAFETY FENCE TO AVOID DISTURBANCE DURING CONSTRUCTION.
- 5. TRENCH SHALL NOT BE EXCAVATED UNTIL PIPELINE IS READY FOR INSTALLATION AND SHALL BE BACKFILLED IN SAME DAY AS PIPE INSTALLATION IN THIS AREA. ALL OPEN DITCHES SHALL BE BARRICADED/FENCED OFF OR PLATED WHEN CONSTRUCTION ACTIVITIES ARE NOT IN PROGRESS.
- 6. IMMEDIATELY AFTER BACKFILLING THE TRENCH, ALL LAWN AND LANDSCAPING WILL BE RESTORED TO FINAL RESTORATION, OR TEMPORARY RESTORATION PENDING WEATHER AND SOIL CONDITIONS. IF SEASONAL OR WEATHER CONDITIONS PREVENT COMPLIANCE WITH THESE TIME FRAMES, TEMPORARY EROSION CONTROLS MUST BE MONITORED AND MAINTAINED UNTIL CONDITIONS ALLOW COMPLETION OF RESTORATION.
- 7. CONTRACTOR SHALL UTILIZE WATER TRUCKS AS NECESSARY TO MINIMIZE FUGITIVE DUST FROM CONSTRUCTION ACTIVITIES NEAR RESIDENCES/BUSINESSES.
- 8. ACCESS TO RESIDENCES BY CAR WILL BE MAINTAINED AT ALL TIMES, OR OTHER ACCOMMODATIONS WILL BE MADE WITH EACH RESPECTIVE LANDOWNER.
- 9. CONTRACTOR SHALL MAINTAIN AGREED UPON ACCESS TO THE IMPACTED AREA DURING CONSTRUCTION.
- 10. CONTRACTOR SHALL LIMIT WORK IN THIS AREA TO DAYLIGHT HOURS, UNLESS OTHERWISE AGREED UPON WITH LANDOWNER/OCCUPANT.
- 11. LANDOWNER/OCCUPANT SHALL BE NOTIFIED OF PROPOSED CONSTRUCTION ACTIVITIES PRIOR TO CONSTRUCTION WORK.

PROJECT DELIVERY PROJECT ENGINEERING

PROPOSED 36" PL-MXP-100 PIPELINE

ISSUED FOR FERC SUPPL 02/17/2017

Co<u>l</u>umbia

- 1	PERMANENT ROW	CONTRACTOR / PIPE YARD	SAFETY FENCE	SPADJC002 WATERBOO	SS SANIJARY SEWER —X — FENCE PROPERTY LINE			UNTY BORDER					MOUNTAINEER XPRESS PROJECT				
Ī	\wedge							\wedge						TITLE PL-MXP-100 MP 1	45.3 — RESIDENT M COUNTY, WV	TAL DETAIL	
ľ	_		- 			\vdash		A ISSUED FOR FERC SUPPL F	INC.	INC	02/17/17			DRAWN BY: SAJ DATE: 12/23/16	DRAWING NUMBER	SHEET IS	SUE
ŀ	No.	REVISIONS	APPROVED DATI		REVISIONS	APPROVED	DATE	No.	REVISIONS	APPROVED	DATE	DWG. NO.	REFERENCE	PROJECT 20432 WORK CROSER 46130	D6987-RSD-63	1 OF 1 F	² 1



TRACT WV-CB-0006.001

CABELL COUNTY, WEST VIRGINIA



REVISIONS

ISSUED FOR FERC SUPPL FILING

REVISIONS

DESCRIPTION

THIS DRAWING DOCUMENTS MITIGATION MEASURES THAT WILL BE IMPLEMENTED FOR ALL RESIDENCES WITHIN 50 FEET OF THE PROPOSED CONSTRUCTION WORK AREA. CONTRACTOR SHALL COMPLY WITH THE FOLLOWING CONSTRUCTION MITIGATION REQUIREMENTS IN ADDITION TO THOSE LISTED IN THE CONSTRUCTION SPECIFICATIONS.

- 1. CONTRACTOR SHALL ERECT AND MAINTAIN A SAFETY FENCE BETWEEN THE CONSTRUCTION ZONE AND THE ADJACENT RESIDENCES EXTENDING 100 FEET ON EITHER SIDE OF THE RESIDENCE TO ENSURE THAT EQUIPMENT, MATERIALS AND SPOIL REMAIN WITHIN THE
- 2. A MINIMUM OF 25 FEET WILL BE MAINTAINED BETWEEN THE RESIDENCE AND CONSTRUCTION WORK AREA FOR A DISTANCE OF 100 FEET ON EITHER SIDE OF THE RESIDENCE. IF THE FACILITY MUST BE WITHIN 25 FEET OF A RESIDENCE, IT MUST BE INSTALLED SUCH THAT THE TRENCH DOES NOT REMAIN OPEN OVERNIGHT.
- 3. MATURE TREES AND LANDSCAPING WILL NOT BE REMOVED FROM WITHIN THE EDGE OF THE CONSTRUCTION WORK AREA UNLESS NECESSARY FOR SAFE OPERATION OF CONSTRUCTION EQUIPMENT OR AS SPECIFIED IN LANDOWNER AGREEMENTS.
- 4. OTHER EXISTING PHYSICAL FEATURES THAT NEED TO BE PROTECTED WILL BE ENCLOSED IN SAFETY FENCE TO AVOID DISTURBANCE DURING CONSTRUCTION.
- 5. TRENCH SHALL NOT BE EXCAVATED UNTIL PIPELINE IS READY FOR INSTALLATION AND SHALL BE BACKFILLED IN SAME DAY AS PIPE INSTALLATION IN THIS AREA. ALL OPEN DITCHES SHALL BE BARRICADED/FENCED OFF OR PLATED WHEN CONSTRUCTION ACTIVITIES ARE
- 6. IMMEDIATELY AFTER BACKFILLING THE TRENCH, ALL LAWN AND LANDSCAPING WILL BE RESTORED TO FINAL RESTORATION, OR TEMPORARY RESTORATION PENDING WEATHER AND SOIL CONDITIONS. IF SEASONAL OR WEATHER CONDITIONS PREVENT COMPLIANCE WITH THESE TIME FRAMES, TEMPORARY EROSION CONTROLS MUST BE MONITORED AND MAINTAINED UNTIL CONDITIONS ALLOW COMPLETION OF RESTORATION.
- 7. CONTRACTOR SHALL UTILIZE WATER TRUCKS AS NECESSARY TO MINIMIZE FUGITIVE DUST FROM CONSTRUCTION ACTIVITIES NEAR
- 8. ACCESS TO RESIDENCES BY CAR WILL BE MAINTAINED AT ALL TIMES, OR OTHER ACCOMMODATIONS WILL BE MADE WITH EACH RESPECTIVE LANDOWNER.
- 9. CONTRACTOR SHALL MAINTAIN AGREED UPON ACCESS TO THE IMPACTED AREA DURING CONSTRUCTION.
- 10. CONTRACTOR SHALL LIMIT WORK IN THIS AREA TO DAYLIGHT HOURS, UNLESS OTHERWISE AGREED UPON WITH LANDOWNER/OCCUPANT.
- 11. LANDOWNER/OCCUPANT SHALL BE NOTIFIED OF PROPOSED CONSTRUCTION ACTIVITIES PRIOR TO

REFERENCE

ISSUED FOR FERC SUPPL

ITLE PL-MXP-100 MP 156.8 - RESIDENTIAL DETAIL CABELL COUNTY, WV

)6987-RSD-6



REVISIONS

TRACT WV-CB-0371.000

CABELL COUNTY, WEST VIRGINIA



ISSUED FOR FERC SUPPL FILING

REVISIONS

REVISIONS

DESCRIPTION

THIS DRAWING DOCUMENTS MITIGATION MEASURES THAT WILL BE IMPLEMENTED FOR ALL RESIDENCES WITHIN 50 FEET OF THE PROPOSED CONSTRUCTION WORK AREA. CONTRACTOR SHALL COMPLY WITH THE FOLLOWING CONSTRUCTION MITIGATION REQUIREMENTS IN ADDITION TO

- 1. CONTRACTOR SHALL ERECT AND MAINTAIN A SAFETY FENCE BETWEEN THE CONSTRUCTION ZONE AND THE ADJACENT RESIDENCES EXTENDING 100 FEET ON EITHER SIDE OF THE RESIDENCE TO ENSURE THAT EQUIPMENT, MATERIALS AND SPOIL REMAIN WITHIN THE
- 2. A MINIMUM OF 25 FEET WILL BE MAINTAINED BETWEEN THE RESIDENCE AND CONSTRUCTION WORK AREA FOR A DISTANCE OF 100 FEET ON EITHER SIDE OF THE RESIDENCE. IF THE FACILITY MUST BE WITHIN 25 FEET OF A RESIDENCE, IT MUST BE INSTALLED SUCH THAT THE TRENCH DOES NOT REMAIN OPEN OVERNIGHT.
- 3. MATURE TREES AND LANDSCAPING WILL NOT BE REMOVED FROM WITHIN THE EDGE OF THE CONSTRUCTION WORK AREA UNLESS NECESSARY FOR SAFE OPERATION OF CONSTRUCTION EQUIPMENT OR AS SPECIFIED IN LANDOWNER AGREEMENTS.
- 4. OTHER EXISTING PHYSICAL FEATURES THAT NEED TO BE PROTECTED WILL BE ENCLOSED IN SAFETY FENCE TO AVOID DISTURBANCE DURING CONSTRUCTION.
- 5. TRENCH SHALL NOT BE EXCAVATED UNTIL PIPELINE IS READY FOR INSTALLATION AND SHALL BE BACKFILLED IN SAME DAY AS PIPE INSTALLATION IN THIS AREA. ALL OPEN DITCHES SHALL BE BARRICADED/FENCED OFF OR PLATED WHEN CONSTRUCTION ACTIVITIES ARE
- 6. IMMEDIATELY AFTER BACKFILLING THE TRENCH, ALL LAWN AND LANDSCAPING WILL BE RESTORED TO FINAL RESTORATION, OR TEMPORARY RESTORATION PENDING WEATHER AND SOIL CONDITIONS. IF SEASONAL OR WEATHER CONDITIONS PREVENT COMPLIANCE WITH THESE TIME FRAMES, TEMPORARY EROSION CONTROLS MUST BE MONITORED AND MAINTAINED UNTIL
- 7. CONTRACTOR SHALL UTILIZE WATER TRUCKS AS NECESSARY TO MINIMIZE FUGITIVE DUST FROM
- 8. ACCESS TO RESIDENCES BY CAR WILL BE MAINTAINED AT ALL TIMES, OR OTHER ACCOMMODATIONS WILL BE MADE WITH EACH RESPECTIVE LANDOWNER.
- 9. CONTRACTOR SHALL MAINTAIN AGREED UPON ACCESS TO THE IMPACTED AREA DURING CONSTRUCTION.
- DAYLIGHT HOURS, UNLESS OTHERWISE AGREED UPON
- PROPOSED CONSTRUCTION ACTIVITIES PRIOR TO

REFERENCE

DATE

ISSUED FOR FERC SUPPL

06987-RSD-6

Columbia





TRACT WV-CB-0806.001

CABELL COUNTY, WEST VIRGINIA

ARCR011

WV-CB-0806.000

(STRUCTURE)

WV-CB-0806.001

DESCRIPTION

THIS DRAWING DOCUMENTS MITIGATION MEASURES THAT WILL BE IMPLEMENTED FOR ALL RESIDENCES WITHIN 50 FEET OF THE PROPOSED CONSTRUCTION WORK AREA. CONTRACTOR SHALL COMPLY WITH THE FOLLOWING CONSTRUCTION MITIGATION REQUIREMENTS IN ADDITION TO THOSE LISTED IN THE CONSTRUCTION SPECIFICATIONS.

CONSTRUCTION REQUIREMENTS

- CONTRACTOR SHALL ERECT AND MAINTAIN A SAFETY FENCE BETWEEN THE CONSTRUCTION ZONE AND THE ADJACENT RESIDENCES EXTENDING 100 FEET ON EITHER SIDE OF THE RESIDENCE TO ENSURE THAT EQUIPMENT, MATERIALS AND SPOIL REMAIN WITHIN THE CONSTRUCTION WORK AREA.
- 2. A MINIMUM OF 25 FEET WILL BE MAINTAINED BETWEEN THE RESIDENCE AND CONSTRUCTION WORK AREA FOR A DISTANCE OF 100 FEET ON EITHER SIDE OF THE RESIDENCE. IF THE FACILITY MUST BE WITHIN 25 FEET OF A RESIDENCE, IT MUST BE INSTALLED SUCH THAT THE TRENCH DOES NOT REMAIN OPEN OVERNIGHT.
- 3. MATURE TREES AND LANDSCAPING WILL NOT BE REMOVED FROM WITHIN THE EDGE OF THE CONSTRUCTION WORK AREA UNLESS NECESSARY FOR SAFE OPERATION OF CONSTRUCTION EQUIPMENT OR AS SPECIFIED IN LANDOWNER AGREEMENTS.
- 4. OTHER EXISTING PHYSICAL FEATURES THAT NEED TO BE PROTECTED WILL BE ENCLOSED IN SAFETY FENCE TO AVOID DISTURBANCE DURING CONSTRUCTION.
- 5. TRENCH SHALL NOT BE EXCAVATED UNTIL PIPELINE IS READY FOR INSTALLATION AND SHALL BE BACKFILLED IN SAME DAY AS PIPE INSTALLATION IN THIS AREA. ALL OPEN DITCHES SHALL BE BARRICADED/FENCED OFF OR PLATED WHEN CONSTRUCTION ACTIVITIES ARE NOT IN PROCRESS.
- 6. IMMEDIATELY AFTER BACKFILLING THE TRENCH, ALL LAWN AND LANDSCAPING WILL BE RESTORED TO FINAL RESTORATION, OR TEMPORARY RESTORATION PENDING WEATHER AND SOIL CONDITIONS. IF SEASONAL OR WEATHER CONDITIONS PREVENT COMPULANCE WITH THESE TIME FRAMES, TEMPORARY EROSION CONTROLS MUST BE MONITORED AND MAINTAINED UNTIL CONDITIONS ALLOW COMPLETION OF RESTORATION.
- CONTRACTOR SHALL UTILIZE WATER TRUCKS AS NECESSARY TO MINIMIZE FUGITIVE DUST FROM CONSTRUCTION ACTIVITIES NEAR RESIDENCES/BUSINESSES.
- ACCESS TO RESIDENCES BY CAR WILL BE MAINTAINED
 AT ALL TIMES, OR OTHER ACCOMMODATIONS WILL BE
 MADE WITH EACH RESPECTIVE LANDOWNER.
- CONTRACTOR SHALL MAINTAIN AGREED UPON ACCESS TO THE IMPACTED AREA DURING CONSTRUCTION.
- CONTRACTOR SHALL LIMIT WORK IN THIS AREA TO DAYLIGHT HOURS, UNLESS OTHERWISE AGREED UPON WITH LANDOWNER/OCCUPANT.
- 11. LANDOWNER/OCCUPANT SHALL BE NOTIFIED OF PROPOSED CONSTRUCTION ACTIVITIES PRIOR TO CONSTRUCTION WORK.

MOUNTAINEER XPRESS\CA						1	/	/			を記			ISSUED FOR FERC SUPPL 10/02/2016	
LEGEND	. VI MILEPOST ZZZ TEMPORARY WORKSPACE ROUTE ADDITIONAL TEMPORARY WORKSPACE		ST-CO-001.000 PR		LONE		- OVERHEAD	POWER LINE	SCALE: <u>1" = 20</u> " 20' 10' 0' 20' 40'			D6989-ALG-001	30" SM-80 LOOP REPLACEMENT	PROJECT DELIVERY PROJECT ENGINEERING IIII ANVIRE PE BEITE ADDI. MERADOM TO 17798 COlumb	oia mission
57300	PERMANENT ROW CONTRACTOR / PIPE YARD	SAFETY FENCE	SPADJICTO2 WX	ATERBODY ID SANITARY SEWER —X—FENCE PROPERTY LINE										MOUNTAINEER XPRESS PROJECT	
CTS/53			Δ				Δ							TITLE 30" SM-80 REPL LOOP MP 20.75 - RESIDENTIAL I CABELL COUNTY, WV	DETAIL
ğ 🛆					1		A	ISSUED FOR FERC SUPPL FI	ILING J	JHE	10/02/16			DRAWING NUMBER SHEE	ēT ISSUE
Ño.	REVISIONS	APPROVED DA	ATE No.	REVISIONS	APPROVED BY	DATE	No.		REVISIONS APP	PPROVED BY	DATE	DWG. NO.	REFERENCE	20432 D6989-RSD-02 1 OF	F 1 P1

HOUSE (STRUCTURE)

PRIVATE DRIVE



TRACT TAX ID NO. 1-17-21.4 CABELL COUNTY, WEST VIRGINIA

WV-CB-0807.000 WV-CB-0811.000 TAX_ID#1-17-21. 30" SM-80 LOOP REPLACEMENT ST-CO-001.000 PROPERTY TRACT

____X____FENCE

REVISIONS

WPADJC002 WETLAND ID

SAFETY FENCE SPADJCCCC WATERBOOY ID

CONTRACTOR / PIPE YARD

REVISIONS

THIS DRAWING DOCUMENTS MITIGATION MEASURES THAT WILL BE IMPLEMENTED FOR ALL RESIDENCES WITHIN 50 FEET OF THE PROPOSED CONSTRUCTION WORK AREA. CONTRACTOR SHALL COMPLY WITH THE FOLLOWING CONSTRUCTION MITIGATION REQUIREMENTS IN ADDITION TO THOSE LISTED IN THE CONSTRUCTION SPECIFICATIONS.

CONSTRUCTION REQUIREMENTS

- 1. CONTRACTOR SHALL ERECT AND MAINTAIN A SAFETY FENCE BETWEEN THE CONSTRUCTION ZONE AND THE ADJACENT RESIDENCES EXTENDING 100 FEET ON EITHER SIDE OF THE RESIDENCE TO ENSURE THAT EQUIPMENT, MATERIALS AND SPOIL REMAIN WITHIN THE CONSTRUCTION WORK AREA.
- 2. A MINIMUM OF 25 FEET WILL BE MAINTAINED BETWEEN THE RESIDENCE AND CONSTRUCTION WORK AREA FOR A DISTANCE OF 100 FEET ON EITHER SIDE OF THE RESIDENCE. IF THE FACILITY MUST BE WITHIN 25 FEET OF A RESIDENCE, IT MUST BE INSTALLED SUCH THAT THE TRENCH DOES NOT REMAIN OPEN OVERNIGHT.
- 3. MATURE TREES AND LANDSCAPING WILL NOT BE REMOVED FROM WITHIN THE EDGE OF THE CONSTRUCTION WORK AREA UNLESS NECESSARY FOR SAFE OPERATION OF CONSTRUCTION EQUIPMENT OR AS SPECIFIED IN LANDOWNER AGREEMENTS.
- 4. OTHER EXISTING PHYSICAL FEATURES THAT NEED TO BE PROTECTED WILL BE ENCLOSED IN SAFETY FENCE TO AVOID DISTURBANCE DURING CONSTRUCTION.
- TRENCH SHALL NOT BE EXCAVATED UNTIL PIPELINE IS READY FOR INSTALLATION AND SHALL BE BACKFILLED IN SAME DAY AS PIPE INSTALLATION IN THIS AREA. ALL OPEN DITCHES SHALL BE BARRICADED/FENCED OFF OR PLATED WHEN CONSTRUCTION ACTIVITIES ARE NOT IN PROGRESS.
- 6. IMMEDIATELY AFTER BACKFILLING THE TRENCH, ALL LAWN AND LANDSCAPING WILL BE RESTORED TO FINAL RESTORATION, OR TEMPORARY RESTORATION PENDING WEATHER AND SOIL CONDITIONS, IF SEASONAL OR WEATHER CONDITIONS PREVENT COMPLIANCE WITH THESE TIME FRAMES, TEMPORARY EROSION CONTROLS MUST BE MONITORED AND MAINTAINED UNTIL CONDITIONS ALLOW COMPLETION OF RESTORATION.
- 7. CONTRACTOR SHALL UTILIZE WATER TRUCKS AS NECESSARY TO MINIMIZE FUGITIVE DUST FROM CONSTRUCTION ACTIVITIES NEAR RESIDENCES/BUSINESSES.
- 8. ACCESS TO RESIDENCES BY CAR WILL BE MAINTAINED AT ALL TIMES, OR OTHER ACCOMMODATIONS WILL BE MADE WITH EACH RESPECTIVE LANDOWNER.
- 9. CONTRACTOR SHALL MAINTAIN AGREED UPON ACCESS TO THE IMPACTED AREA DURING CONSTRUCTION.
- 10. CONTRACTOR SHALL LIMIT WORK IN THIS AREA TO DAYLIGHT HOURS, UNLESS OTHERWISE AGREED UPON WITH LANDOWNER/OCCUPANT.
- 11. LANDOWNER/OCCUPANT SHALL BE NOTIFIED OF PROPOSED CONSTRUCTION ACTIVITIES PRIOR TO CONSTRUCTION WORK.

TTLE 30" SM-80 REPL LOOP MP 20.74-RESIDENTIAL DETAIL CABELL COUNTY, WV

REFERENCE

D6989-RSD-03

ISSUED FOR FERC SUPPL FILING

REVISIONS



REVISIONS

TRACT WV-CB-0807.000

CABELL COUNTY, WEST VIRGINIA



REVISIONS

THIS DRAWING DOCUMENTS MITIGATION MEASURES THAT WILL BE IMPLEMENTED FOR ALL RESIDENCES WITHIN 50 FEET OF THE PROPOSED CONSTRUCTION WORK AREA. CONTRACTOR SHALL COMPLY WITH THE FOLLOWING CONSTRUCTION MITIGATION REQUIREMENTS IN ADDITION TO THOSE LISTED IN THE CONSTRUCTION SPECIFICATIONS.

CONSTRUCTION REQUIREMENTS

- 1. CONTRACTOR SHALL ERECT AND MAINTAIN A SAFETY FENCE BETWEEN THE CONSTRUCTION ZONE AND THE ADJACENT RESIDENCES EXTENDING 100 FEET ON EITHER SIDE OF THE RESIDENCE TO ENSURE THAT EQUIPMENT, MATERIALS AND SPOIL REMAIN WITHIN THE CONSTRUCTION WORK AREA.
- 2. A MINIMUM OF 25 FEET WILL BE MAINTAINED BETWEEN THE RESIDENCE AND CONSTRUCTION WORK AREA FOR A DISTANCE OF 100 FEET ON EITHER SIDE OF THE RESIDENCE. IF THE FACILITY MUST BE WITHIN 25 FEET OF A RESIDENCE, IT MUST BE INSTALLED SUCH THAT THE TRENCH DOES NOT REMAIN OPEN OVERNIGHT.
- 3. MATURE TREES AND LANDSCAPING WILL NOT BE REMOVED FROM WITHIN THE EDGE OF THE CONSTRUCTION WORK AREA UNLESS NECESSARY FOR SAFE OPERATION OF CONSTRUCTION EQUIPMENT OR AS SPECIFIED IN LANDOWNER AGREEMENTS.
- OTHER EXISTING PHYSICAL FEATURES THAT NEED TO BE PROTECTED WILL BE ENCLOSED IN SAFETY FENCE TO AVOID DISTURBANCE DURING CONSTRUCTION.
- TRENCH SHALL NOT BE EXCAVATED UNTIL PIPELINE IS READY FOR INSTALLATION AND SHALL BE BACKFILLED IN SAME DAY AS PIPE INSTALLATION IN THIS AREA. ALL OPEN DITCHES SHALL BE BARRICADED/FENCED OFF OR PLATED WHEN CONSTRUCTION ACTIVITIES ARE NOT IN PROGRESS.
- 6. IMMEDIATELY AFTER BACKFILLING THE TRENCH, ALL LAWN AND LANDSCAPING WILL BE RESTORED TO FINAL RESTORATION, OR TEMPORARY RESTORATION PENDING WEATHER AND SOIL CONDITIONS, IF SEASONAL OR WEATHER CONDITIONS PREVENT COMPLIANCE WITH THESE TIME FRAMES, TEMPORARY EROSION CONTROLS MUST BE MONITORED AND MAINTAINED UNTIL CONDITIONS ALLOW COMPLETION OF RESTORATION.
- 7. CONTRACTOR SHALL UTILIZE WATER TRUCKS AS NECESSARY TO MINIMIZE FUGITIVE DUST FROM CONSTRUCTION ACTIVITIES NEAR RESIDENCES/BUSINESSES.
- 8. ACCESS TO RESIDENCES BY CAR WILL BE MAINTAINED AT ALL TIMES, OR OTHER ACCOMMODATIONS WILL BE MADE WITH EACH RESPECTIVE LANDOWNER.
- 9. CONTRACTOR SHALL MAINTAIN AGREED UPON ACCESS TO THE IMPACTED AREA DURING CONSTRUCTION.
- 10. CONTRACTOR SHALL LIMIT WORK IN THIS AREA TO DAYLIGHT HOURS, UNLESS OTHERWISE AGREED UPON WITH LANDOWNER/OCCUPANT.
- 11. LANDOWNER/OCCUPANT SHALL BE NOTIFIED OF PROPOSED CONSTRUCTION ACTIVITIES PRIOR TO CONSTRUCTION WORK.

TLE 30" SM-80 REPL LOOP MP 20.73-RESIDENTIAL DETAIL D6989-RSD-04


REFERENCE


B-1-79


ISSUED FOR FERC SUPPL FILING


REVISIONS


APPENDIX B-2 Overview Mapping for the Gulf XPress Project

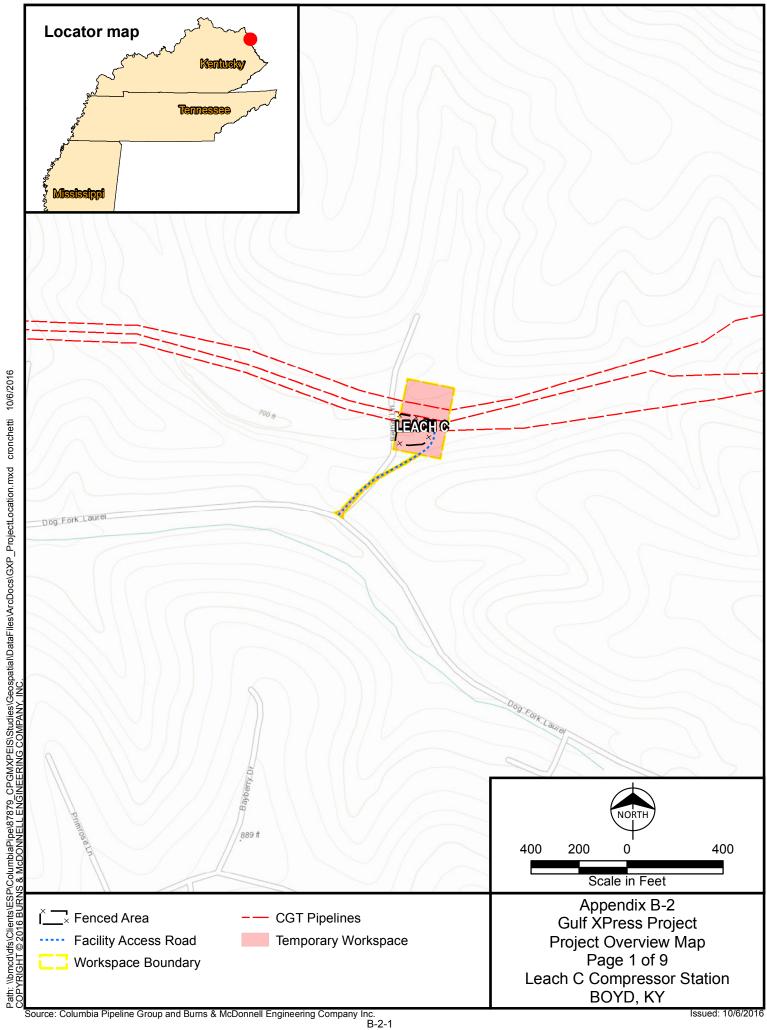


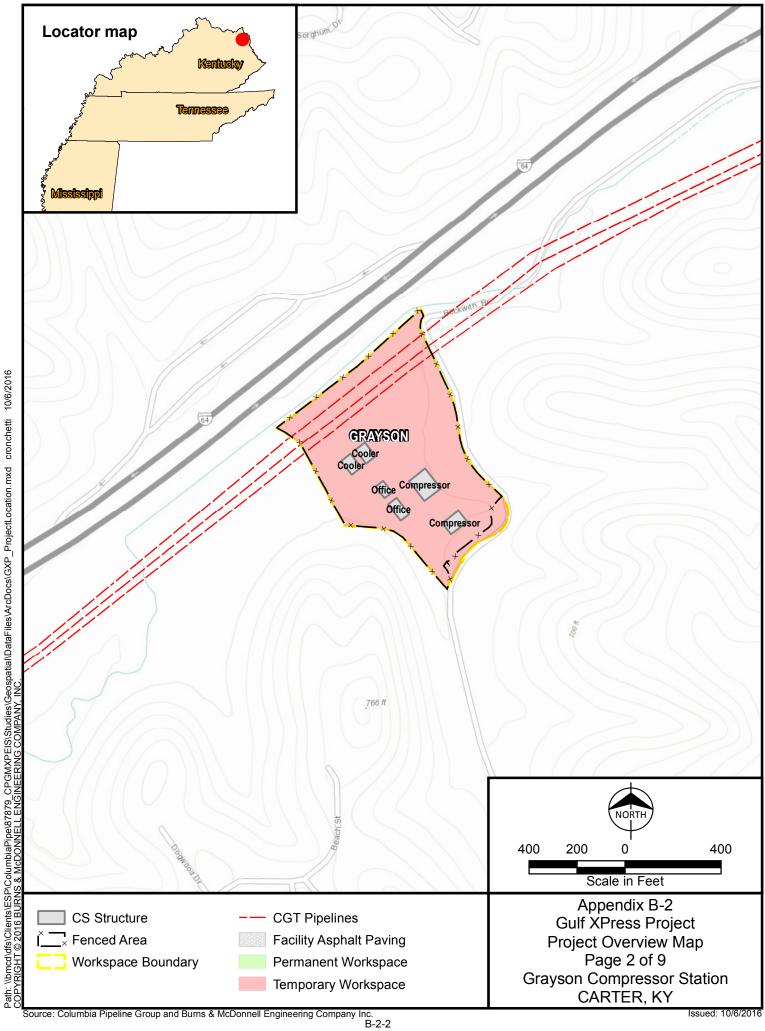


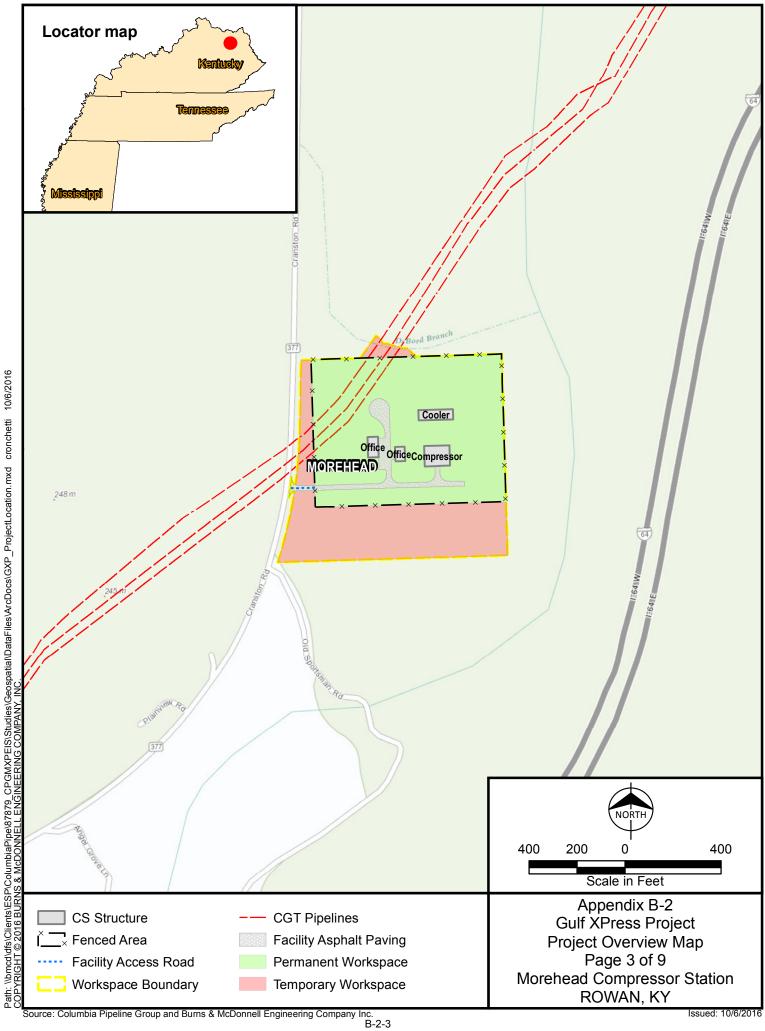


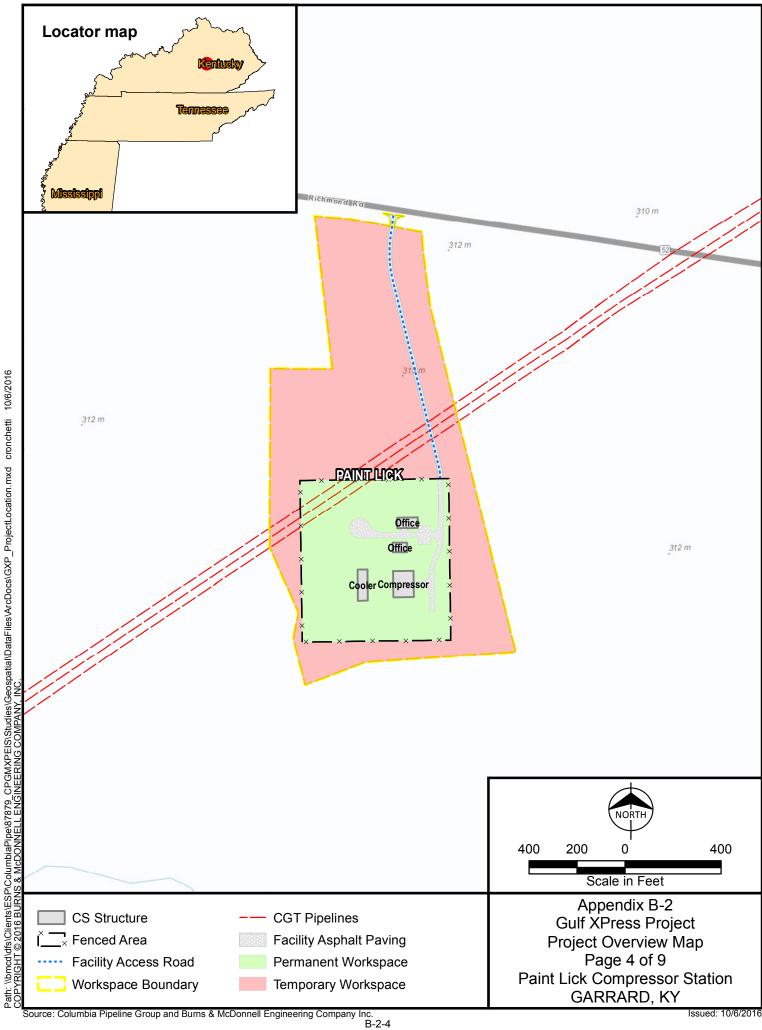


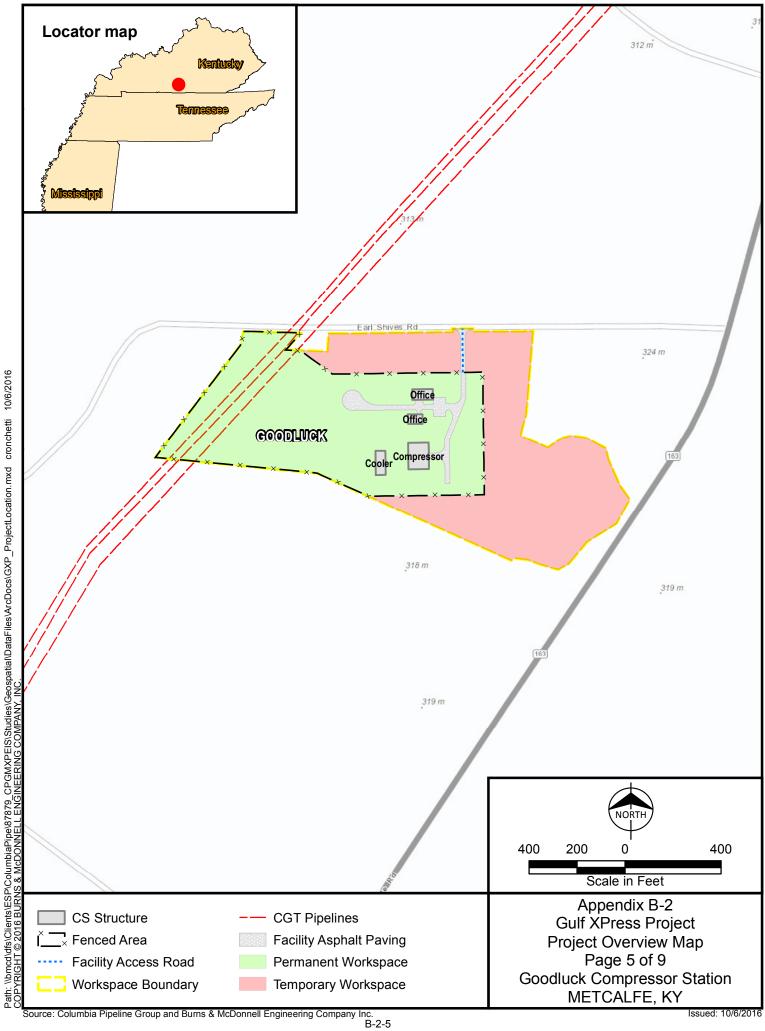

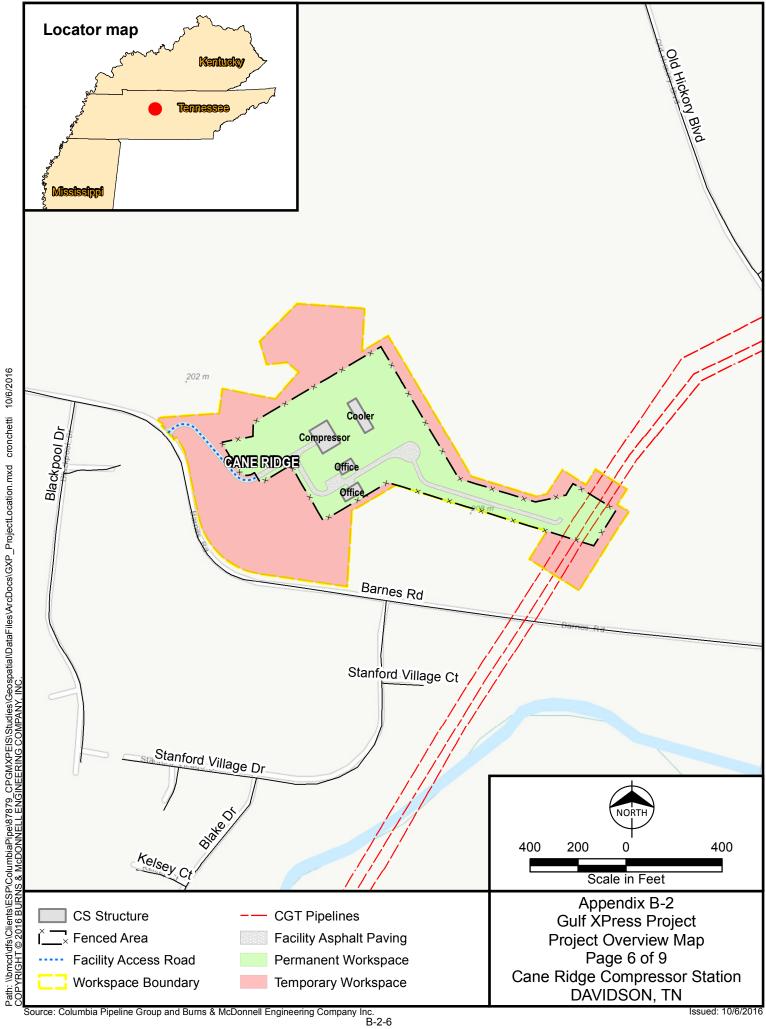


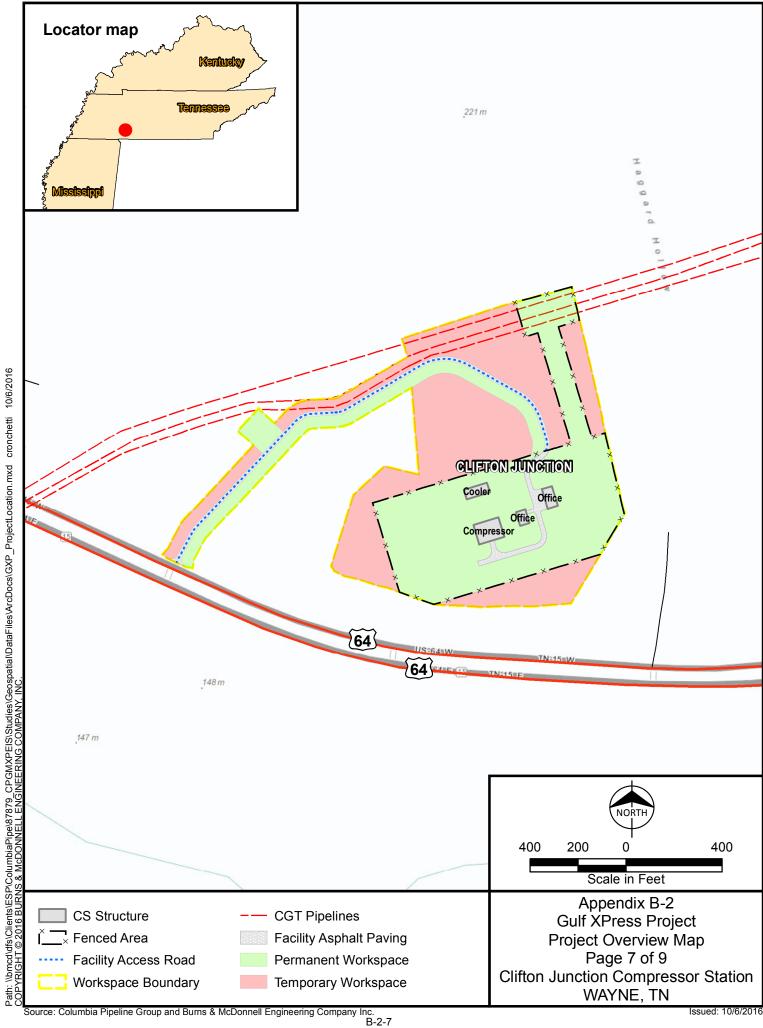

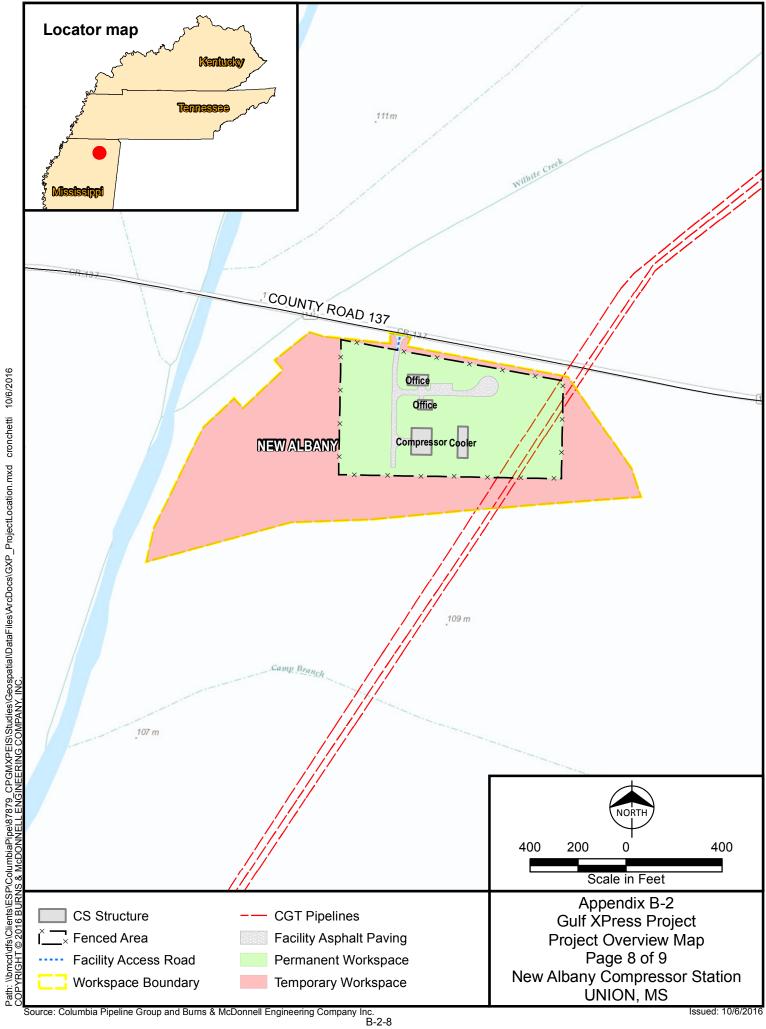


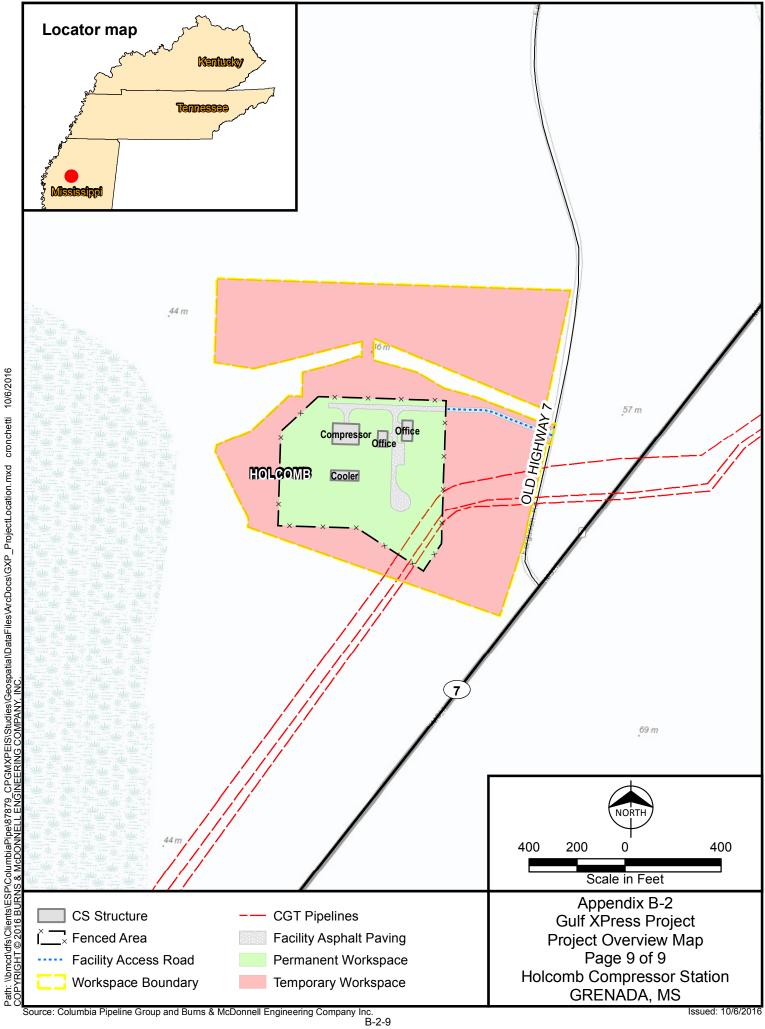

APPENDIX C Typical Construction Right-of-way Configurations

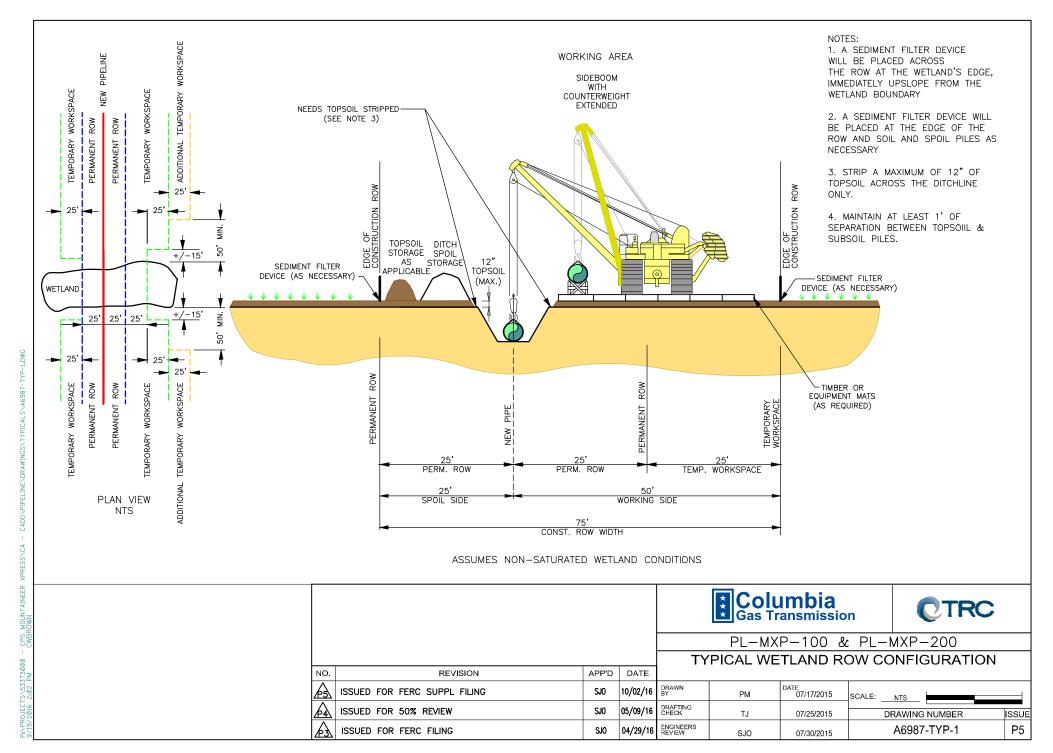


SJO

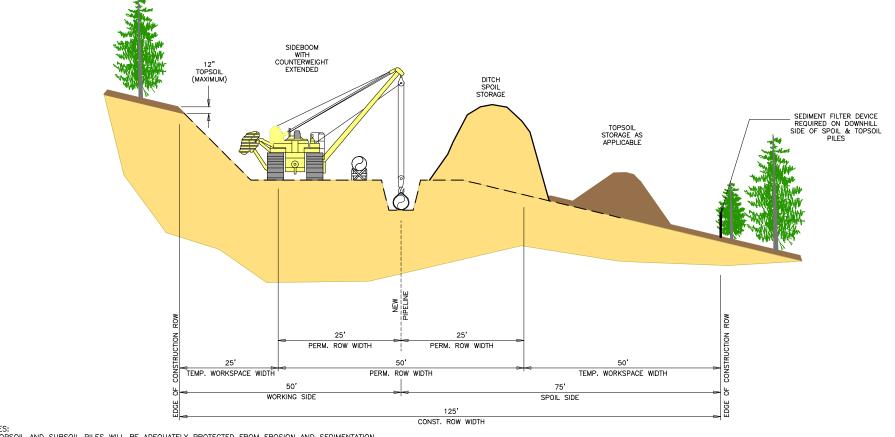

- NOTES:
 1. TOPSOIL AND SUBSOIL PILES WILL BE ADEQUATELY PROTECTED FROM EROSION AND SEDIMENTATION BY USE OF A SEDIMENT FILTER DEVICE, MULCH, TEMPORARY SEEDING, TACKIFIERS, OR FUNCTIONAL EQUIVALENT.
- 2. STRIP A MAXIMUM OF 12" OF TOPSOIL ACROSS THE ENTIRE CONSTRUCTION ROW WHERE SOIL SEGREGATION IS APPLICABLE
- 3. SEGREGATE TO ACTUAL TOPSOIL DEPTH IF LESS THAN 12" OF TOPSOIL IS PRESENT.
- 4. MAINTAIN AT LEAST 1' OF SEPARATION BETWEEN TOPSOIL & SUBSOIL PILES.


					Colu Gas Tr	ımbia _{ansmissio}	n		TRO	>
						PL-MX	⊃ – 10	0		
				М	IAINLINE C	ONSTRU	CTIO	N GRE	ENFIELD)
NO.	REVISION	APP'D	DATE	CONST	RUCTION	TYPICAL	SIDE	HILL F	RIGHT-OF	WAY
Æ	ISSUED FOR FERC SUPPL FILING	SJ0	10/02/16	DRAWN BY	PM	DATE 07/17/2015	SCALE:	NTS		
PA	ISSUED FOR 50% REVIEW	SJ0	05/09/16	DRAFTING CHECK	TJ	07/25/2015		DRAWING	NUMBER	ISSUE
Æ	ISSUED FOR FERC FILING	SJ0	04/29/16	ENGINEERS REVIEW	SJO	07/30/2015		A6987	-TYP-4	P5

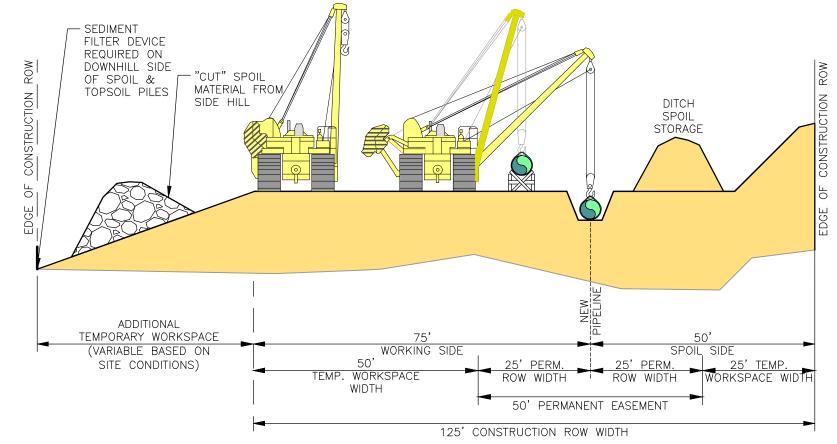

NOTES:

- 1. TOPSOIL AND SUBSOIL PILES WILL BE ADEQUATELY PROTECTED FROM EROSION AND SEDIMENTATION BY USE OF A SEDIMENT FILTER DEVICE, MULCH, TEMPORARY SEEDING, TACKIFIERS, OR FUNCTIONAL EQUIVALENT.
- 2. STRIP TOPSOIL IN ACCORDANCE WITH THE ECS AND LANDOWNER/LAND MANAGING AGENCY AGREEMENTS.
- 3. RESTORE CUT SLOPE USING NATIVE MATERIAL OR SUITABLE MATERIAL IN ACCORDANCE WITH COLUMBIA SPECIFICATIONS WHERE NATIVE MATERIAL HAS BEEN DETERMINED TO BE INAPPROPRIATE. DISPOSE OF ANY EXCESS MATERIAL IN ACCORDANCE WITH APPLICABLE LANDOWNER AND PERMIT CONDITIONS.
- 4. ON STEEP SIDE SLOPES CENTERLINE OF PIPE MAY BE ADJUSTED WITHIN PERM. ROW TO MEET FIELD CONDITIONS.


						Colu Gas Tr	ımbia ransmissio	n	CTR (
							PL-MXF	P-100		
							STEEP S			
	NO.	REVISION	APP'D	DATE		ATV	VS ON WC	RKING	SIDE	
4	A	ISSUED FOR FERC SUPPL FILING	SJ0	10/02/16	DRAWN BY	TBH	DATE 03/02/2016	SCALE: N	TS -	
	A	ISSUED FOR 50% REVIEW	SJ0	05/09/16	DRAFTING CHECK	TJ	03/02/2016		AWING NUMBER	ISSUE
	A	ISSUED FOR FERC FILING	SJO	04/29/16	ENGINEERS REVIEW	MLT	03/02/2016	P	\6987-TYP-5	P3

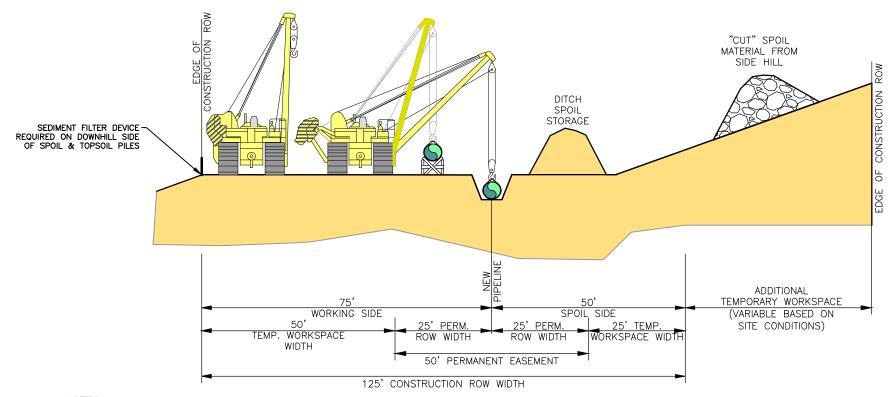



NOTES:


- 1. TOPSOIL AND SUBSOIL PILES WILL BE ADEQUATELY PROTECTED FROM EROSION AND SEDIMENTATION BY USE OF A SEDIMENT FILTER DEVICE, MULCH, TEMPORARY SEEDING, TACKIFIERS, OR FUNCTIONAL EQUIVALENT.
- 2. STRIP TOPSOIL IN ACCORDANCE WITH THE ECS AND LANDOWNER/LAND MANAGING AGENCY AGREEMENTS.
- 3. RESTORE CUT SLOPE USING NATIVE MATERIAL OR SUITABLE MATERIAL IN ACCORDANCE WITH COLUMBIA SPECIFICATIONS WHERE NATIVE MATERIAL HAS BEEN DETERMINED TO BE INAPPROPRIATE. DISPOSE OF ANY EXCESS MATERIAL IN ACCORDANCE WITH APPLICABLE LANDOWNER AND PERMIT CONDITIONS.
- 4. ON STEEP SIDE SLOPES CENTERLINE OF PIPE MAY BE ADJUSTED WITHIN PERM. ROW TO MEET FIELD CONDITIONS.


					Colu Gas Tr	ımbia ansmissio	n	CTRC	
						PL-MXF	P-100		
								OPE WITH	
NO.	REVISION	APP'D	DATE		A ⁻	TWS ON S	POIL S	IDE	
AS.	ISSUED FOR FERC SUPPL FILING	SJ0	10/02/16	DRAWN BY	TBH	DATE 03/02/2016	SCALE: N	тѕ	
$\cancel{\mathbb{A}}$	ISSUED FOR 50% REVIEW	SJ0	05/09/16	DRAFTING CHECK	TJ	03/02/2016		AWING NUMBER	ISSUE
A	ISSUED FOR FERC FILING	SJ0	04/29/16	ENGINEERS REVIEW	MLT	03/02/2016	<i>P</i>	A6987-TYP-6	P3

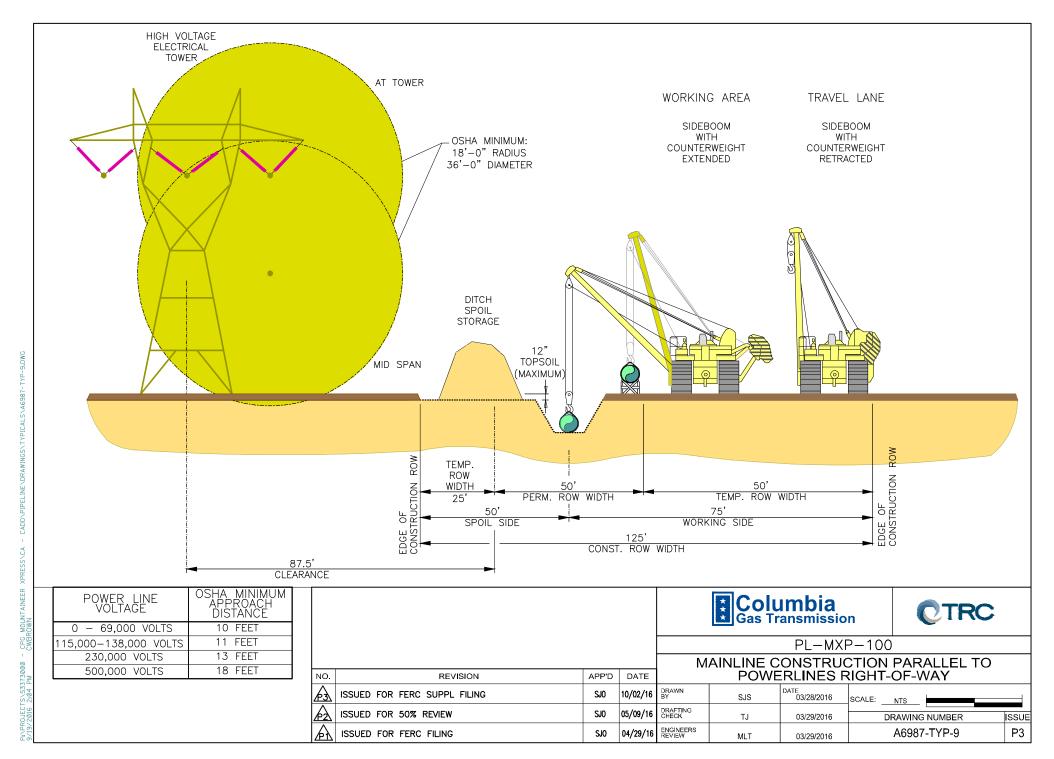


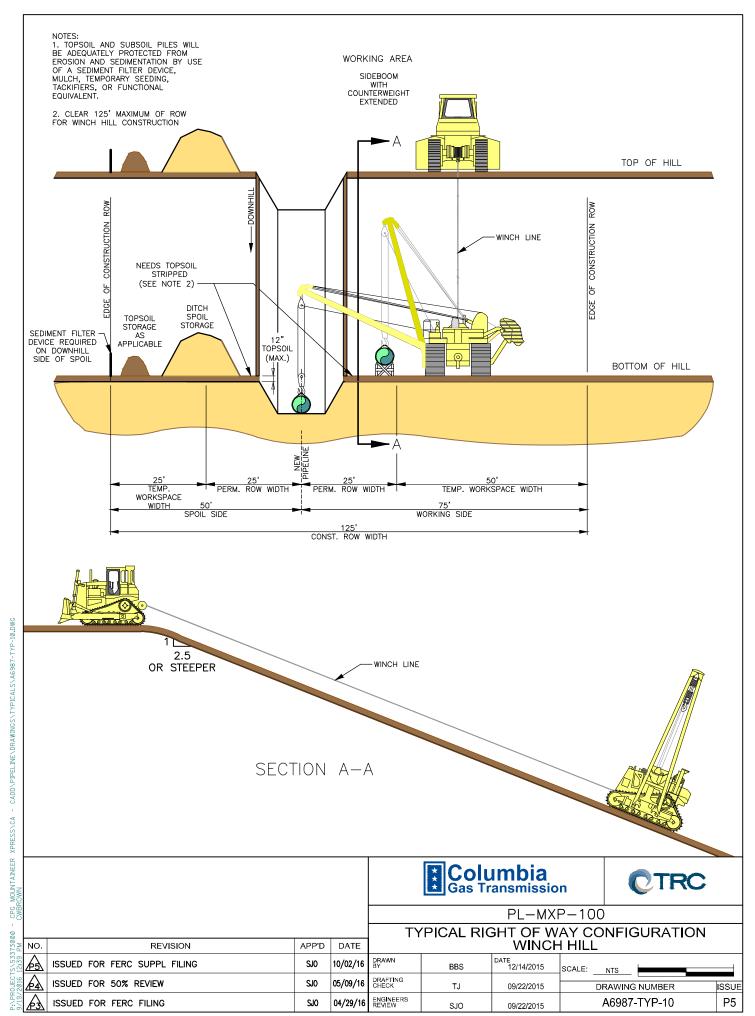

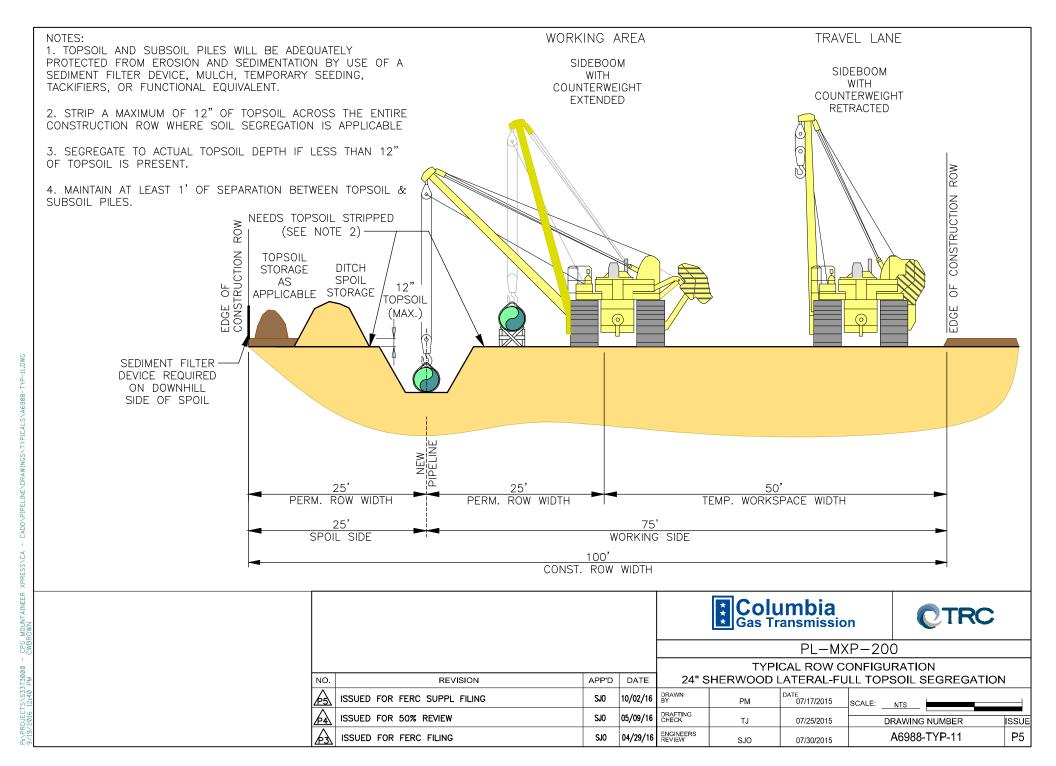


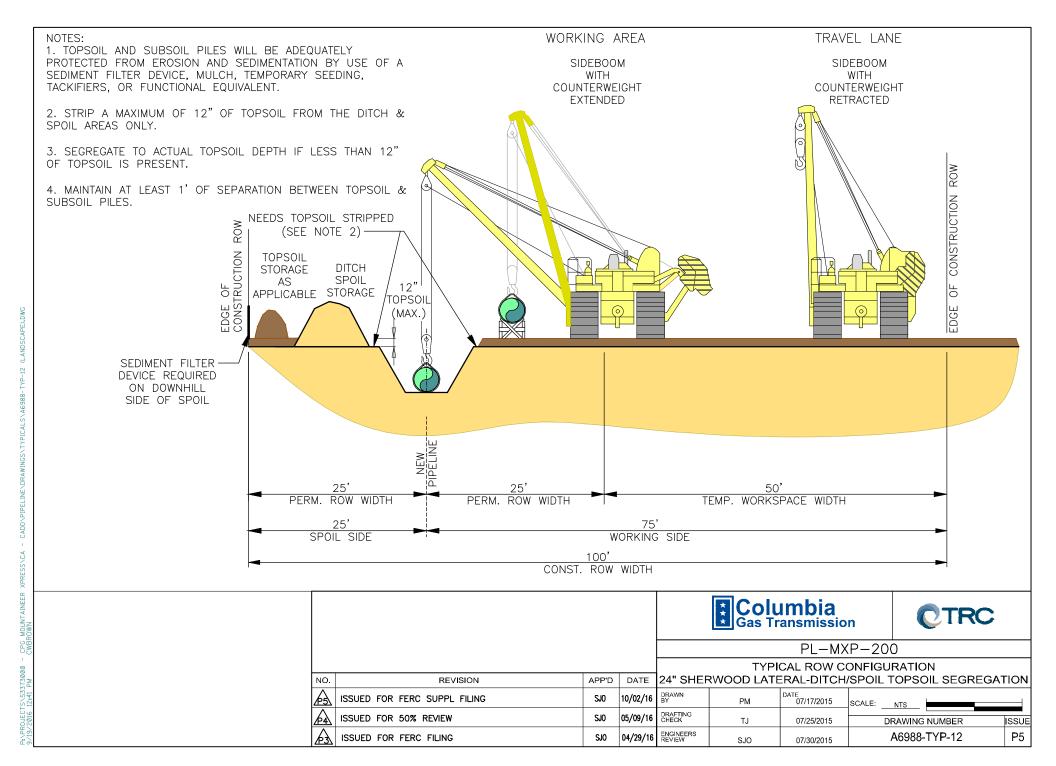


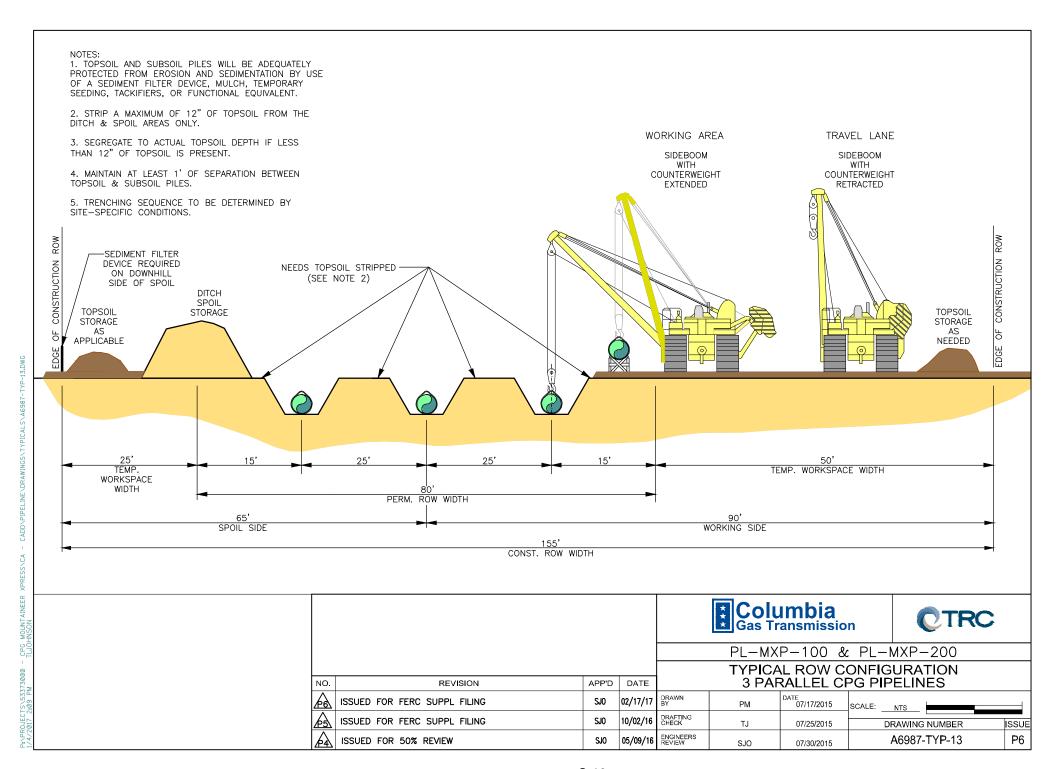

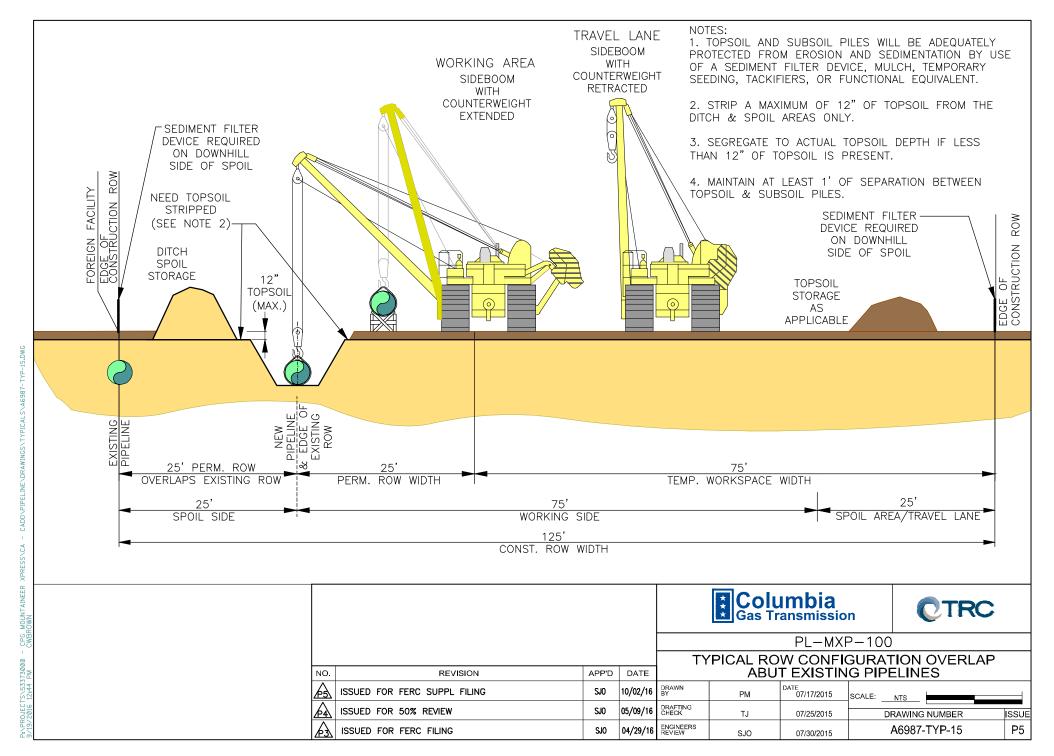

- 1. INSTALL SEDIMENT CONTROLS BASED ON SITE SPECIFIC CONDITIONS.
- 2. LIMIT CLEARING BETWEEN ENTRANCE AND EXIT FOR HAND PLACEMENT OF HDD TRACKING WIRES.

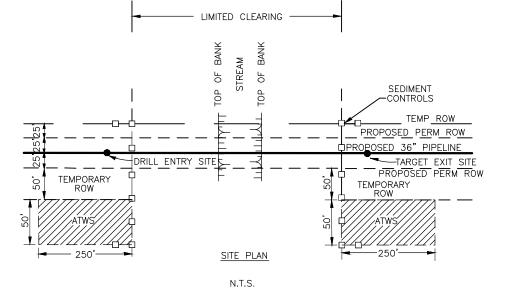

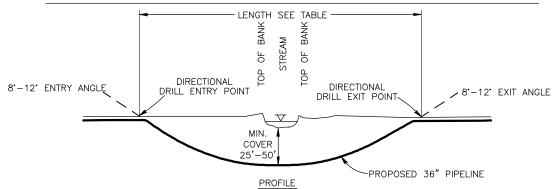

RIVER/CREEK	MP	LENGTH	RADIUS
1. KANAWHA	142.5	1800'	3600'

					Colu Gas Tr	ımbia ^{ansmissio}	n	CTR	
						PL-MXF	⁻ 100)	
				1		L WORKS			
NO.	REVISION	APP'D	DATE		FOF	R DIRECTI	<u>ONAL</u>	DRILL	
Æ	ISSUED FOR FERC SUPPL FILING	SJ0	10/02/16	DRAWN BY	PM	DATE 07/17/2015	SCALE:	NTS	
PA	ISSUED FOR 50% REVIEW	SJ0	05/09/16	DRAFTING CHECK	TJ	07/25/2015	D	PRAWING NUMBER	ISSUE
A	ISSUED FOR FERC FILING	SJ0	04/29/16	ENGINEERS REVIEW	SJO	07/30/2015		A6987-TYP-16	P5






PL-MXP-100 & PL-MXP-200

TYPICAL PIPELINE
CONSTRUCTION SEQUENCE


NO.	REVISION	APP'D	DATE
Æ	ISSUED FOR FERC SUPPL FILING	SJ0	10/02/16
A	ISSUED FOR 50% REVIEW	SJ0	05/09/16
F3	ISSUED FOR FERC FILING	SJO	04/29/16

PANPROJECTS/53373000 - CPG MOUNTAINEER XPRESS\CA - CADD\PIPELINE\DRAWINGS\TYPICALS\A6987-TYP-I7.DWG 9/19/2016 1746 PM CWRROIMN


	CONS	TRUCTIO	IN SEQUENCE
DRAWN BY	PM	DATE 07/17/2015	SCALE: NTS
DRAFTING CHECK	TJ	09/21/2015	DRAWING NUMBER ISSUE
ENGINEERS REVIEW	810	00/22/2015	A6987-TYP-17 P5

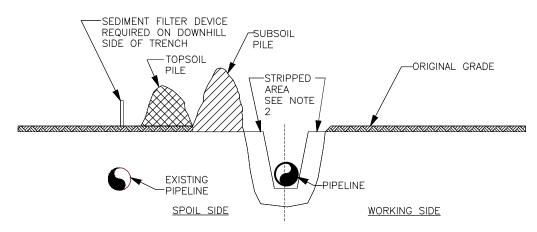

TRENCHLINE AND SPOIL SIDE METHOD

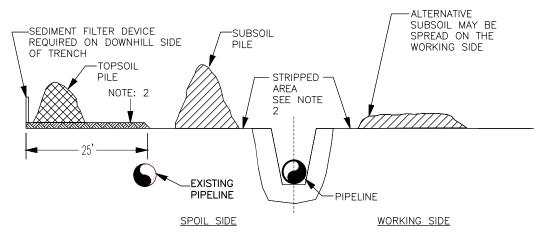

ENTIRE CONSTRUCTION ROW METHOD

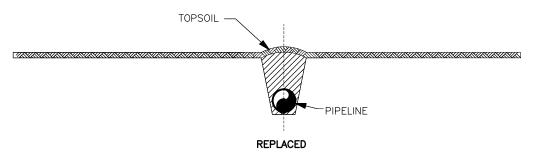

NOTES:

- 1.) OTHER CONFIGURATIONS OF TOPSOIL AND SUBSOIL ARE ACCEPTABLE PROVIDED THEY ARE KEPT SEPARATE.
- 2.) UP TO 12 INCHES OF TOPSOIL REMOVED.
- 3.) TOPSOIL AND SUBSOIL PILES WILL BE ADEQUATELY PROTECTED TO PREVENT EROSION AND SEDIMENTATION BY USE OF SEDIMENT FILTER DEVICES OR MULCH.

* *	Co	um	bia missio	
*	Gas	ı rans	missio	n



ISSUE

P5

PL-MXP-100 & PL-MXP-200

						FIGURE				
Ю.	REVISION	APP'D	DATE	TYPICA	AL TOPSO	IL CONSE	RVAT	ION	RIGHT-	OF-WAY
<u>E</u>	ISSUED FOR FERC SUPPL FILING	SJ0	10/02/16	DRAWN BY	PM	DATE 06/17/2015	SCALE:	NITO		

NO. REVISION APP'D DATE TY

SISUED FOR FERC SUPPL FILING


SID 10/02/16 BW

ISSUED FOR 50% REVIEW


SID 05/09/16 BW


ISSUED FOR FERC FILING

SID 04/29/16 BW

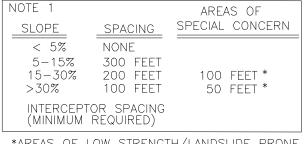

*AREAS OF LOW STRENGTH/LANDSLIDE PRONE SOILS, THE SPACING OF THE INTERCEPTOR DIVERSION SHALL BE ADJUSTED ACCORDINGLY.

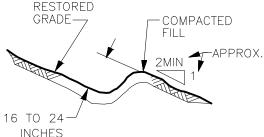

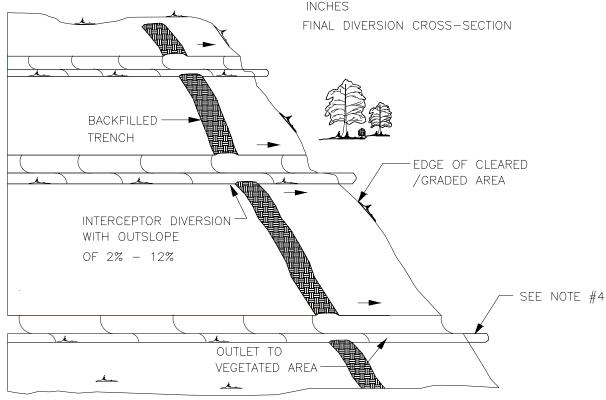

NOTES:

- 1. SPACING USED FOR BOTH TEMPORARY AND FINAL INTERCEPTOR DIVERSIONS.
- 2. TEMPORARY INTERCEPTOR DIVERSIONS WILL BE MAINTAINED DURING THE CONSTRUCTION PHASE UNTIL FINAL INTERCEPTOR DIVERSIONS ARE INSTALLED.
- 3. IF EXISTING GROUND COVER IS SPARSE, SECURE SEDIMENT FILTER DEVICE IN OUTLET.
- 4. THE DIVERSION MAY BE EXTENDED UP TO 5 FEET OFF THE ROW, IF NECESSARY, TO PROVIDE AN ADEQUATE OUTLET.
- 5. DIVERSION OUTLETS WILL ALTERNATE FROM SIDE TO SIDE WHENEVER POSSIBLE.

NOT TO SCALE





PL-MXP-100 & PL-MXP-200

		FIGURE	NO. 6A	
INTE	RCEPTOR	DIVERSION	ONS/SLOPE	BREAKERS

NO.	REVISION	APP'D	DATE	INTE	RCEPTOR	DIVERSION	ONS/SLOPE BREAKERS
Æ	ISSUED FOR FERC SUPPL FILING	SJ0	10/02/16	DRAWN BY	PM	DATE 06/17/2015	SCALE: NTS
A	ISSUED FOR 50% REVIEW	SJ0	05/09/16	DRAFTING CHECK	TJ	07/25/2015	DRAWING NUMBER ISSUE
A	ISSUED FOR FERC FILING	SJ0	04/29/16	ENGINEERS REVIEW	SJO	07/30/2015	A6987-TYP-19 P5

INTERCEPTOR DIVERSIONS ARE THE MOST COMMON AND EFFECTIVE DEVICE USED FOR EROSION CONTROL ON CONSTRUCTION ROW. DURING CONSTRUCTION, TEMPORARY DIVERSIONS ARE INSTALLED TO CONTROL WATER ON THE GRADED ROW. DURING RESTORATION FINAL DIVERSIONS ARE INSTALLED TO PROTECT THE ROW FROM EROSION UNTIL THE VEGETATION RE-ESTABLISHES ON THE DISTURBED AREAS.

TEMPORARY DIVERSIONS ARE GENERALLY MADE BY BUILDING A CURB 8 TO 14 INCHES HIGH ACROSS THE ROW. THE CURBS ARE SHAPED TO ALLOW PASSAGE OF CONSTRUCTION EQUIPMENT AND INSPECTOR VEHICLES. THE DIVERSION SHOULD HAVE A GRADIENT OF 2% -12% AND MUST DRAIN EITHER INTO TRENCH OR OFF THE ROW. WHERE WATER IS DIRECTED OFF THE ROW, THE OUTLET WILL BE PROTECTED BY HEAVY VEGETATION. TEMPORARY DIVERSIONS MAY BE BROKEN DOWN BY CONSTRUCTION EQUIPMENT DURING THE WORKDAY, BUT WILL BE RESTORED BY END OF EACH DAY. TEMPORARY DIVERSIONS WILL BE SPACED ALONG THE ROW IN ACCORDANCE WITH FIGURE 6A. THE ACTUAL NUMBER OF TEMPORARY DIVERSIONS MAY VARY FROM THAT OF FINAL DIVERSIONS BECAUSE THE CONSTRUCTION ROW'S ARTIFICIAL GRADE MAY REDUCE THE SLOPE. POSITION THE OUTFALL OF EACH TEMPORARY SLOPE BREAKER TO PREVENT SEDIMENT DISCHARGE INTO WETLAND, WATERBODIES, OR OTHER SENSITIVE AREAS.

FINAL DIVERSIONS TYPICALLY CONSIST OF A CURB 16 TO 24 INCHES HIGH BELOW A SHALLOW SWALE. THE CURB IS CONSTRUCTED OF COMPACTED EARTH FILL WITH SIDESLOPES OF 2:1 OR FLATTER TO ALLOW PASSAGE OF MAINTENANCE EQUIPMENT. THE DIVERSIONS SHOULD EXTEND ACROSS THE ENTIRE ROW AND DRAIN WATER WITH A 2% TO 12% GRADIENT. THE OUTLETS OF FINAL DIVERSIONS MAY BE STABILIZED WITH SEDIMENT FILTER DEVICES. FINAL DIVERSIONS WILL BE SPACED ALONG THE ROW IN ACCORDANCE WITH FIGURE 6A (OR AS SHOWN ON THE ENVIRONMENTAL CONSTRUCTION DRAWINGS), AND WILL TIE INTO EXISTING DIVERSIONS WHERE PRESENT. IN PLACES WHERE FINAL GRADE CREATES SIDE SLOPES OR SLOPES WHICH BREAK IN MORE THEN ONE DIRECTION, DIVERSION INSTALLATION MAY NEED TO VARY TO CREATE AN OUTSLOPE OF 2% TO 12% WHICH WILL CARRY WATER OFF THE ROW.

ALTERNATIVE DIVERSION CONSTRUCTION MAY BE USED IN AREAS WHERE AN EARTHEN DIVERSION IS IMPRACTICAL





PL-MXP-100 & PL-MXP-200


FIGURE NO. 6B INTERCEPTOR DIVERSIONS

NO.	REVISION	APP'D	DATE	
A	ISSUED FOR FERC SUPPL FILING	SJ0	10/02/16	0
A	ISSUED FOR 50% REVIEW	SJ0	05/09/16	
Æ	ISSUED FOR FERC FILING	SJO	04/29/16	ШЕ


 DRAWN BY
 PM
 DATE 06/17/2015
 SCALE:
 NTS

 DRAFTING CHECK
 TJ
 07/25/2015
 DRAWING NUMBER
 ISSUE

 ENGINEERS REVIEW
 SJO
 07/30/2015
 A6987-TYP-20
 P5

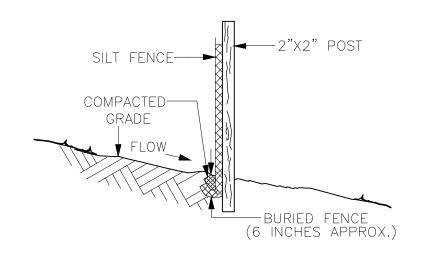


SIDE VIEW

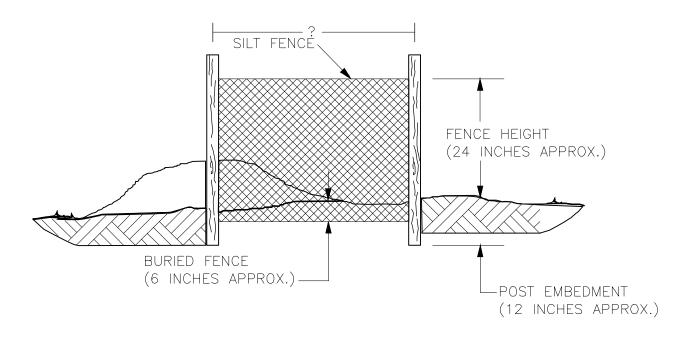

FRONT VIEW

NOTE: SILT FENCE CAN ALSO BE INSTALLED (USING THE SAME SPECIFICATIONS AS PRESENTED ABOVE) IN OTHER SITUATIONS FOR EROSION AND SEDIMENTATION CONTROL.

NOT TO SCALE

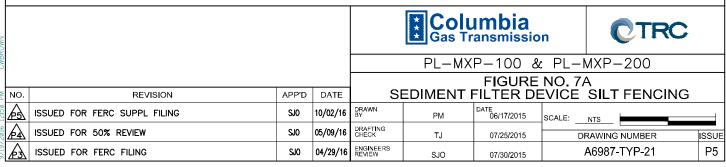

FABRIC PROPERTY	MINIMUM ACCEPTABLE VALUE	TEST METHOD
GRAB TENSILE STRENGTH (LB)	120	ASTM D 1682
ELONGATION AT FAILURE (%)	20% MAX.	ASTM D 1682
MULLEN BURST STRENGTH (PSI)	200	ASTM D 3786
TRAPEZOIDAL TEAR STRENGTH (LB)	50	
PUNCTURE STRENGTH (LB)	40	ASTM D 751 (MODIFIED)
SLURRY FLOW RATE (GAL/MIN/SF)	0.3	ASTM 5141
EQUIVALENT OPENING SIZE	30	US STD. SIEVE CW-02215
ULTRAVIOLET RADIATION STABILITY (%)	80	ATSM G-26

TABLE 4.4

Maximum Slope Length for Silt Fence

	maximum Giopo L	cinguit for one remoc	
	Maximu	m Slope Length (ft) Abov	e Fence
Slope - Percent	Standard (18" High) Silt Fence	Reinforced (30" High) Silt Fence	Super Silt Fence
2 (or less)	150	500	1000
5	100	250	550
10	50	150	325
15	35	100	215
20	25	70	175
25	20	55	135
30	15	45	100
35	15	40	85
40	15	35	75
45	10	30	60
50	10	25	50

Columbia Gas Transmission



PL-MXP-100 & PL-MXP-200


SILT FENCE SPECIFICATIONS TABLE 4.3, TABLE 4.4

Ю.	REVISION	APP'D	DATE	
À	ISSUED FOR FERC SUPPL FILING	SJ0	10/02/16	0
<u> </u>	ISSUED FOR 50% REVIEW	SJ0	05/09/16	
3	ISSUED FOR FERC FILING	SJO	04/29/16	E

 DRAWN BY
 PM
 DATE 06/17/2015
 SCALE:
 NTS

 DRAFTING CHECK
 TJ
 07/25/2015
 DRAWING NUMBER
 ISSUE

 ENGINEERS REVIEW
 SJO
 07/30/2015
 A6987-TYP-22
 P5

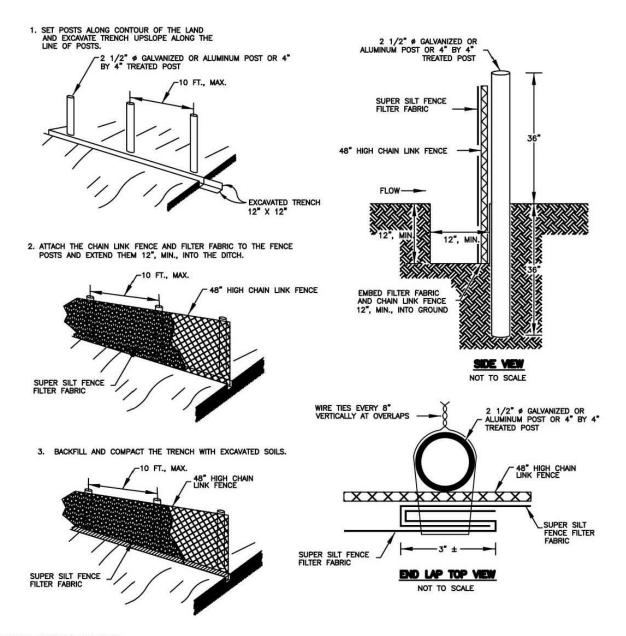

SUPER SILT FENCE NOTES:

- 1. CHAIN LINK FENCE SHALL BE CONSTRUCTED IN ACCORDANCE WITH SECTION 608 OF THE WYDOH SPECIFICATIONS. CHAIN LINK FENCE SHALL BE FASTENED SECURELY TO THE POSTS WITH WIRE TIES OR STAPLES.
- 2. POSTS NEED NOT BE SET IN CONCRETE.
- 3. THE FILTER FABRIC SHALL BE FASTENED TO THE CHAIN LINK FENCE WITH TIES EVERY 24" AT THE TOP AND MID SECTION.
- 4. FABRIC AND FENCE SHALL BE EMBEDDED 12", MINIMUM, INTO THE GROUND.
- 5. A 6", MINIMUM, OVERLAP SHALL BE PROVIDED WHERE TWO SECTIONS OF FABRIC ADJOIN. THE OVERLAPPED FABRIC SHALL BE FOLDED TOGETHER AND ATTACHED TO THE CHAIN LINK FENCE.
- 6. 4" BY 4" PRESSURE TREATED POSTS MAY BE SUBSTITUTED FOR METAL FENCE POSTS WITH THE APPROVAL OF THE ENGINEER.
- 7. THE LENGTH OF SLOPE ABOVE THE FENCE SHALL NOT EXCEED 400 FEET IN STEEP TERRAIN. IN FLATTER AREAS THE LENGTH CAN BE EXTENDED WITH THE APPROVAL OF THE ENGINEER.

NOT TO SCALE






PL-MXP-100 & PL-MXP-200

FIGURE NO. 7B SEDIMENT FILTER DEVICE

₹ NO.	REVISION	APP'D	DATE		5	SUPER SIL	T FENCE
<u> </u>	ISSUED FOR FERC SUPPL FILING	SJ0	10/02/16	DRAWN BY	PM	DATE 06/17/2015	SCALE: NTS
§ 🕰	ISSUED FOR 50% REVIEW	SJ0	05/09/16	DRAFTING CHECK	TJ	07/25/2015	DRAWING NUMBER ISSUE
<u>}</u>	ISSUED FOR FERC FILING	SJO	04/29/16	ENGINEERS REVIEW	SJO	07/30/2015	A6987-TYP-23 P5

Æ

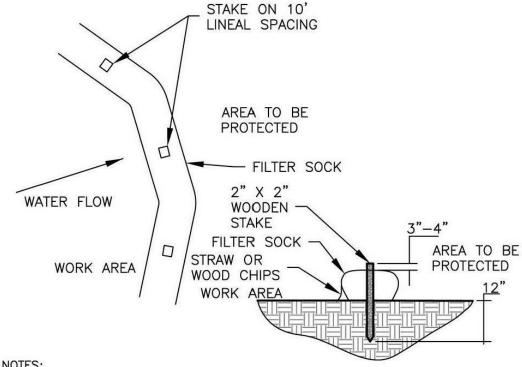

NOTES:

- 1. COMPOST FILTER SOCK TO BE FILTREXX SILTSOXX OR APPROVED EQUIVALENT.
- 2. 8", 12" 18" AND 24" COMPOST FILTER SOCK TO BE USED. SEE PLAN SHEET FOR SIZES AND LOCATIONS.
- 3. ACCUMULATED SEDIMENT SHALL BE REMOVED AND DISPOSED OF WHEN IT REACHES 1/2 THE ABOVE GROUND HEIGHT OF THE COMPOST FILTER SOCK.
- 4. COMPOST FILTER SOCK SHALL BE INSPECTED WEEKLY AND AFTER EACH RUNOFF EVENT. DAMAGED COMPOST FILTER SOCK SHALL BE REPAIRED ACCORDING TO MANUFACTURER'S SPECIFICATIONS.

FILTER SOCK SIZING CHART

SLOPE	8 IN (200 mm) SiltSoxx™	12 IN (300 mm) SiltSoxx™	18 IN (450 mm) SiltSoxx™	24 IN (600 mm) SiltSoxx™	32 IN (800 mm) SiltSoxx™
PERCENT	6.5 IN (160 mm)**	9.5 IN (240 mm)**	14.5 IN (360 mm)**	19 IN (480 mm)**	26 IN (650 mm)**
2 (OR LESS)	600 (180)	750 (225)	1000 (300)	1300 (400)	1650 (500)
5	400 (120)	500 (150)	550 (165)	650 (200)	750 (225)
10	200 (120)	250 (75)	300 (90)	400 (120)	500 (150)
15	140 (40)	170 (50)	200 (60)	325 (100)	450 (140)
20	100 (30)	125 (38)	140 (42)	260 (80)	400 (120)
25	80 (24)	100 (30)	110 (33)	200 (60)	275 (85)
30	60 (18)	75 (23)	90 (27)	130 (40)	200 (60)
35	60 (18)	75 (23)	80 (24)	115 (35)	150 (45)
40	60 (18)	75 (23)	80 (24)	100 (30)	125 (38)
45	40 (12)	50 (15)	60 (18)	80 (24)	100 (30)
50	40 (12)	50 (15)	55 (17)	65 (20)	75 (23)

- BASED ON FAILURE POINT OF 36 IN (0.9 m) SUPER SILT FENCE (WIRE REINFORCED) AT 1000 FT. (303 m) OF SLOPE, WATERSHED WIDTH EQUIVALENT TO RECEIVING LENGTH OF SEDIMENT CONTROL DEVICE, 1 IN/24 hr(25 mm/24 hr) RAIN EVENT.
- ** EFFECTIVE HEIGHT OF SIItSoxx MAFTER INSTALLATION AND WITH CONSTANT HEAD FROM RUNOFF AS DETERMINED BY OHIO STATE UNIVERSITY.


Columbia **Gas Transmission**



NTS

FIGURE NO. 25
TYPICAL COMPOST FILTER SOCK

NO.	REVISION	APP'D	DATE		TYPICAL	- COMPO	ST FILTER SOCK	
臽	ISSUED FOR FERC SUPPL FILING	SJ0	10/02/16	DRAWN BY	PM	DATE 06/17/2015	SCALE: NTS	l
<u> </u>	ISSUED FOR 50% REVIEW	SJ0	05/09/16	DRAFTING CHECK	TJ	07/25/2015	DRAWING NUMBER ISSUE	
A3	ISSUED FOR FERC FILING	SJO	04/29/16	ENGINEERS REVIEW	SJO	07/30/2015	A6987-TYP-24 P5	

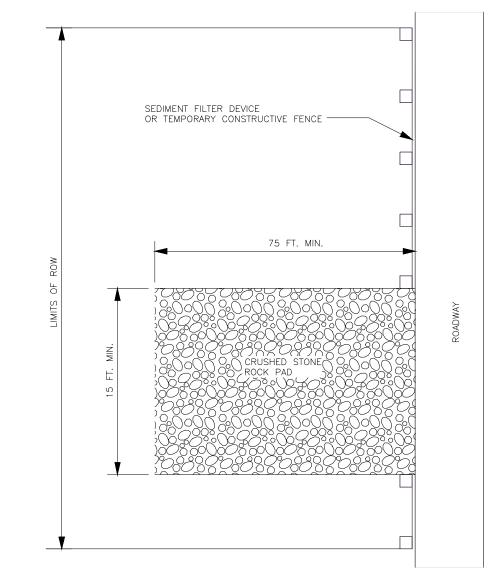

NOTES: 1. CRUSHED STONE SIZE WILL BE WASHED NUMBER 1 COARSE AGGREGATE OR EQUIV. (4 INCH DIAMETER MINIMUM.)

- 2. ROCK PAD WILL BE AT LEAST 6 INCHES THICK.
- 3. THE ROAD ENTRANCE WILL HAVE A GEOTEXTILE FABRIC BENEATH THE ROCK PAD.
- 4. IF ROCK PAD BECOMES COVERED WITH MUD SO AS TO BECOME INEFFECTIVE, ADDITIONAL STONE WILL BE ADDED.
- 5. ALL STONE AND FABRIC MUST BE REMOVED DURING ROW RESTORATION.
- 6. THE ROCK PAD MAY BE ENLARGED TO INCLUDE A TURNING RADIUS (RADIUS NOT TO EXTEND PAST TEMPORARY WORKSPACE).
- 7. INSTALL CULVERT AT ROADWAYS IN ACCORDANCE WITH PERMIT CONDITIONS.

NOT TO SCALE

ISSUE

P6






ΓE	TEN	MPORARY	ROAD EN	TRANCE ROCK PADS
			FIGURE	: NO. 8


AM	NO.	REVISION	APP'D	DATE	l len	MPORARY	ROAD EN	HRA	NCE RC	OCK P
11201	A	ISSUED FOR FERC SUPPL FILING	SJ0	02/17/17	DRAWN BY	PM	DATE 06/17/2015	SCALE:	NTS =	
1007	A	ISSUED FOR FERC SUPPL FILING	SJ0	10/02/16	DRAFTING CHECK	TJ	07/25/2015		DRAWING N	UMBER
100/1	A	ISSUED FOR 50% REVIEW	SJO	05/09/16	ENGINEERS REVIEW	SJO	07/30/2015		A6987-T	YP-25

NO

ISSUED FOR FERC FILING

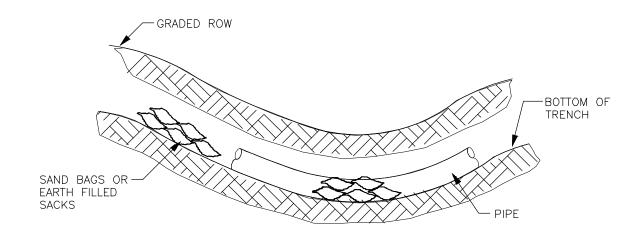

SIDE VIEW

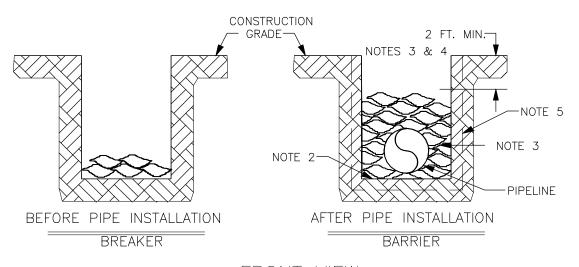

FRONT VIEW

- NOTES: 1. INSTALL AT EVERY SECOND INTERCEPTOR DIVERSION PROMPTLY AS TRENCH IS COMPLETED.(SEE FIGURE 6A)
 - 2. PRIOR TO LOWERING IN, REMOVE ALL DECOMPOSED MATERIAL AND ROCKS.
 - 3. INSTALL SACKS TO TOP OF TRENCH ON STEEP GRADES THAT ARE NOT USED FOR FARMING.
 - 4. TOP OF TRENCHLINE BARRIER WILL BE BELOW PLOW DEPTH IN AGRICULTURAL LAND.
 - 5. SANDBAGS WILL BE KEYED INTO SIDE OF DITCH.

NOT TO SCALE

P5



SJO




A6987-TYP-26

PL-MXP-100 & PL-MXP-200

07/30/2015


						FIGURE	NO.	10		
ο.	REVISION	APP'D	DATE	TI	RENCHLIN	IE BARRIE	RS A	ND BF	REAKERS	
5	ISSUED FOR FERC SUPPL FILING	SJ0	10/02/16	DRAWN BY	PM	DATE 06/17/2015	SCALE:	NTS		
$\overline{\mathbf{A}}$	ISSUED FOR 50% REVIEW	SJ0	05/09/16	DRAFTING CHECK	TJ	07/25/2015		DRAWING	NUMBER	


04/29/16 ENGINEERS C-26

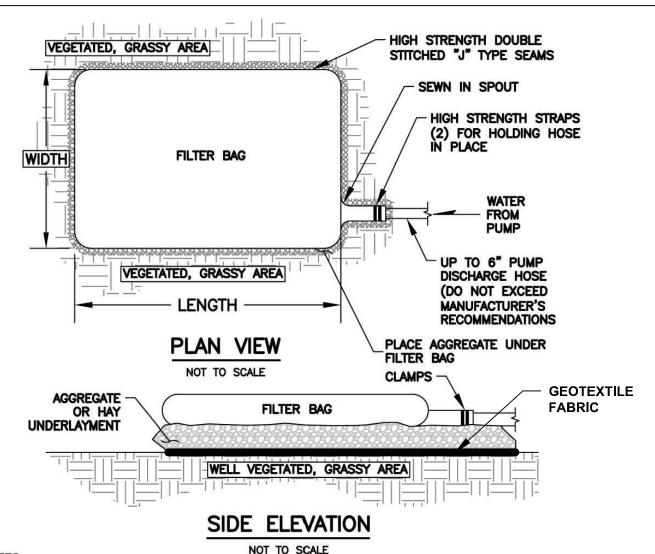

- FILTER BAGS SHALL BE MADE FROM NON-WOVEN GEOTEXTILE MATERIAL SEWN WITH HIGH STRENGTH, DOUBLE STITCHED "J" TYPE SEAMS. THEY SHALL BE CAPABLE OF TRAPPING PARTICLES LARGER THAN 150 MICRONS.
- BAGS MUST BE PLACED WITHIN THE PERMITTED AREA IF ACCESSING THE BAG WITH MACHINERY IS
 REQUIRED FOR DISPOSAL PURPOSES. FILTER BAGS SHALL BE REPLACED WHEN THEY BECOME 1/2 FULL
 OF SEDIMENT. SPARE BAGS SHALL BE KEPT AVAILABLE FOR REPLACEMENT OF THOSE THAT HAVE FAILED
 OR ARE FILLED.
- 3. BAGS SHOULD BE LOCATED IN WELL—VEGETATED (GRASSY) AREAS, AND DISCHARGE ONTO STABLE, EROSION RESISTANT AREAS. WHERE THIS IS NOT POSSIBLE, A GEOTEXTILE FLOW PATH CAN BE PROVIDED OR ALLOW DISCHARGE FROM BAG TO FLOW THROUGH A SERIES OF SEDIMENT LOGS ETC.... BAGS CAN BE USED INSIDE SEDIMENT TRAPS.
- 4. BAGS SHALL NOT BE PLACED ON SLOPES GREATER THAN 5%.
- 5. THE PUMP DISCHARGE HOSE SHALL BE INSERTED INTO THE BAGS IN THE MANNER SPECIFIED BY THE MANUFACTURER AND SECURELY CLAMPED. DO NOT ALTER OR CUT BAGS.
- 6. AGGREGATE OR HAY SHALL BE PLACED UNDERNEATH FILTER BAGS.
- 7. SEDIMENT FILTER DEVICE (COMPOST FILTER SOCK, HAY BALE OR APPROVED EQUIVALENT) SHALL BE PLACED WHERE WARRANTED OR AS DETERMINED BY THE EI.

NOT TO SCALE

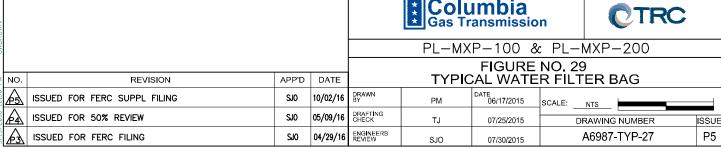

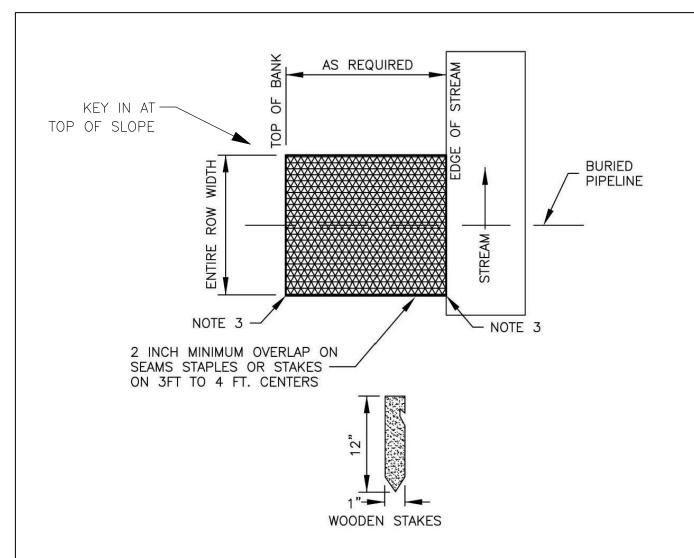

- 1. INSTALL JUTE NETTING DURING RESTORATION.
- 2. SEED AND MULCH AREA TO BE JUTE NETTED.
- 3. TRENCH IN AND BURY UPHILL AND UPSTREAM EDGE OF JUTE NETTING.
- 4. AN INTERCEPTOR DIVERSION WILL BE INSTALLED IMMEDIATELY ABOVE JUTE NETTING ON SLOPED BANKS.
- 5. ON SHORT BANKS (LESS THAN 10'), JUTE NETTING CAN BE PERPENDICULAR TO BANK SLOPE.
- 6. INSTALL ON STEEP SLOPES OR ON THE BANKS OF FLOWING STREAMS, OR IN UPLAND AREAS.

NHO)					Gas Tr	ansmissio	n		TR	
S S					PL-MX	P-100 &	: PL-	-MXP-	-200	
						FIGURE	NO. 1	12A		
NO.	REVISION	APP'D	DATE		EROS	ION CONT	ROL	BLAN	KET	
A	ISSUED FOR FERC SUPPL FILING	SJO	10/02/16	DRAWN BY	PM	DATE 06/1 7/ 2015	SCALE:	NTS		
A	ISSUED FOR 50% REVIEW	SJ0	05/09/16	DRAFTING CHECK	TJ	0725/2015		DRAWING	NUMBER	ISSUE
A	ISSUED FOR FERC FILING	SJO	04/29/16	ENGINEERS REVIEW	SJO	07/30/2015		A6987-	TYP-28	P5

E Columbia

STICKS. MAT MUST BE PLACED FLAT ON SURFACE FOR PROPER SOIL CONTACT.


NOT TO SCALE





FIGURE NO. 12B
ROLLED EROSION CONTROL PRODUCTS

NO.	REVISION	APP'D	DATE	ROLLED EROSION CONTROL PRODUCTS					
A	ISSUED FOR FERC SUPPL FILING	SJO	10/02/16	DRAWN BY	РМ	DATE 06/17/2015	SCALE: NTS		
A	ISSUED FOR 50% REVIEW	SJO	05/09/16	DRAFTING CHECK	TJ	07/25/2015	DRAWING NUMBER ISSU		
A	ISSUED FOR FERC FILING	SJ0	04/29/16	ENGINEERS REVIEW	SJO	07/30/2015	A6987-TYP-29 P5		

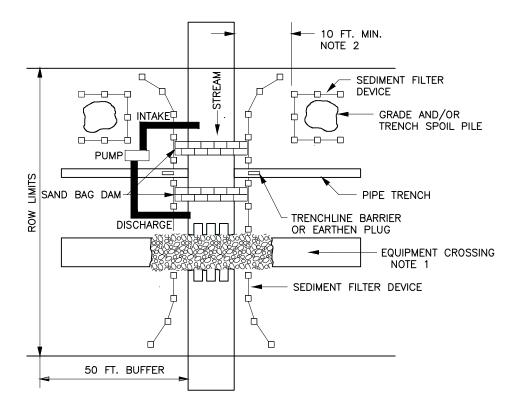

NOTES: 1. EQUIPMENT CROSSINGS ARE TO BE INSTALLED AS ILLUSTRATED IN FIGURES 17 OR 18.


- 2. GRADE AND TRENCH SPOIL WILL BE STOCKPILED AT LEAST 10 FEET FROM THE WATERS' EDGE OR TOP OF BANK, TOPOGRAPHY PERMITTING
- 3. PUMP INTAKES WILL BE SCREENED, PREVENT STREAMBED SCOUR AT DISCHARGE
- 4. SUFFICIENT PUMP CAPACITY WILL BE USED TO MAINTAIN STREAM FLOW AT ALL TIMES UNTIL BACKFILL AND REMOVAL OF SANDBAG DAM.
- 5. BACKUP PUMPS (AS SAME NUMBER AND CAPACITY AS ACTIVE PUMPS) WILL BE READILY AVAILABLE IN WORKING CONDITION ON SITE AT CROSSING.
- 6. CONSTRUCT DAMS WITH MATERIAL THAT PREVENT SEDIMENT AND OTHER POLLUTANTS FROM ENTERING THE WATERBODY.
- 7. MONITOR THE DAM AND PUMPS TO ENSURE PROPER OPERATIONS THROUGHOUT THE WATERBODY CROSSING.
- 8. SECONDARY CONTAINMENT FOR PUMP.
- 9. COMPLETE STREAMBED AND BANK STABILIZATION BEFORE RETURNING FLOW TO THE WATERBODY CHANNEL.

Columbia


Gas Transmission

NOT TO SCALE

CTRC

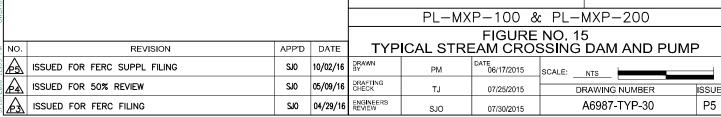

ISSUED FOR FERC FILING

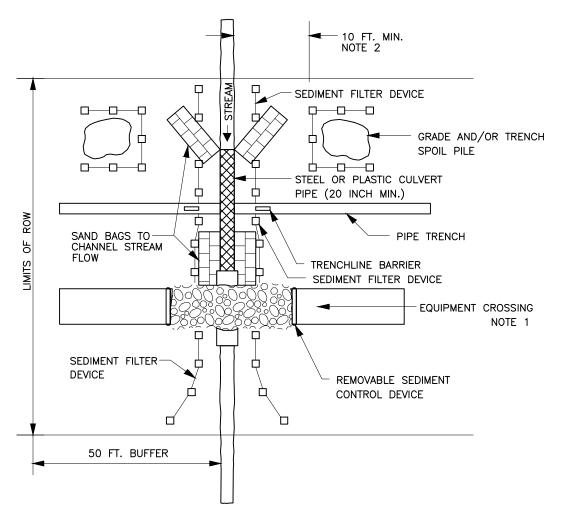

NOTES: 1. EQUIPMENT CROSSINGS ARE TO BE PREPARED AS ILLUSTRATED IN FIGURES 17 & 18.


- 2. GRADE AND TRENCH SPOIL WILL BE STOCKPILED AT LEAST 10 FEET FROM THE WATER'S EDGE.
- 3. INSTALL FLUME PIPE AFTER BLASTING (IF NECESSARY), BUT BEFORE TRENCHING.
- 4. PROPERLY ALIGN FLUME PIPE(S) TO PREVENT BANK EROSION OR STREAM BED SCOUR.
- 5. COMPLETE STREAMBED AND BANK STABILIZATION
 BEFORE RETURNING FLOW TO THE WATERBODY CHANNEL.

04/29/16

NOT TO SCALE

P5


A6987-TYP-31

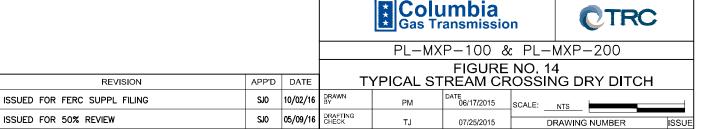

SJO

07/30/2015

ISSUED FOR FERC FILING

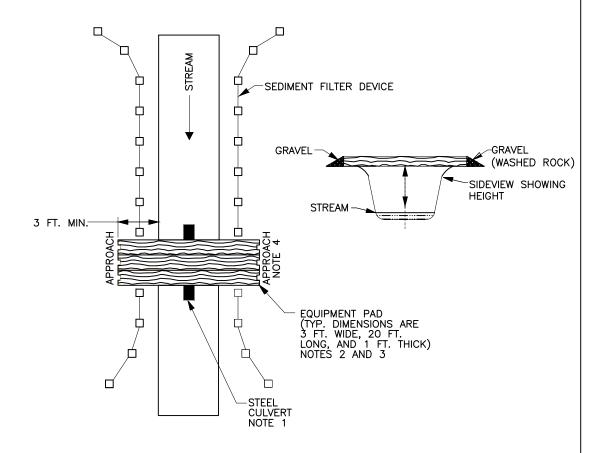

NOTES: 1. CULVERT PIPE UTILIZED IF ADDITIONAL SUPPORT IS REQUIRED.

- 2. ADDITIONAL PADS CAN BE PUT SIDE BY SIDE IF EXTRA WIDTH IS REQUIRED.
- EQUIPMENT PAD TYPICALLY CONSTRUCTED OF HARD— WOOD; MUST ACCOMMODATE THE LARGEST EQUIPMENT USED.
- 4. RAMP APPROACHES CAN EITHER BE GRADED OR DUG INTO GROUND. IF NECESSARY, WASHED, CRUSHED STONE WILL BE USED TO RAMP UP TO THE EQUIPMENT PADS.
- 5. MINIMUM CULVERT DIAMETER 20 INCHES.
- 6. MAINTAIN PADS SO AS NOT TO ALLOW MUD TO ENTER THE STREAM.
- 7. EQUIPMENT CANNOT INTERFERE WITH STREAM FLOW.

NOT TO SCALE

P5



SJO




A6987-TYP-32

PL-MXP-100 & PL-MXP-200

07/30/2015

				FIGURE NO. 18						
NO.	REVISION	APP'D	DATE	TEMP.	EQUIPMEN	IT CROSS	ING V	V/ EQU	IPMENT P.	ADS
A	ISSUED FOR FERC SUPPL FILING	SJ0	10/02/16	DRAWN BY	РМ	DATE 06/17/2015	SCALE:	NTS 🕨		
A	ISSUED FOR 50% REVIEW	SJ0	05/09/16	DRAFTING CHECK	TJ	07/25/2015		DRAWING N	IUMBER	ISSUE

04/29/16 ENGINEERS REVIEW

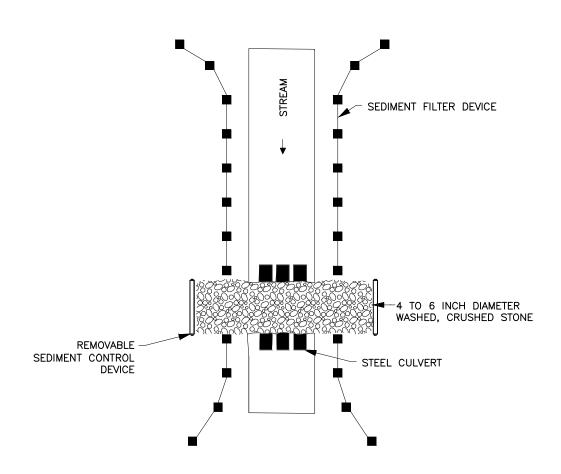

NOTES: 1. MINIMUM CONTOURING OF THE BOTTOM NECESSARY TO LAY THE CULVERTS LEVEL MAY BE DONE.

- 2. USE AS MANY CULVERTS AS REQUIRED TO SPAN ENTIRE STREAM BED. (CULVERTS SHALL BE PLACED SIDE BY SIDE.)
- 3. MINIMUM CULVERT DIAMETER 20 INCHES.
- 4. MAINTAIN ROCK SO AS NOT TO ALLOW MUD TO ENTER THE STREAM.
- 5. ALIGN CULVERTS TO PREVENT BANK EROSION.

NOT TO SCALE





PL-MXP-100 & PL-MXP-200

FIGURE NO. 17 TEMPORARY EQUIPMENT CROSSING W/ CULVERT AND STONE


NO	D. REVISION	APP'D	DATE	CROSSING W/ CULVERT AND STONE					
Æ	ISSUED FOR FERC SUPPL FILING	SJ0	10/02/16	DRAWN BY	PM	DATE 06/17/2015	SCALE: NTS		
Į.	SSUED FOR 50% REVIEW	SJO	05/09/16	DRAFTING CHECK	TJ	07/25/2015	DRAWING	NUMBER	ISSUE
Æ	ISSUED FOR FERC FILING	SJO	04/29/16	ENGINEERS REVIEW	SJO	07/30/2015	A6987-	-TYP-33	P5


- CADD\PIPELINE\DRAWINGS\TYPICALS\A6987-TYP-34.DWG

MOUNTAINEER XPRESS\CA

- 1. EQUIPMENT CROSSINGS ARE TO BE PREPARED AS ILLUSTRATED IN FIGURES 17 & 18.
- 2. GRADE AND TRENCH SPOIL WILL BE STOCKPILED AT LEAST 10 FEET FROM THE WATERS EDGE, TOPOGRAPHY PERMITTING.
- 3. SAND BAGS OR GRAVEL FILLED SACKS WILL BE PLACED AT UPSTREAM END OF CULVERT TO CHANNEL FLOW.


NOT TO SCALE

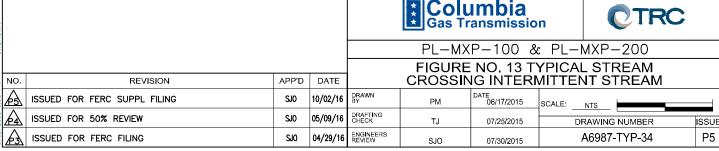


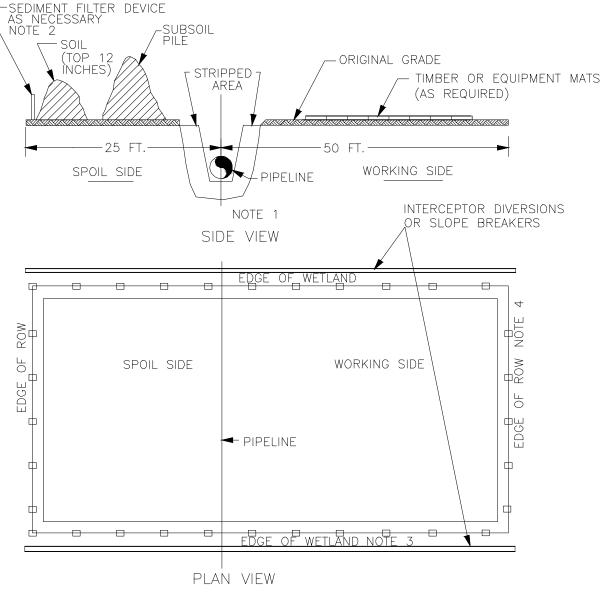

- 1. FOR WETLAND CROSSINGS WITHOUT STANDING WATER OR SATURATED SOILS, UPLAND CONSTRUCTION TECHNIQUES CAN BE USED. IF STANDING WATER OR SATURATED SOILS BECOME PRESENT DURING CONSTRUCTION ACTIVITIES IN WETLANDS THAT WERE INITIALLY DRY, OPERATE PER REQUIRERMENTS IN SECTION III.B.2 OF THIS ECS (SEE NOTE 2).
- 2. WETLANDS WITH STANDING WATER, SATURATED OR FROZEN SOIL, OPERATE EQUIPMENT PER REQUIREMENTS IN SECTION III.B.2. (ECS)
- 3. IN WETLAND AREAS WHICH CONTAIN NO STANDING WATER OR IF SOILS ARE SATURATED OR FROZEN, TOPSOIL (TOP 12 INCHES) AND SUBSOIL WILL BE STOCKPILED SEPARATELY WITHIN THE WETLAND CONSTRUCTION ROW.
- 4. A SEDIMENT FILTER DEVICE WILL BE PLACED ACROSS THE ROW AT THE WETLAND'S EDGE, IMMEDIATELY UPSLOPE OF THE WETLAND BOUNDARY.
- 5. A SEDIMENT FILTER DEVICE WILL BE PLACED AT THE EDGE OF THE ROW AND AROUND SOIL AND SUBSOIL PILES AS NECESSARY.


NOT TO SCALE

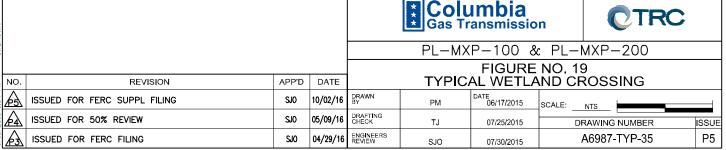

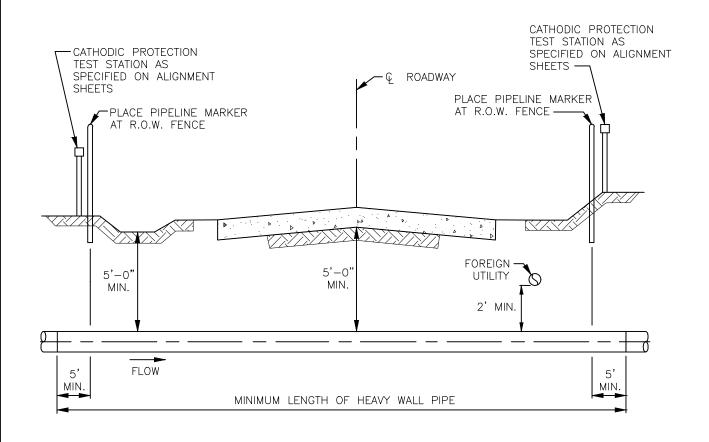

- 1. CONTRACTOR SHALL INSTALL THE HEAVY WALL STEEL PIPE, BACKFILL AND REPLACE ROAD SURFACE IN ACCORDANCE WITH PERMIT ISSUED BY THE GOVERNMENT BODY HAVING JURISDICTION AND/OR IN ACCORDANCE WITH THE SPECIFICATIONS, WHICHEVER IS THE MOST STRINGENT.
- 2. THE PIPELINE SHALL CROSS AS NEAR TO RIGHT ANGLE AS POSSIBLE AND ECONOMICALLY PRACTICAL.
- 3. THE HEAVY WALL STEEL PIPE SHALL BE INSTALLED TO EXTEND A MINIMUM OF 5 FEET BEYOND THE R.O.W. LIMITS ON EACH SIDE OF ROAD.
- 4. THE HEAVY WALL STEEL PIPE WITHIN THE RIGHT-OF-WAY LIMITS SHALL BE FULLY EXTENDED DURING INSTALLATION.
- 5. ANY OPEN CUT TRENCH SHALL BE IN ACCORDANCE WITH STATE OR COUNTY SPECIFICATIONS AS DEFINED IN THE SPECIFICATION AND STANDARD.
- 6. AS REQUIRED, USE APPROVED CPG/WVDOH FLOWABLE FILL SPECIFICATION FOR BACKFILL MATERIAL ABOVE THE PIPE. SEE TYPICAL DETAIL A6987-TYP-54.
- 7. REPLACE SUB-GRADE AND ROAD SURFACE MATERIAL WITH EQUAL OR GREATER THICKNESS AND WITH EQUAL OR GREATER MATERIAL AND SPECIFICATIONS TO PROVIDE A SMOOTH AND CONTINUOUS ROAD SURFACE.

NOONII						Colu Gas Tr	ımbia _{ansmissio}	n	CTRC	•
AND THE PROPERTY OF THE PROPER				·	PL-MX	P-100 &	: PL-N	MXP-200		
				TYPICAL						
1	10.	REVISION	APP'D	DATE			OPEN CU	T ROA	'D	
	<u></u>	ISSUED FOR FERC SUPPL FILING	SJO	02/17/17	DRAWN BY	PM	DATE 06/17/2015	SCALE:	NTS	
	<u></u>	ISSUED FOR FERC SUPPL FILING	SJ0	10/02/16	DRAFTING CHECK	TJ	07/25/2015			ISSUE
		ISSUED FOR 50% REVIEW	SJO	05/09/16	ENGINEERS REVIEW	SJO	07/30/2015	/	A6987-TYP-36	P6

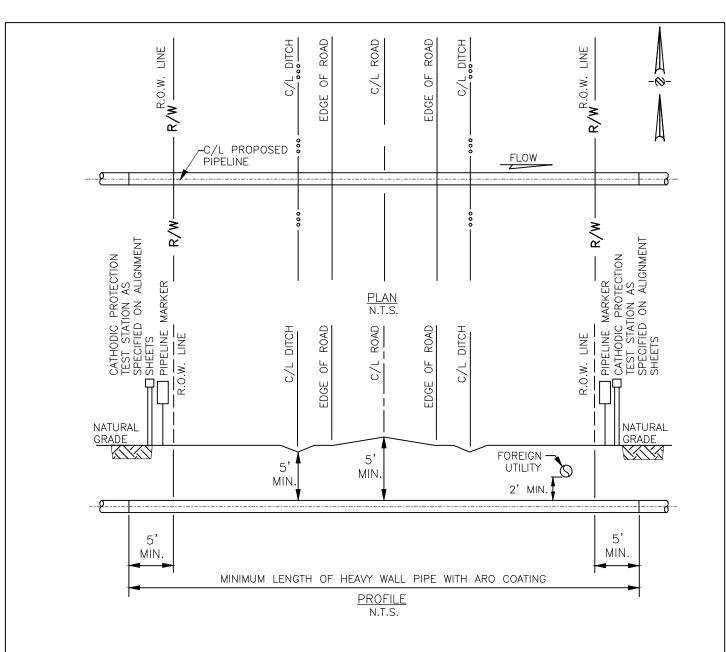

- 1. NO BENDS IN THE R.O.W.
- 2. PIPELINE CROSSINGS SHALL BE AS NEAR TO PERPENDICULAR TO THE ROADWAY CENTERLINE AS PRACTICAL.
- 3. MUST BE CATHODICALLY PROTECTED
 - (ENTIRE PIPELINE).
- 4. WELDED JOINTS INSIDE R.O.W. SHALL BE 100% X-RAYED FOR WELD QUALITY.
- 5. MARKERS SHALL BE PLACED AT OR NEAR THE R.O.W. LINE.

					Colu Gas Tr	ımbia _{ansmissio}	n	C TF	SC
					PL-MX	P-100 &	: PL-	-MXP-200	
				TYPICAL					
NO.	REVISION	APP'D	DATE		BOF	RED ROAD	CRC	DSSING	
A	ISSUED FOR FERC SUPPL FILING	SJ0	02/17/17	DRAWN BY	РМ	DATE 06/1 7/ 2015	SCALE:	NTS	
A	ISSUED FOR FERC SUPPL FILING	SJO	10/02/16	DRAFTING CHECK	TJ	09/23/2015	_	DRAWING NUMBER	ISSUE
	ISSUED FOR 50% REVIEW	SJO	05/09/16	ENGINEERS REVIEW	SJO	09/23/2015		A6987-TYP-37	P6

TABLE 2A - PERMANENT SEED MIX FOR U	PLAND ROW AND WATERBODY CROSSINGS
TYPE	RATE (lbs./ACRE)
SEED¹	
ORCHARD GRASS AND/OR TALL FESCUE 2	29
BIRDSFOOT TREFOIL (EMPIRE) 3	9
ANNUAL RYE	12
FERTILIZER	
10-10-10 (OR EQUIVALENT)	600 ⁴ (SHOULD NOT BE APPLIED ON STREAM BANKS)
MULCH	
HAY OR STRAW	4,000
AGRICULTURAL LIME	4,000

¹PURE LIVE SEED WITHIN 12 MONTHS OF TESTING

⁵SEED RATE MUST BE DOUBLED FOR BROADCAST SEEDING.

TABLE 2B - SEED MIX FOR TEMPORARY S	STABILIZATION
TYPE	RATE (lbs./ACRE)
SEED	
ANNUAL RYE	40
MULCH	
HAY OR STRAW	6,000

TABLE 2C - SEED MIX REQUIREMENTS IN	WETLANDS (FOR STANDING WATER)
TYPE	RATE (lbs./ACRES)
SEED	
ANNUAL RYE	40

¹ANNUAL RYE IS USED AS TEMPORARY RE-VEGETATIVE MEASURE UNTIL INDIGENOUS PLANTS RE-ESTABLISH COVER. A MONITORING PROGRAM WILL BE IN EFFECT TO INSURE ADEQUATE COVER IS ESTABLISHED.





PL-MXP-100 & PL-MXP-200

10.	REVISION	APP'D	DATE		
<u>\$</u>	ISSUED FOR FERC SUPPL FILING	SJ0	10/02/16	DRAWN BY	
<u> </u>	ISSUED FOR 50% REVIEW	SJO	05/09/16	DRAFTING CHECK	

ISSUED FOR FERC FILING

PF	ROJECT	 ES EED	MIXI	ΞS
	DATE			


DRAWN BY	PM	06/17/2015	SCALE:	NTS		_
DRAFTING CHECK	TJ	0725/2015		DRAWING	NUMBER	ISSUE
ENGINEERS REVIEW	SJO	07/30/2015		A6987	-TYP-38	P5

04/29/16

²IF TALL FESCUE IS USED, PLANT ENDOPHYTE-FREE CERTIFIED SEED

³LEGUMES TO BE INOCULATED BY MANUFACTURER'S RECOMMENDATIONS, IF NOT AVAILABLE LEGUMES ARE TO BE INOCULATED AT 4 TIMES RECOMMENDED RATE FOR CONVENTIONAL METHODS AND 10 TIMES RECOMMENDED RATE FOR HYDRO SEEDING.

⁴WHERE WOOD CHIPS ARE SPREAD, ADDITIONAL NITROGEN (12 TO 15 lbs./TON OF CHIPS) WILL BE SPREAD.

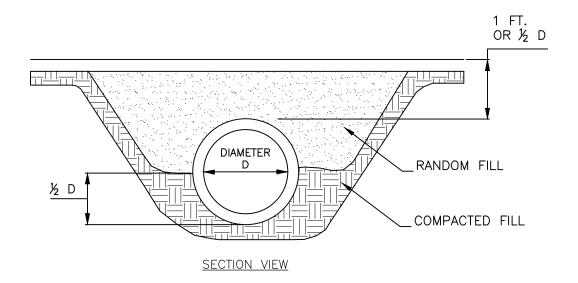

MINIMUM DIAMETER FOR ANY CULVERT IS 12"; OTHERWISE CULVERT SHALL BE SIZED FOR ANTICIPATED PEAK FLOW. PLACE CULVERT SO BOTTOM IS AT SAME LEVEL AS BOTTOM OF DITCH OR ADJOINING SLOPE. CULVERTS SHALL BE PLACED WITH A SLOPE OF 2 TO 4%. LOWER END SHALL BE AT LEAST 2" BELOW UPPER END.

EXTEND CULVERT 12" BEYOND BASE OF ROAD FILL ON BOTH SIDES. FIRMLY PACK FILL AROUND CULVERT, ESPECIALLY THE BOTTOM HALF.

PROVIDE SUITABLE OUTLET PROTECTION* AND, WHERE APPROPRIATE, INLET PROTECTION.

INSPECT CULVERT WEEKLY: REMOVE ANY FLOW OBSTRUCTIONS AND MAKE NECESSARY REPAIRS IMMEDIATELY.

THIS DETAIL MAY BE USED FOR DITCH RELIEF CULVERTS AND FOR CROSSINGS OF ROADSIDE DITCHES. IT IS NOT APPROPRIATE FOR STREAM CROSSINGS.

INSTALL ECDS AS NEEDED ON DIRT AT ENDS OF CULVERTS (MULCH OR BLANKET).

* FOR STEEP SLOPE (>2H:1V) OUTFALLS, A MINIMUM 20 FOOT LONG R-5 APRON IS RECOMMENDED FOR TEMPORARY ACCESS ROADS WHERE THE RECOMMENDED CULVERT SPACING IS USED. FOR PERMANENT ACCESS ROADS, A MINIMUM R-6 ROCK SIZE IS RECOMMENDED.





PL-MXP-100 & PL-MXP-200

STANDARD CONSTRUCTION DETAIL #3-10 DITCH RELIEF CULVERT

NO.	REVISION	APP'D	DATE	
A	ISSUED FOR FERC SUPPL FILING	SJ0	10/02/16	
A	ISSUED FOR 50% REVIEW	SJ0	05/09/16	
Æ	ISSUED FOR FERC FILING	SJO	04/29/16	E

П									
	DRAWN BY	PM	DATE 06/17/2015	SCALE: NTS					
	DRAFTING CHECK	TJ	07/25/2015	DRAWING NUMBER	SSUE				
	ENGINEERS REVIEW	SJO	07/30/2015	A6987-TYP-39	P5				






FIGURE NO. 23
TYPICAL NEWLY CONSTRUCTED ACCESS ROAD

	NO.	REVISION		DATE
0717	B	ISSUED FOR FERC SUPPL FILING	SJ0	10/02/16
200	æ	ISSUED FOR 50% REVIEW	SJO	05/09/16
101	Æ	ISSUED FOR FERC FILING	SJO	04/29/16

6	DRAWN BY	PM	DATE 06/17/2015	SCALE: NTS	
6	DRAFTING CHECK	TJ	09/22/2015	DRAWING NUMBER ISS	SUE
6	ENGINEERS REVIEW	SJO	09/22/2015	A6987-TYP-40 P	25

STABILIZED CONSTRUCTION ENTRANCE:

- USE TWO TO FOUR INCH (2-4") WASHED STONE LOW VOLUME ENTRANCES. STONE (4-6") FOR HEAVY USE OR MATERIAL DELIVERY ENTRANCES.
- 2. LENGTH IS AS REQUIRED, BUT NOT LESS THAN FIFTY (50') (EXCEPT ON SINGLE RESIDENCE LOT WHERE A THIRTY FOOT (30') MINIMUM LENGTH WOULD APPLY).
- 3. THICKNESS SHOULD NOT BE LESS THAN SIX INCHES (6").
- 4. THE WIDTH SHALL BE A MINIMUM OF TWENTY FEET (20') BUT NOT LESS THAN THE FULL WIDTH AT POINTS WHERE INGRESS OR EGRESS OCCURS.
- 5. GEOTEXTILE FABRICS SHALL BE PLACED OVER THE ENTIRE AREA PRIOR TO THE PACING OF STONE.
- 6. ALL SURFACE WATER FLOWING OR DIVERTED TOWARD CONSTRUCTION ENTRANCES SHALL BE PIPED ACROSS THE ENTRANCE. IF A CULVERT IS IMPRACTICAL, A MOUNTABLE BERM WITH 5:1 SLOPES SHALL BE USED.

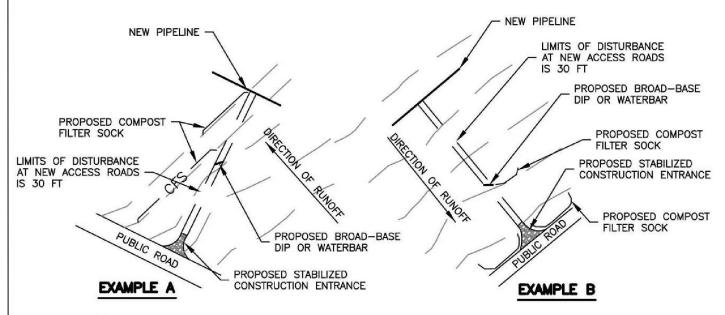

NOTES:


- 1. NO SILT FENCE REQUIRED IF CRITERIA FOR A NATURAL VEGETATIVE FILTER (BUFFER) STRIP IS MET AND LOCATED DOWN SLOPE OF CONSTRUCTION. THE VEGETATIVE FILTÉR (BUFFER) STRIP SHALL BE IN ACCORDANCE WITH VEGETATIVE FILTER (BUFFER) STRIP DETAIL.
- 2. REGULAR SILT FENCE WILL BE USED WHERE DRAINAGE AREA IS NO MORE THAN 1/4 ACRE PER 100' OF SILT FENCE AND THE MAXIMUM GRADIENT ABOVE FENCE IS 2:1. BELTED SILT RETENTION FENCE SHALL BE UTILIZED WHERE CONDITIONS EXCEED SILT FENCE REQUIREMENTS. SLOPE LENGTH ABOVE BELTED SILT RETENTION FENCE SHALL NOT EXCEED 400'.
- USE THIS DETAIL FOR ALL PROPOSED/NEW AND UPGRADED EXISTING ACCESS ROADS. NOT TO SCALE





Т	YPICAL A	FIGURE CCESS RO	NO. 24 DAD E&S CONTROL
2Δ\Λ/ΝΙ		DATE	

M	NO.	REVISION	APP'D	DATE	T
TITO L	Æ	ISSUED FOR FERC SUPPL FILING	SJ0	10/02/16	DRAWN BY
2010	A	ISSUED FOR 50% REVIEW	SJO	05/09/16	DRAFTING CHECK
27.137	Æ	ISSUED FOR FERC FILING	SJO	04/29/16	ENGINEERS REVIEW

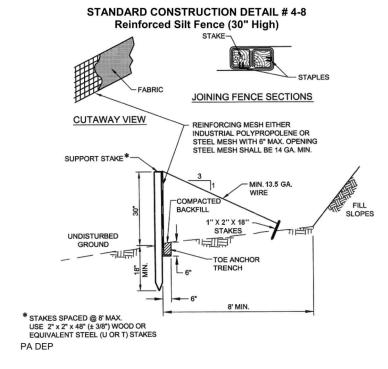

FABRIC SHALL HAVE THE MINIMUM PROPERTIES AS SHOWN IN TABLE 4.3.

FABRIC WIDTH SHALL BE 42" MINIMUM. STAKES SHALL BE HARDWOOD OR EQUIVALENT STEEL (U OR T) STAKES. AN 18" SUPPORT STAKE SHALL BE DRIVEN 12" MINIMUM INTO UNDISTURBED GROUND.

SILT FENCE SHALL BE INSTALLED AT EXISTING LEVEL GRADE. BOTH ENDS OF EACH FENCE SECTION SHALL BE EXTENDED AT LEAST 8 FEET UPSLOPE AT 45 DEGREES TO THE MAIN FENCE ALIGNMENT (FIGURE 4.1).

SEDIMENT SHALL BE REMOVED WHERE ACCUMULATIONS REACH HALF THE ABOVEGROUND HEIGHT OF THE FENCE.

ANY SECTION OF SILT FENCE WHICH HAS BEEN UNDERMINED OR TOPPED SHALL BE IMMEDIATELY REPLACED WITH A ROCK FILTER OUTLET (STANDARD CONSTRUCTION DETAIL #4.6).

FENCE SHALL BE REMOVED AND PROPERLY DISPOSED OF WHEN TRIBUTARY AREA IS PERMANENTLY STABILIZED.

*STAKES SPACED @ 8' MAX. USE 2"x2"x48" (± 3/8") WOOD OR EQUIVALENT STEEL (U OR T) STAKES





PL-MXP-100 & PL-MXP-200

STANDARD CONSTRUCTION DETAIL #4-8
REINFORCED SILT FENCE

				1
NO.	REVISION	APP'D	DATE	l
A	ISSUED FOR FERC SUPPL FILING	SJ0	10/02/16	B
A	ISSUED FOR 50% REVIEW	SJ0	05/09/16	DC
A3	ISSUED FOR FERC FILING	SJO	04/29/16	E

	DRAWN BY	PM	DATE 06/17/2015	SCALE: NTS	_
	DRAFTING CHECK	TJ	09/23/2015	DRAWING NUMBER IS	SSUE
3	ENGINEERS REVIEW	SJO	09/23/2015	A6987-TYP-42	P5

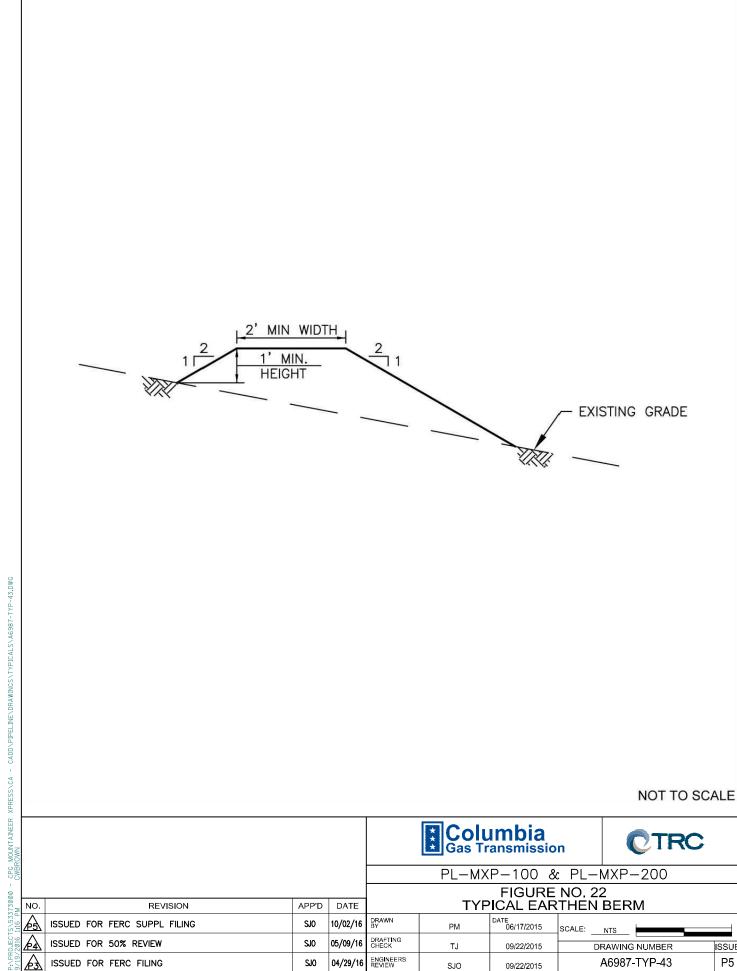






FIGURE NO. 22	
TYPICAL EARTHEN BE	RM

NO.	REVISION	APP'D	DATE	
Æ	ISSUED FOR FERC SUPPL FILING	SJ0	10/02/16	
æ	ISSUED FOR 50% REVIEW	SJO	05/09/16	
Æ	ISSUED FOR FERC FILING	SJO	04/29/16	

DRAWN BY	PM	DATE 06/17/2015	SCALE: NTS	ا Ŀ
DRAFTING CHECK	TJ	09/22/2015	DRAWING NUMBER ISS	UE
ENGINEERS REVIEW	SJO	09/22/2015	A6987-TYP-43 P	5

G_MOUNTAINEER XPRESS\CA - CADD\PIPELINE\DRAWINGS\TYPICALS\A6987-TYP-44.DWG

IDENTIFICATION MARKER PLACEMENT

THE ROW INSPECTOR WILL IDENTIFY ANY OF THE FOLLOWING LOCATIONS WITHOUT A REQUIRED IDENTIFICATION MARKER:

- BOTH SIDES OF HIGHWAY CROSSINGS
- BOTH SIDES OF COUNTY ROAD CROSSINGS
- BOTH SIDES OF RAILROAD CROSSINGS
- BOTH SIDES OF ASPHALT/GRAVEL ROAD CROSSINGS
- BOTH SIDES OF WATERWAYS
- BOTH SIDES OF ABOVEGROUND PIPE SECTIONS
- BOTH SIDES OF EXPOSED UNDERGROUND PIPE SECTIONS (A TWO-SIDED IDENTIFICATION MARKER MAY BE APPROPRIATE ON SHORT SECTIONS.)
- FENCE LINES
- LOCATIONS WHERE A PIPELINE ENTERS OR EXITS A PUMP, BOOSTER, OR VALVE STATION
- WHEN A PIPELINE IS IN SHARED ROW AND DOES NOT HAVE AN IDENTIFICATION MARKER AT EVERY MARKED LOCATION OF THE OTHER PIPELINE(S).

ALSO IDENTIFY ANY OF THE FOLLOWING AREAS WITH LESS THAN LINE—OF—SIGHT IDENTIFICATION MARKER PLACEMENT. THESE AREAS WILL BE EVALUATED TO DETERMINE WHETHER ADDITIONAL IDENTIFICATION MARKERS ARE NECESSARY TO INFORM THE PUBLIC AND/OR REDUCE THE HAZARDS OF THIRD PARTY DAMAGE.

- RESIDENTIAL AREAS
- COMMERCIAL AREAS
- INDUSTRIAL AREAS
- GRAVEL PITS
- STRIP MINES
- OTHER AREAS OF FREQUENT CONSTRUCTION OR EXCAVATION ACTIVITY






PL-MXP-100 & PL-MXP-200

PIPELINE STD PERMANENT LINE MARKER FOR ROADS, FENCES, FOREIGN LINE CROSSINGS, ETC.

NO.	REVISION	APP'D	DATE	
A	ISSUED FOR FERC SUPPL FILING	SJ0	10/02/16	ĺ
<u></u>	ISSUED FOR 50% REVIEW	SJ0	05/09/16	ĺ
A	ISSUED FOR FERC FILING	SJO	04/29/16	

		,	,			
6	DRAWN BY	РМ	DATE 06/17/2015	SCALE: NTS		
6	DRAFTING CHECK	TJ	09/22/2015	DRAWING NUMBER IS:	SUE	
6	ENGINEERS REVIEW	SJO	09/22/2015	A6987-TYP-44 F	25	

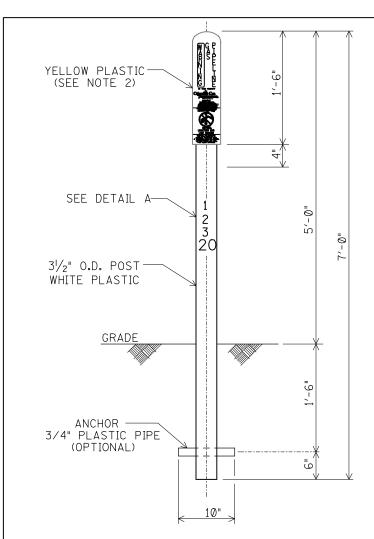

NOTE #6
COMPANY LOGO

SEE NOTE #3

Company Logo
In this vicinity

Company Logo
In this vicinity

Company Logo
In this vicinity


Company Cas
Interest Cas
Interest

OEP 150 05/01/2010

ROUND LINE MARKER

NOTES:

- 1. REFER TO TYPICAL TA-8646 FOR REQUIRED LOCATIONS.
- 2. WARNING MESSAGE SHOULD BE PERMANENTLY AFFIXED BY VENDOR.
- 3. MONITORING CENTER TOLL FREE NUMBER.
- 4. MARKER IS ALSO AVAILABLE AS:
 - A) VENT TOP (WITH OR WITHOUT TEST STATION)
 - B) TEST STATION
- 5. LETTER FOR "WARNING GAS PIPELINE" SHALL BE AT LEAST 1" TALL AND 1/4" STROKE IN ACCORDANCE WITH 192.707.
- 6. USE APPROVED COMPANY LOGO AS PER THE ACTUAL OPERATING COMPANY.
- 7. A WRAP AROUND STICKER IS ALSO AVAILABLE FOR OLDER TOPS THAT ARE ORANGE.

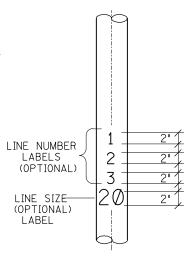

DETAIL A







TYPICAL
PERMANENT PIPELINE MARKER

				1
NO.	REVISION	APP'D	DATE	l
臽	ISSUED FOR FERC SUPPL FILING	SJ0	10/02/16	l
<u>A</u>	ISSUED FOR 50% REVIEW	SJ0	05/09/16	l
A3	ISSUED FOR FERC FILING	SJO	04/29/16	Ī

	1 - 1 (1717)			
DRAWN BY	PM	DATE 06/17/2015	SCALE: NTS	_
DRAFTING CHECK	TJ	09/22/2015	DRAWING NUMBER	SSUE
ENGINEERS REVIEW	SJO	09/22/2015	A6987-TYP-45	P5

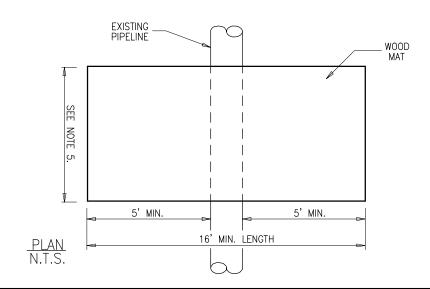

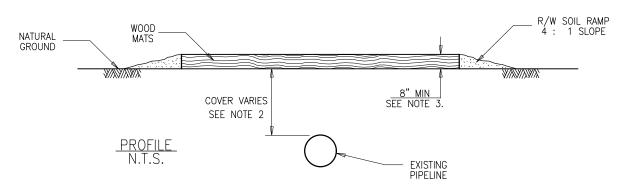

- 1. THE COMPANY REPRESENTATIVE SHALL BE NOTIFIED OF EACH PROPOSED CROSSING SO THAT THE EXISTING PIPELINE(S) CAN BE STAKED. CONTRACTOR SHALL VERIFY THE COVER DEPTH BY HAND EXCAVATING AT THE CROSSING LOCATION. THE PASSING OF EQUIPMENT OVER THE CROSSING WILL NOT BE MADE UNTIL IT HAS BEEN APPROVED BY THE COMPANY REPRESENTATIVE.


 2. IF COVER IS LESS THAN 2', OR WHEEL LOAD IS GREATER THAN 16000 LB/AXLE, ADDITIONAL COVER SHALL BE PLACED IN A TRAPEZOIDAL CONFIGURATION WITH THE BERM AT LEAST 10' WIDER THAN THE PROPOSED THE WORDS AND THE PROPOSED THE PROPO
- THE WIDTH OF THE EQUIPMENT CROSSING THE WOOD MATS OVER THE PIPELINE TO CREATE 3' OVER THE EXISTING PIPE.
- 3. THE WOOD MAT(S) OVER THE EXISTING LOADED PIPELINE SHALL BE COMPOSED OF TWO LAYERS OF THREE PLY MATS 8' WIDE X 16' LONG. THREE PLY MATS SHALL CONSIST OF THREE ALTERNATIING LAYERS OF 2" X 12" DIMENSIONAL LUMBER. THE TOP LAYER OF THE TOP MAT SHALL BE REPLACED WHEN DAMAGED AS DIRECTED BY COMPANY.
- 4. THE WOOD MAT SHALL EXTEND A MINIMUM OF 5' BEYOND THE OUTER EDGE OF THE PIPELINE THAT WILL BE
- 5. THE COMBINED WIDTHS OF THE WOOD MATS SHALL BE A MINIMUM OF 5' WIDER THAN THE WIDTH OF THE WEIGHT BEARING PORTION OF THE CONSTRUCTION EQUIPMENT. MULTIPLE MATS MAY BE REQUIRED.





EQUIPMENT CROSSING	
EXISTING LOADED PIPELINE	S

Σ	NO.	REVISION	APP'D	DATE		EXIST	ING LOAD	ED F	PIPELIN	NES	
1:19 P		ISSUED FOR FERC SUPPL FILING	SJ0	10/02/16	DRAWN BY	РМ	DATE 06/17/2015	SCALE:	NTS		
2016	A	ISSUED FOR 50% REVIEW	SJ0	05/09/16	DRAFTING CHECK	TJ	09/22/2015		DRAWING	NUMBER	ISSL
9/19/	Æ	ISSUED FOR FERC FILING	SJO	04/29/16	ENGINEERS REVIEW	SJO	09/22/2015		A6987-	-TYP-46	P5

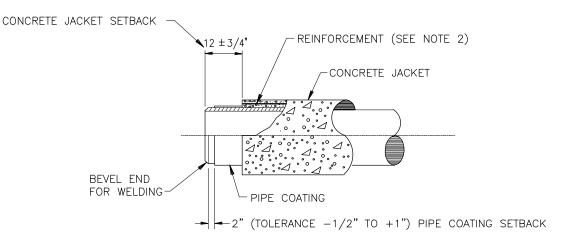

CONCRETE COATING END DETAIL

PIPE DIAMETER	WALL THICKNESS	CONCRETE THICKNESS		
26"	0.500"	3.0"		
20"	0.375"	2.5"		
20"	0.281"	3.0"		


- 1. CONCRETE COATING WITH COMPRESSIVE STRENGTH OF 2500 PSI TO BE INSTALLED OVER FBE COATED PIPE AT LOCATIONS INDICATED ON THE ALIGNMENT SHEETS.
- 2. REINFORCEMENT WILL CONSIST OF GALVANIZED 6"x6" 10 GAUGE WELDED WIRE MESH. CONCRETE SPACERS SHALL BE USED TO SUPPORT THE WIRE MESH 2" ABOVE THE PIPE. EDGE AND END LAPS SHALL BE A MINIMUM OF 12" AND TIED 12" O.C. STAGGERED.
- 3. THICKNESS OF CONCRETE SHALL HAVE A TOLERANCE OF -1/4" TO +1/2".
- 4. CONCRETE TO BE CURED TO 2500 PSI COMPRESSIVE STRENGTH BEFORE MOVING OR LOWERING THE PIPE IN THE DITCH.
- CONCRETE COATING OF FIELD JOINTS AND FACTORY FURNISHED ELLS IS NOT REQUIRED. FIELD BENDS WILL REQUIRE CONCRETE COATING.
- 6. CONTRACTOR SHALL FURNISH ALL CONCRETE COATING MATERIALS.







PI	PELINE S	TANDA	そ D
CONCRE	TE PROTI	ECTIVE	COATING

NO.	REVISION	APP'D	DATE	
A	ISSUED FOR FERC SUPPL FILING	SJ0	10/02/16	
A	ISSUED FOR 50% REVIEW	SJ0	05/09/16	
A3	ISSUED FOR FERC FILING	SJO	04/29/16	

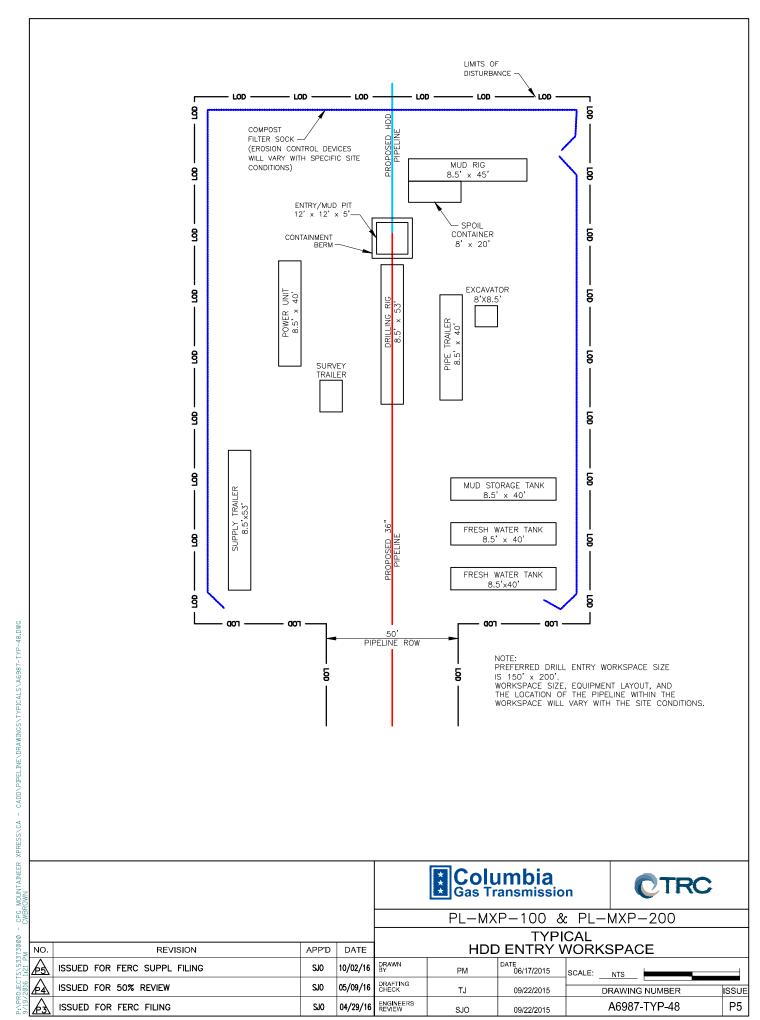


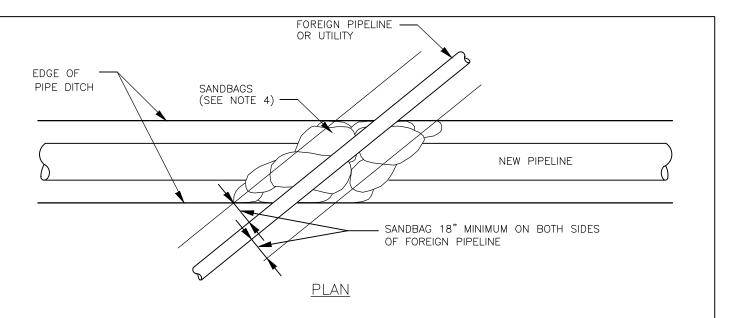

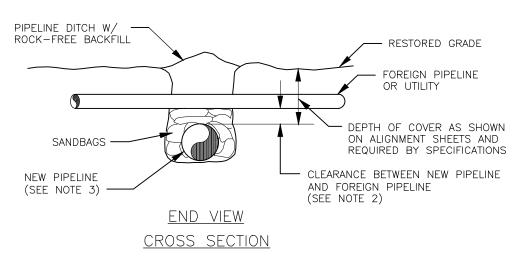

- 1. TYPE CP-2 CATHODIC PROTECTION TEST STATION SHALL BE INSTALLED AT FOREIGN PIPELINE CROSSINGS, WHEN INDICATED ON THE ALIGNMENT SHEETS.
- 2. MAINTAIN 2' MINIMUM CLEARANCE WHEN CROSSING OVER OR UNDER FOREIGN PIPELINES.
- 3. THE NEW PIPELINE IS TO BE PLACED ABOVE THE FOREIGN PIPELINE OR UTILITY IF IT IS BURIED AT A DEPTH SUCH THAT 2' SEPARATION AND MINIMUM REQUIRED COVER OF 36" CAN BE MAINTAINED. OTHERWISE, THE NEW PIPELINE IS TO BE PLACED UNDER THE FOREIGN PIPELINE OR UTILITY.
- 4. SANDBAGS CONSIST OF BURLAP BAGS FILLED WITH EARTH FREE OF SHARP ROCKS, TWIGS, AND OTHER OBJECTIONABLE MATERIALS (TOP SOIL SHALL NOT BE USED). USE OF SYNTHETIC MATERIALS FOR BAGS IS NOT ACCEPTABLE.

					Colu Gas Tr	ımbia ansmissio	n	CTRC	
					PL-MX	P-100 &	: PL-N	MXP-200	
			FOREIGN PIPELINE						
NO.	REVISION	APP'D	DATE	UTILITY CROSSING DETAIL					
Æ	ISSUED FOR FERC SUPPL FILING	SJO	10/02/16	DRAWN BY	PM	DATE 06/1 7/ 2015	SCALE:	NTS	
A	ISSUED FOR 50% REVIEW	SJO	05/09/16	DRAFTING CHECK	TJ	09/22/2015		RAWING NUMBER	ISSUE
A	ISSUED FOR FERC FILING	SJO	04/29/16	ENGINEERS REVIEW	SJO	09/22/2015	/	A6987-TYP-49	P5

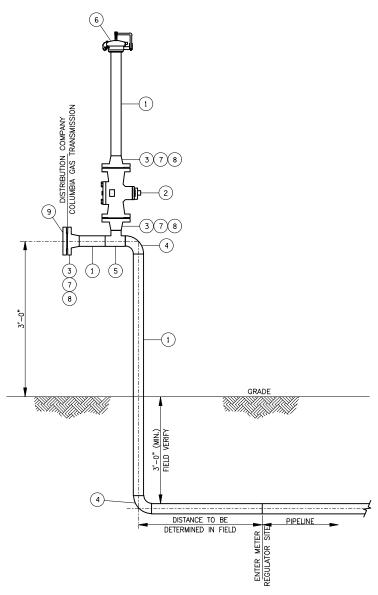

	MATERIAL LISTING						
ITEM	QTY	UNIT	SIZE	DESCRIPTION			
1	30	FT	2"	2%" O.D. STEEL LINE PIPE, O.218" W.T., GRADE X-42, SEAMLESS, PLAIN END, BEVELED FOR WELDING, BARE			
2	1	EA	2"	/E, PLUG, F.E., NORD, FIG. 2245, R.F.,1440#, C.S., LUB RP, 00, F/F = 11-1/2"			
3	3	EA	2"	NGE, WELD NECK, R.F., ANSI 600, F.S. BORED TO 0.218"			
4	2	EA	2"	L, WELDED, 90°, L.R., Y-52, 0.218" W.T.			
5	1	EA	2"	TEE, STRAIGHT, WELDED, Y-52, 0.218" W.T.			
6	1	EA	2"	LOSURE, YALE, FIGURE 500R, ANSI 600, 0.218" W.T., 1.939" BORE, HORIZONTAL			
7	24	EA	5/8"	BOLT, STUD, 5/8" DIA. x 4-1/4" LG., ASTM A-193, GR B7, THREADED ENTIRE LENGTH, WITH 2-2H NUTS			
8	3	EA	2"	GASKET, SPIRAL WOUND, ANSI 600, MFG. FLEXITALLIC, STYLE CGI, 316L/FLEXITE SUPER, $1/8$ " THK, ID = $2-3/4$ " x OD = $4-3/8$ "			
9	1	EA	2"	FLANGE, BLIND, R.F., ANSI 600			






ISSUE P5

HIGH PRESSURE
DOMESTIC METER

×	NO.	REVISION	APP'D	DATE			DOMESTIC	CME	TER_	
1123 F	Æ	ISSUED FOR FERC SUPPL FILING	SJ0	10/02/16	DRAWN BY	PD	DATE 01//2016	SCALE:	NTS	
2016	A	ISSUED FOR 50% REVIEW	SJ0	05/09/16	DRAFTING CHECK	TJ	//2016		DRAWING	NUMBER
9/19/	A	ISSUED FOR FERC FILING	SJO	04/29/16	ENGINEERS REVIEW		//2016		A6987-	-TYP-50

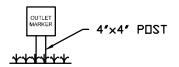

PROJECT NAME

REGISTRATION NO.

OUTLET NO.

NOTES:

- 1. THE SIGN WILL BE AT LEAST 24" X 24".
- 2. THE LETTERS WILL BE 1.6" AND 0.8" IN TEXT HEIGHT.






PL-MXP-100 & PL-MXP-200

TYPICAL OUTLET MARKER

						117	ICAL OUT	
Σ	NO.	REVISION	APP'D	DATE				
1126	A	ISSUED FOR FERC SUPPL FILING	SJ0	10/02/16	DRAWN BY	TBH	DATE 03/16/2016	SCALE: NTS
2010		ISSUED FOR 50% REVIEW	SJO	05/09/16	DRAFTING CHECK	PAD	03/21/2016	DRAWING NUMBER ISSUE
61/6	A	ISSUED FOR FERC FILING	SJO	04/29/16	ENGINEERS REVIEW	SJO	03/21/2016	A6987-TYP-51 P3

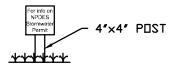

For info on NPDES Stormwater Permit

To Comment on Sediment Control Plan

Call: 800-654-5227 OR

<u>DEP.Plan@wv.gov</u> DEP 601 57th Street SE, Charleston, WV 25304

Application Date: XX/XX/XX Name of Project, **Project Description**

(area code) Tele. No.

NOTES:

- 1. THE SIGN WILL BE AT LEAST 24" X 24".
- 2. THE LETTERS WILL BE 1.6" AND 0.8" IN TEXT HEIGHT.






PL-MXP-100 & PL-MXP-200

TYPICAL PUBLIC NOTICE/ENTRANCE SIGN

NO.	REVISION	APP'D	DATE
A	ISSUED FOR FERC SUPPL FILING	SJ0	10/02/16
A	ISSUED FOR 50% REVIEW	SJ0	05/09/16
A	ISSUED FOR FERC FILING	SJO	04/29/16

DRAWN BY	TBH	DATE 03/16/2016	SCALE: NTS	
DRAFTING CHECK	PAD	03/21/2016	DRAWING NUMBER	ISSUE
ENGINEERS REVIEW	SJO	03/21/2016	A6987-TYP-52	РЗ

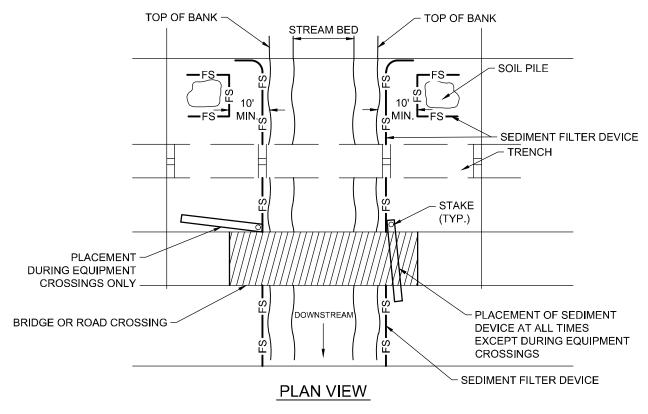

- SEDIMENT FILTER DEVICE (COMPOST FILTER SOCK, SILT FENCE, OR OTHER APPROVED EQUIVALENT), SHALL BE INSPECTED WEEKLY AND AFTER EACH RUNOFF EVENT. DAMAGED SEDIMENT FILTER DEVICE SHALL BE REPAIRED ACCORDING TO MANUFACTURER'S SPECIFICATIONS.
- SEDIMENT FILTER DEVICE AT ENTRANCES SHALL BE IN PLACE FROM START OF DAY, DURING CONSTRUCTION ACTIVITIES AND AT END OF DAY. SEDIMENT FILTER DEVICE MAY BE TEMPORARILY MOVED AS SHOWN ON THE LEFT DURING EQUIPMENT CROSSING ACTIVITIES BUT MUST BE REPLACED IMMEDIATELY UPON COMPLETION OF CROSSING.
- COMPOST FILTER SOCK TO BE FILTREXX SILTSOXX OR APPROVED EQUIVALENT.





PL-MXP-100 & PL-MXP-200

TYPICAL REMOVABLE SEDIMENT FILTER DEVICE

NO.	REVISION	APP'D	DATE	
B	ISSUED FOR FERC SUPPL FILING	SJ0	10/02/16	
A	ISSUED FOR 50% REVIEW	SJ0	05/09/16	
函	ISSUED FOR FERC FILING	SJO	04/29/16	-


DRAWN BY	TBH	DATE 03/16/2016	03/16/2016 SCALE: <u>NTS</u> 03/21/2016 DRAWING			
DRAFTING						
CHECK	PAD	03/21/2016		DRAWING	NUMBER	ISSUE
ENGINEERS REVIEW	SJO	03/21/2016		A6987	TYP-53	РЗ

CADD\PIPELINE\DRAWINGS\TYPICALS\A6987-TYP-54.DWG

CPG MOUNTAINEER

- 1. IF GAS PIPELINE IS IN NEED OF REPAIR OR REPLACEMENT, EXISTING PIPE CROSSING MUST BE CUT/CAPPED AND GROUTED AND A NEW PIPELINE MUST BE INSTALLED IN A NEW LOCATION. (NO SAME DITCH REPLACEMENT)
- 2. STONE TO MEET REQUIREMENTS OF WVDOT, SECTION 307 CLASS I.
- 3. CONCRETE FLOWABLE FILL MIX TO BE 1000 PSI MINIMUM.

SHEET 1 OF 2

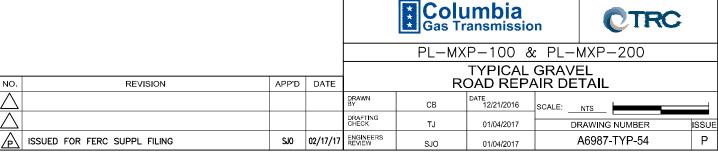

Columbia

	Flo	wable Fill Mi	x Specificatio	on for Pipelines			
	Materials to Produce One Cubic Yard of Mix						
Material	Туре	SSD (lbs/vd)	Volume (%)	Abs. Vol. (ft ³)	ASTM	Sp. Gr.	
Cement	1/11	85	1.5	0.43	C150	3.15	
Fine Aggregate	Α	2423	55	14.82	C33	2.62	
Water	Potable	312	18.5	5		1.00	
Air	*Master Cell 25	N/A	25	6.75	C260	1.01	
Total Weigh	t	2820 lbs/yd ³					
Unit Weight		104.4 lbs/ft ³					
Total Volum	e			27.00 ft ³			

*USE BASE CORP. MASTER BUILDERS MASTER CELL 25 OR EQUIVALENT TO PRODUCE 25% AIR VOLUME IN THE MIX. MASTER CELL 25 MUST BE USED IN ACCORDANCE WITH MANUFACTURER'S GUIDELINES.

- MASTER CELL 25 IS TO BE ADDED AT THE JOB SITE ONLY.
 MIX RATE FOR MASTER CELL 25 IS 18.80 OZ/CWT OF CEMENT.
 MIX AT HIGH RPM MIXING SPEED FOR AT LEAST 10-12 MINUTES.


SHEET 2 OF 2





TYPICAL	GRAVEL	ROAD	REPAIR	DETAIL

NO.	REVISION	APP'D	DATE							
\triangle				DRAWN BY	CWB	DATE 12/21/2016	SCALE:	NTS		
\triangle				DRAFTING CHECK	TJ	01/04/2017			NUMBER	ISSUE
	ISSUED FOR FERC SUPPL FILING	SJ0	02/17/17	ENGINEERS REVIEW	SJO	01/04/2017		A6987-	-TYP-54	Р

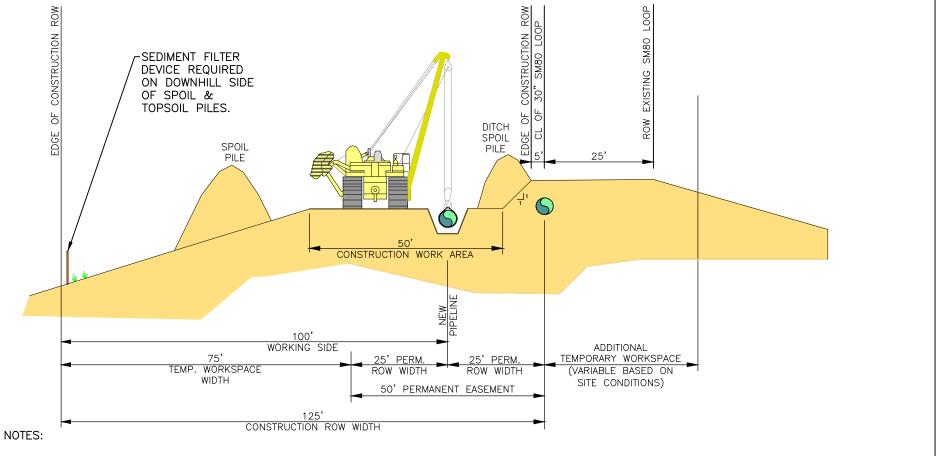

- 1. TOPSOIL AND SUBSOIL PILES WILL BE ADEQUATELY PROTECTED FROM EROSION AND SEDIMENTATION BY USE OF A SEDIMENT FILTER DEVICE, MULCH, TEMPORARY SEEDING, TACKIFIERS, OR FUNCTIONAL EQUIVALENT.
- 2. STRIP TOPSOIL IN ACCORDANCE WITH THE ECS AND LANDOWNER/LAND MANAGING AGENCY AGREEMENTS.
- 3. RESTORE CUT SLOPE USING NATIVE MATERIAL OR SUITABLE MATERIAL IN ACCORDANCE WITH COLUMBIA SPECIFICATIONS WHERE NATIVE MATERIAL HAS BEEN DETERMINED TO BE INAPPROPRIATE. DISPOSE OF ANY EXCESS MATERIAL IN ACCORDANCE WITH APPLICABLE LANDOWNER AND PERMIT CONDITIONS.
- 4. ON STEEP SIDE SLOPES CENTERLINE OF PIPE MAY BE ADJUSTED WITHIN PERM. ROW TO MEET FIELD CONDITIONS.

					Colu Gas Tr	ımbia ransmissio	n	CTRC	•
				PL-MXP-100					
				TYPICAL SM-80 LOOP PARALLEL					
NO.	REVISION	APP'D	DATE			ON SIDE	SLOPE		
\triangle				DRAWN BY	PM	DATE 12/16/16	SCALE: NTS		
\triangle				DRAFTING CHECK	TJ	12/16/16	DRAW	/ING NUMBER	ISSUE
ISSUED FOR FERC	SUPPL FILING	SJ0	02/17/17	ENGINEERS REVIEW	SO	12/16/16	A69	87-TYP-55	Р